

NOTICE OF PROPOSED DEVELOPMENT

Notice is hereby given that an application has been made for planning approval for the following development:

SITE:

3 SPOONBILL LOOP, SORELL

PROPOSED DEVELOPMENT:

DWELLING

The relevant plans and documents can be inspected at the Council Offices at 47 Cole Street, Sorell during normal office hours, or the plans may be viewed on Council's website at www.sorell.tas.gov.au until Monday 8th December 2025.

Any person may make representation in relation to the proposal by letter or electronic mail (<u>sorell.council@sorell.tas.gov.au</u>) addressed to the General Manager. Representations must be received no later than **Monday 8th December 2025**.

APPLICATION NO: 5.2025-311.1

DATE: 21 NOVEMBER 2025

Part B: Please note that Part B of this form is publicly exhibited.

Full description of Proposal:	Use:						
·	Development:						
Large or complex proposals should be described in a letter or planning report.							
	Large or complex proposals s	Todia be	. acseribea	material planning report.			
Design and con	struction cost of proposal:		\$				
Is all, or some th	ne work already constructed	:	No: □	Yes: □			
Location of proposed	Street address:						
works:	Suburb:		Posto	code:			
	Certificate of Title(s) Volume: Folio:						
Current Use of Site							
Current Owner/s:	Name(s)						
		1					
Is the Property of Register?	on the Tasmanian Heritage	No: □	Yes: □	If yes, please provide written advice from Heritage Tasmania			
Is the proposal than one stage?	to be carried out in more	No: □	Yes: □	If yes, please clearly describe in plans			
Have any poten been undertake	tially contaminating uses n on the site?	No: □	Yes: □	If yes, please complete the Additional Information for Non-Residential Use			
Is any vegetation proposed to be removed?			Yes: □	If yes, please ensure plans clearly show area to be impacted			
Does the propose administered or or Council?	sal involve land owned by either the Crown	No: □	Yes: □	If yes, please complete the Council or Crown land section on page 3			
, ,	ded vehicular crossing is requi			• • •			
•	hicular Crossing (and Associa			cation form			
TILLPS://www.SO	rell.tas.gov.au/services/engir	icering/		SORELL			

Sorell Council

Development Application: Development Application - 3 Spoonbill Loop, Sorell.pdf

Plans Reference: P1 Date Received: 10/11/2025

Declarations and acknowledgements

- I/we confirm that the application does not contradict any easement, covenant or restriction specified in the Certificate of Title, Schedule of Easements or Part 5 Agreement for the land.
- I/we consent to Council employees or consultants entering the site and have arranged permission and/or access for Council's representatives to enter the land at any time during normal business hours.
- I/we authorise the provision of a copy of any documents relating to this application to any person for the purposes of assessment or public consultation and have permission of the copyright owner for such copies.
- I/we declare that, in accordance with s52(1) of the Land Use Planning and Approvals Act 1993, that I have notified the owner(s) of the intention to make this application.
- I/we declare that the information in this application is true and correct.

Details of how the Council manages personal information and how you can request access or corrections to it is outlined in Council's Privacy Policy available on the Council website.

- I/we acknowledge that the documentation submitted in support of my application will become a public record held by Council and may be reproduced by Council in both electronic and hard copy format in order to facilitate the assessment process, for display purposes during public exhibition, and to fulfil its statutory obligations. I further acknowledge that following determination of my application, Council will store documentation relating to my application in electronic format only.
- Where the General Manager's consent is also required under s.14 of the *Urban Drainage Act 2013*, by making this application I/we also apply for that consent.

Applicant Signature:	Signature: Lutzia Brown Date:
----------------------	-------------------------------

Crown or General Manager Land Owner Consent

If the land that is the subject of this application is owned or administered by either the Crown or Sorell Council, the consent of the relevant Minister or the Council General Manager whichever is applicable, must be included here. This consent should be completed and signed by either the General Manager, the Minister, or a delegate (as specified in s52 (1D-1G) of the Land Use Planning and Approvals Act 1993).

Please note:

- If General Manager consent if required, please first complete the General Manager consent application form available on our website www.sorell.tas.gov.au
- If the application involves Crown land you will also need a letter of consent.
- Any consent is for the purposes of making this application only and is not consent to undertaken work or take any other action with respect to the proposed use or development.

I		being responsible for the
administration of land at		Sorell Council
declare that I have given permiss	sion for the making of this application for	Development Application: Development Application - 3 Spoonbill Loop, Sorell.pdf
		Plans Reference: P1 Date Received: 10/11/2025
Signature of General Manager, Minister or Delegate:	Signature:	Date:



RESULT OF SEARCH

RECORDER OF TITLES





SEARCH OF TORRENS TITLE

VOLUME	FOLIO
186811	2
EDITION 2	DATE OF ISSUE 03-Nov-2025

SEARCH DATE: 10-Nov-2025 SEARCH TIME: 03.36 PM

DESCRIPTION OF LAND

Town of SORELL

Lot 2 on Sealed Plan 186811

Derivation: Part of 244 Acres Granted to T. Giblin & J. Lord

Prior CTs 9892/103 and 9892/104

SCHEDULE 1

N280332 TRANSFER to AMBER LOUISE GADD and ADRIAN JOHN BUTTERWORTH Registered 03-Nov-2025 at noon

SCHEDULE 2

Reservations and conditions in the Crown Grant if any SP186811 COVENANTS in Schedule of Easements SP186811 FENCING COVENANT in Schedule of Easements SP 9892 FENCING PROVISION in Schedule of Easements INSTRUMENT Creating Restrictive Covenants Registered E428678 03-Nov-2025 at 12.01 PM MORTGAGE to Commonwealth Bank of Australia E432561 Registered 03-Nov-2025 at 12.02 PM

UNREGISTERED DEALINGS AND NOTATIONS

No unregistered dealings or other notations



Development Application: Development Application - 3 Spoonbill Loop, Sorell.pdf

Plans Reference: P1




FOLIO PLAN

RECORDER OF TITLES



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Search Date: 19 Aug 2025

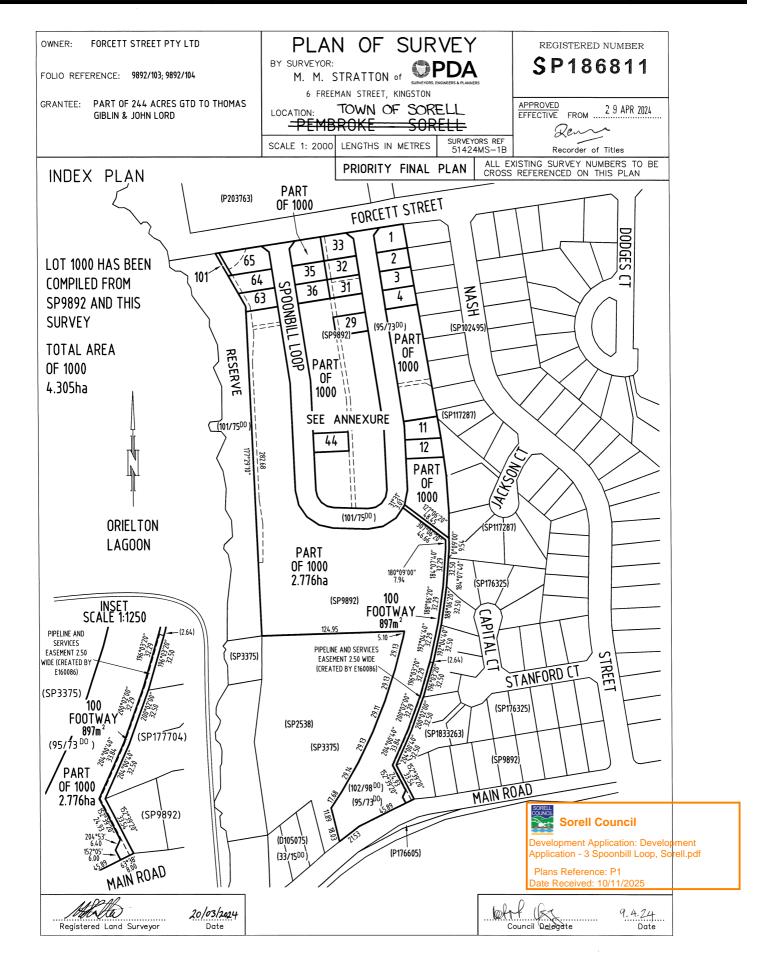Search Time: 02:25 PM

Volume Number: 186811

Revision Number: 01

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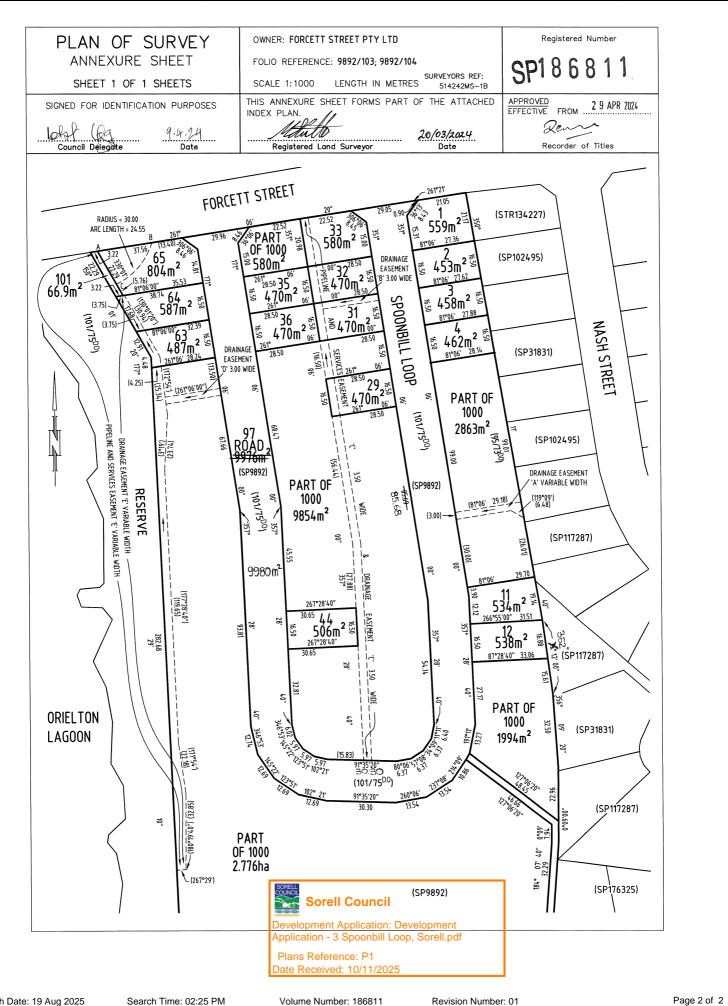


FOLIO PLAN

RECORDER OF TITLES



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RECORDER OF TITLES

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SCHEDULE OF EASEMENTS

NOTE: THE SCHEDULE MUST BE SIGNED BY THE OWNERS

& MORTGAGEES OF THE LAND AFFECTED.

SIGNATURES MUST BE ATTESTED.

Registered Number

SP 186811

PAGE 1 OF A PAGES

EASEMENTS AND PROFITS

Each lot on the plan is together with:-

(1) such rights of drainage over the drainage easements shown on the plan (if any) as may be necessary to drain the stormwater and other surplus water from such lot; and

Development Application: Development

Application - 3 Spoonbill Loop, Sorell.pdf

(2) any easements or profits a prendre described hereunder.

Each lot on the plan is subject to:-

(1) such rights of drainage over the drainage easements shown on the plan (if any) as passing through such lot as may be necessary to drain the stormwater and other surplus water from any other lot on the plan; and

(2) any easements or profits a prendre described hereunder.

The direction of the flow of water through the drainage easements shown on the plan is indicated by arrows.

Taswater

Lots 29, 31, 32, 33 & 1000 are subject to a Pipeline & Services Easement in gross in favour of the Tasmanian Water and Sewerage Corporation Pty Ltd, its successors and assigns ("TasWater") over the land marked "PIPELINE AND SERVICES EASEMENT 'C' 3.50 WIDE & DRAINAGE EASEMENT 'C' 3.50 WIDE" as shown on the plan ("the Easement Land").

Lots 63, 64, 101 & 1000 are subject to a Pipeline & Services Easement in gross in favour of the Tasmanian Water and Sewerage Corporation Pty Ltd, its successors and assigns ("TasWater") over the land marked "PIPELINE AND SERVICES EASEMENT `E' VARIABLE WIDTH" as shown on the plan ("the Easement Land").

Lot 100 is subject to a Pipeline & Services Easement in gross in favour of the Tasmanian Water and Sewerage Corporation Pty Ltd, its successors and assigns ("TasWater") over the land marked "PIPELINE AND SERVICES EASEMENT 2.50 WIDE (CREATED BY E160086)" as shown on the plan ("the Easement Land").

Drainage

Lot 31 is subject to a Right of Drainage in gross in favour of the Sorell Council over the land marked "DRAINAGE EASEMENT 'B' 3.00 WIDE" as shown on the plan ("the Easement Land").

Lots 29, 31, 32, 33 & 1000 are subject to a Right of Drainage in gross in favour of the Sorell Council over the land marked "PIPELINE AND SERVICES EASEMENT 'C' 3.50 WIDE & DRAINAGE EASEMENT 'C' 3.50 WIDE" as shown on the plan ("the Easement Land").

Lot 1000 is subject to a Right of Drainage in gross in favour of the Sorell Council over the land marked DRAINAGE EASEMENT 'A' VARIABLE WIDTH" as shown on the plan ("the Easement Land").

(USE ANNEXURE PAGES FOR CONTINUATION)

SUBDIVIDER: FORCETT STREET PTY LTD

FOLIO REF: 9892/103 &104 SOLICITOR & REFERENCE:

Butler McIntyre & Butler (JS:233282)

PLAN SEALED BY: SORELL COUNCIL

Revision Number: 01

DATE: 9.4.24

SA 2020/00006 - 1

REF NO. 7 2020-24.

Council Delegate

NOTE: The Council Delegate must sign the Certificate for the purposes of identification.

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ANNEXURE TO SCHEDULE OF EASEMENTS

PAGE 2 OF 4 PAGES

Registered Number

SP 18681

SUBDIVIDER: FORCETT STREET PTY LTD FOLIO REFERENCE: 9892/103 &104

Lot 1000 is subject to a Right of Drainage in gross in favour of the Sorell Council over the land marked DRAINAGE EASEMENT 'D' 3.00 WIDE" as shown on the plan ("the Easement Land").

Lots 63, 64 & 1000 are subject to a Right of Drainage in gross in favour of the Sorell Council over the land marked "DRAINAGE EASEMENT 'E' VARIABLE WIDTH" as shown on the plan ("the Easement Land").

FENCING PROVISION COVENANT

With

In respect to the lots on the plan, the owners of each lot on the plan covenants, the vendor (FORCETT STREET PTY LTD) that the vendor shall not be required to fence.

COVENANTS

Water tank

The owners of all lots on the Plan covenants in gross with the Sorell Council to the intent that the burden of these covenants may run with and bind the covenantor's lot and each and every part of it and that the benefit of these covenants shall be annexed to and devolve with Sorell Council to observe the following stipulation:

- not to construct on a lot a dwelling without :
- i) A minimum 5,000 litre rain water tank fitted to collect all roof runoff; and
- ii) Such tank shall be installed with minimum retention storage of 2000 litres and be plumbed into toilets so that re-use occurs, with top up from the reticulated water supply.

Odour buffer

The owner of lot 65 on the Plan covenants in gross with the Sorell Council to the intent that the burden of these covenants may run with and bind the covenantor's lot and each and every part of it and that the benefit of these covenants shall be annexed to and devolve with Sorell Council to observe the following stipulation:

- Not to construct, or allow to be constructed, any habitable room within a dwelling within the area marked A B C on the plan.

Definitions;

Director: ...!...!

"Pipeline and Services Easement" means-

FIRSTLY, THE FULL AND FREE RIGHT AND LIBERTY for TasWater and its employees, contractors, agents and all other persons duly authorised by it, at all times to:

- enter and remain upon the Easement Land with or without machinery, vehicles, plant and equipment;
- investigate, take soil, rock and other samples, survey, open and break up and excavate the Easement Land for any purpose or activity that TasWater is authorised to do or undertake;
- install, retain, operate, modify, relocate, maintain, inspect, cleanse, repair, remove and replace the Infrastructure;
- run and pass sewage, water and electricity through and along the Infrastructure;
- (5) do all works reasonably required in connection with such activities or as may be authorised or required by any law:
 - (a) without doing unnecessary damage to the Easement Land; and (b) leaving the Easement Land in a clean and tidy condition;

COUNCIL

Sorell Council

Development Application: Development Application - 3 Spoonbill Loop, Sorell.pdf

Plans Reference: P1 Date Received: 10/11/2025

NOTE: Every annexed page must be signed by the parties to the dealing or where the party is a corporate body be signed by the persons who have attested the affixing of the seal of that body to the dealing.

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ANNEXURE TO SCHEDULE OF EASEMENTS

PAGE 3 OF 4 PAGES

SP 18681

Registered Number

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- (6) if the Easement Land is not directly accessible from a highway, then for the purpose of undertaking any of the preceding activities TasWater may with or without employees, contractors, agents and any other persons authorised by it, and with or without machinery, vehicles, plant and equipment enter the Lot from the highway at any vehicle entry and cross the Lot to the Easement Land; and
- (7) use the Easement Land as a right of carriageway for the purpose of undertaking any of the preceding purposes on other land, TasWater reinstating any damage that it causes in doing so to any boundary fence of the Lot.

SECONDLY, the benefit of a covenant in gross for TasWater with the registered proprietor/s of the Easement Land and their successors and assigns not to erect any building, or place any structures, objects, vegetation, or remove any thing that supports, protects or covers any Infrastructure on or in the Easement Land, without the prior written consent of TasWater to the intent that the burden of the covenant may run with and bind the servient land and every part thereof and that the benefit thereof may be annexed to the easement herein described.

"Infrastructure" means infrastructure owned or for which TasWater is responsible and includes but is not limited to:

- (a) sewer pipes and water pipes and associated valves;
- (b) telemetry and monitoring devices;
- (c) inspection and access pits;
- (d) electricity assets and other conducting media (excluding telemetry and monitoring devices);
- (e) markers or signs indicating the location of the Easement Land or any other Infrastructure or any warnings or restrictions with respect to the Easement Land or any other Infrastructure;
- (f) anything reasonably required to support, protect or cover any other Infrastructure;
- (g) any other infrastructure whether of a similar nature or not to the preceding which is reasonably required for the piping of sewage or water, or the running of electricity, through the Easement Land or monitoring or managing that activity; and
- (h) where the context permits, any part of the Infrastructure.

"Right of Drainage" means a right of drainage as defined within Schedule 8 of the Conveyancing and Law of Property Act 1884 (Tas).

SORELL

Sorell Council

Development Application: Development Application - 3 Spoonbill Loop, Sorell.pdf

Plans Reference: P1 Date Received: 10/11/2025

Director: Illu lu

Director: (Ray acker

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ANNEXURE TO SCHEDULE OF EASEMENTS

PAGE 4 OF 4 PAGES

SUBDIVIDER: FORCETT STREET PTY LTD FOLIO REFERENCE: 9892/103 &104

SP 18 6 8 1

EXECUTED by FORCETT STREET PTY LTD (ACN 634

863 479) pursuant to section 127(1) of the Corporations Act

2001 (Cth) by:

Director Signature

Director/ Secretary Signature

Director Full Name (print)

PETR KRIZ

Director/ Secretary Full Name

DEAN MURRAY COCKER



Development Application: Development Application - 3 Spoonbill Loop, Sorell.pdf

Plans Reference: P1 Date Received: 10/11/2025

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Spoonbill Loop Subdivision Sorell

FLOOD HAZARD REPORT

FE_24028 **09**th May **2024**



Development Application: Development Application - 3 Spoonbill Loop, Sorell.pdf

Plans Reference: P1 Date Received: 10/11/2025



L4/ 116 BATHURST ST HOBART TASMANIA 7000 ABN: 16 639 276 181

Document Information

Title	Client	Document Number	Project Manager
Spoonbill Loop Subdivision, Sorell, Flood Hazard Report	JAC Estate Pty Ltd	FE_24028	Max W. Möller Principal Hydraulic Engineer

Document Initial Revision

REVISION 00	Staff Name	Signature	Date
Prepared by	Max W. Moller Principal Hydraulic Engineer	Apro Miller	25/04/2024
Prepared by	Ash Perera Hydraulic Engineer	AF.	25/04/2024
Prepared by	Christine Keane Senior Water Resources Analyst	Charlesleer	25/04/2024
GIS Mapping	Damon Heather GIS Specialist	4	26/04/2024
Reviewed by	John Holmes Senior Engineer	goe-e	29/04/2024
Reviewed by	Max W. Möller Principal Hydraulic Engineer	Agaso Miller	07/05/2024
Authorised by	Max W. Moller Principal Hydraulic Engineer	Apo Miller	08/05/2024

Rev No.	Description	Prepared by	Authorised by	Date	
00	Draft for client's review	MM	MM	09.05.2024	
01	Final Issue	ММ	ММ	09.05.2024	

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1. Introduction

Flüssig Engineers has been commissioned by JAC Estates Pty Ltd to conduct a detailed Flood Hazard Report tailored to the Spoonbill Loop Subdivision project in Sorell, situated within the jurisdiction of the Sorell Council municipality.

The primary objective of this report is to meticulously assess the flood dynamics within the existing landscape post-development, particularly under the 1% Annual Exceedance Probability (AEP) compounded with climate change conditions. Additionally, it aims to ascertain the minimum required finished floor level permissible for any potential future dwellings located within lots affected by the flood extent within the potential building envelopes.

1.1 Development

The current subdivision development encompasses a total of 65 residential lots, collectively spanning an area of approximately 45,000 square meters positioned between Nash Street and the Orielton Lagoon in Sorell. Presently, each of the lots remains unoccupied.

1.2 Objectives and Scope

This report is to assess the existing development at Spoonbill Loop Subdivision. The objectives of this study are:

- Conduct an evaluation of the flood attributes of the site considering the combined 1% Annual Exceedance Probability (AEP) along with climate change (CC) scenarios.
- Furnish the findings pertaining to flooding concerning the current state of the subdivision development.
- Offer flood mitigation suggestions tailored for potential future development of individual lots, where deemed suitable. Provide an assessment of the site's flood characteristics under the combined 1% AEP plus climate change (CC) scenario.

1.3 Limitations

This study is limited to the objectives of the engagement by the clients, the availability and reliability of data, and including the following:

- The flood model is limited to a 1% AEP + CC worst case temporal design storm.
- All parameters have been derived from best practice manuals and available relevant studies (if applicable) in the area.
- All provided data by the client or government bodies for the purpose of this study is deemed fit for purpose and has not been checked for accuracy.
- The study is to determine the effects of the existing development on flooding behaviour and should not be used as a full flood study outside the specified area without further assessment.



2. Model Build

2.1 Overview of Catchment

The contributing catchment for Spoonbill Loop Subdivision, Sorell is approximately 35 ha stretching from the Sorell School on Main Road to the east towards the subdivision site with an average slope of 1.5 %.

The land use of the catchment is General Residential and Community Purpose with the specific site being listed as General Residential.

Figure 1 below outlines the approximate contributing catchment for the site at Spoonbill Loop Subdivision, Sorell.



Figure 1. Contributing Catchment, Spoonbill Loop Subdivision, Sorell

2.2 Hydrology

The following Table 1 states the adopted hydrological parameters for the RAFTS catchment, as per best practice guidelines.

Table 1. Parameters for RAFTS catchment

Catchment	Initial Loss	Continuing Loss	Manning's N	Manning's N	Non-linearity	
Area (ha)	Perv/imp (mm)	Perv/imp (mm/hr)	pervious	impervious	factor	
35	27/1	4.0/0.0	0.045	0.02	-0.285	



Design Rainfall EventsFigure 2 shows the box and whisker output of the model run. The model shows that the 1% AEP 10 minute storm temporal pattern 9 was the worst-case median storm. Therefore, this storm event was used within the hydraulic model.

Figure 2. 1% AEP Flood Event Model, Box and Whisker Plot

2.2.1 Climate Change

As per ARR 2019 Guidelines, for an increase in rainfall due to climate change at 2100, it is recommended the use of RCP 8.5. However, ARR 2019 recommends that this figure be used in lieu of more local data being available.

The base scenario of the Climate Futures Tasmania (2010) study was revised following the ARR 2019 Australasia Climate Change study (undertaken by the University of Tasmania), resulting in the original increase in rainfall being reduced to 14.6% in cooler climates (Southern Tasmania). Table 2 shows the ARR 8.5 increase of 16.3% that has been adopted by Sorell Council and therefore used within the model.

Table 2. Climate Change Increases

Catchment	CFT increase @ 2100	ARR 8.5 increase @ 2100	
South East Tasmania	14.6%	16.3%	

2.2.2 Calibration/Validation

This immediate catchment has no stream gauge to calibrate the model against a real-world storm event. Similarly, there is little historical information available, and limited available past flood analysis undertaken to validate against the flows obtained in the model. A Regional Flood Frequency Estimation model (RFFE) has been used to calibrate our rain on grid rainfall estimation. The RFFE values are listed in Table 3 below.

Table 3. Regional Flood Frequency Estimation model (RFFE) v/s Flussig Result.

AEP (%)	Discharge (m³/s)	Lower Confidence Limit (5%) (m³/s)	Upper Confidence Limit (95%) (m³/s)	Flussig Discharge (m³/s)	
50	0.140	0.0500	0.350	0.251	
20	0.250	0.100	0.610	0.374	
10	0.340	0.130	0.900	0.404	
5	0.450	0.150	1.32	0.488	
2	0.610	0.170	2.11	0.657	
1	0.760	0.180	2.95	0.780	

2.3 Hydraulics

2.3.1 Survey

The 2D surface model was taken from a combination of GreaterHobart-LiDAR2013-DEM-GRID-(Geoscience Australia) and the "As Constructed" 3D mesh TIN, to create a 1m and 0.1m cell size DEM. For the purposes of this report, 0.1m cells are enough to capture accurate flow paths. The DEM with hill shading can be seen below in Figure 3.

Hydraulic structures are included as either 1D or 2D structures throughout the model, where 1D structures exists a 1D/2D link is provided to allow flow to transition to and from the 2D surface.





Figure 3. 1.0m and 0.1m Combined DEM (hill shade) of subdivision

2.3.2 Pipes and pits

Pipes and pits were modelled as 1D underground network within the catchment model included the outfall discharge at the treatment area and ultimate to the Orielton Lagune. Pipe and pit data was supplied by the client for inclusion in the model. Underground pipes were connected via 1D/2D connected pits. Pits adopted an inlet flow limitation based off a double grated pit depth/flow curve.

2.3.3 Key Stormwater Assets

Key infrastructure elements on the site consist of an established levee system, which has been incorporated into the model, utilises a modelled Digital Elevation Model (DEM) with the integration of the concrete trench in Infoworks ICM model. This encompasses both the existing and new underground pipe systems within its framework, ensuring comprehensive representation and analysis within the model's scope building.

2.3.4 Roads

Roads often form the basis for overland flow in high frequency events, however the kerb and channel are not always picked up by DEM surface. To correct for the drainage lines, mesh polygons were used to delineate road corridors with the roads being incorporated a z-line along the gutter to ensure the kerb invert is represent in the mesh.

In our Digital Elevation Model (DEM), a "z-line" refers to a line representing a constant elevation or contour line. These lines connect the existing kerb points of equal elevation on the terrain surface, with maximum of 100mm from invert to top of kerb, allowing for visualisation of the terrain's shape and elevation changes.



2.3.5 Roughness (Manning's n)

Roughness values for this model were derived from the ARR 2019 Guidelines. The Manning's values are listed in Table 4.

Table 4. Manning's Coefficients (ARR 2019)

Land Use	Roads	Open Channel	Rural	Residential	Parks	Buildings	Piped Infrastructure
Manning's n	0.018	0.035	0.04	0.045	0.05	0.3	0.013

2.3.6 Buildings

Buildings were represented as mesh polygons with a high Manning's n value within the model. Buildings with unknown floor levels were set with a minimum 300mm above ground.

2.4 Development Runoff

An evaluation of stormwater runoff from the development site has been conducted using the existing subdivision development models. The objective is to ascertain the potential impact of the overland flow path at the Spoonbill Loop Subdivision in Sorell. It is imperative that the existing development does not adversely affect this flow path, in accordance with established guidelines.

3. Model Results

The results obtained from running the 1% AEP (Annual Exceedance Probability) combined with climate change (CC) simulations were applied to the existing subdivision development model scenario. Through an examination of the model runs (refer to Figure 4), it becomes evident that a shallow overland flood path originates from the eastern boundary behind Nash Street, with maximum flood depths reaching 0.15 meters observed at Lot 8 and Lot 9. The variability in maximum flood depths is notable within the lots, ranging from 0.03 meters to 0.15 meters within the confines of the existing subdivision development.

The influence of the current underground stormwater system on the flood extent is significant, notably mitigating much of the overland flood path. However, minor stormwater surcharges are observed in some locations across the lot, particularly around the inlet and outlet of the new concrete trench positioned between Lots 8 and 9.

Notably, the lots affected by the flood extent fall within the lower hazard category. They can feasibly be developed with the implementation of minor mitigation measures, ranging from elevated pad or floor levels to the incorporation of small open drains along lot boundaries.

Figure 4 solely depicts the maximum flood extent across the entire subdivision. The dewatering process for the displayed overland flow areas is anticipated to occur swiftly, facilitated by the absence of significant barriers or impediments hindering the ingress of flow forces into the underground pipe system. Ultimately, these flow forces discharge into the nearby Orielton Lagoon without obstruction.



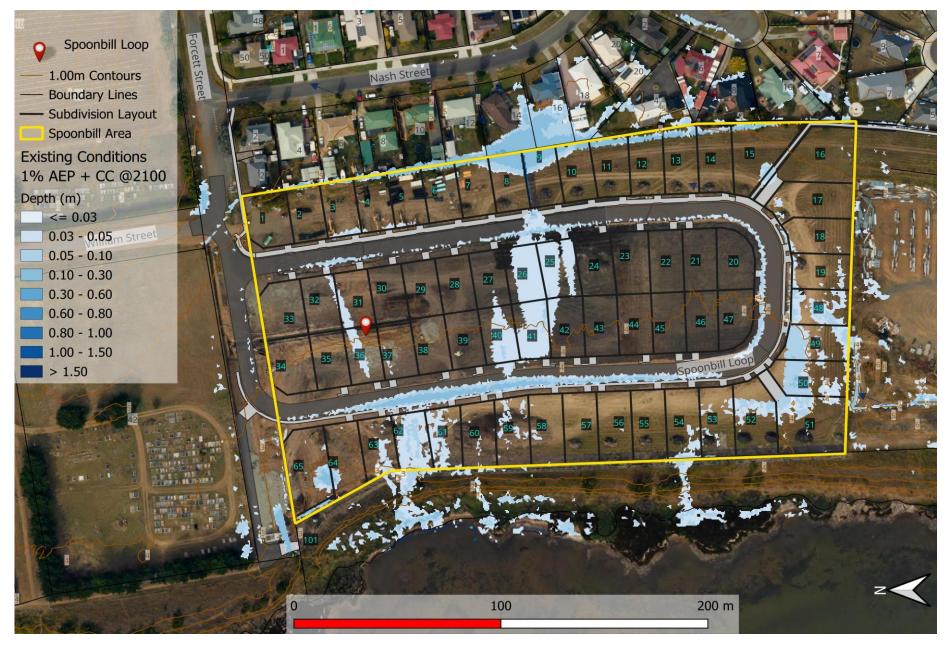


Figure 4. Pre-Development 1% AEP + CC Depth.



3.1 Displacement of Overland Flow on Third Party Property

The current subdivision development analysis reveals that there's no escalation in flood depths affecting neighbouring properties of the development lot. Instead, the overland flow persists towards its natural path. However, this specific subdivision is already impacted by this overland flood path and doesn't add to any heightened flood risk. Consequently, it's safe to conclude that the development doesn't measurably impact third-party properties.

3.2 Development Effects on Flooding

The current subdivision development lies within the natural overland flow path. Yet, with the suggested mitigation strategies, the upcoming dwellings within the impacted lots would pose no negative impact on flooding during a 1% AEP storm event, both within the lot and its surroundings. Velocities and depths in the existing subdivision development scenario fall within the lowest hazard category. Consequently, the post-development models indicate no elevation in risk rating for surrounding properties or infrastructure, nor will it provide an opportunity for development that could result in unacceptable flood risk.

3.3 Future New Habitable Buildings

In order to satisfy the performance standards, set by Building Regulations S.54, any new habitable building construction necessitates a habitable floor level exceeding 300 mm above the flood level of greater than 1% AEP (Annual Exceedance Probability) plus Climate Change (CC) considerations. This regulation applies to the new development at Spoonbill Loop Subdivision, Sorell, as detailed in Table 5. (The requirement for floor level elevation above 1% AEP + CC flood level + 300mm does not extend to non-habitable areas). Below is a summary of the lots affected by flooding extent, potentially falling within the future building footprint.

Table 5. Habitable Floor Construction Levels

Spoonbill Loop Subdivision	1% AEP +CC flood depth (m)	1% AEP + CC flood level (mAHD)	Minimum Floor Level required (mAHD)
Lot 8	0.15	4.80	5.10
Lot 9	0.15	4.81	5.11
Lot 25	0.05	4.89	5.19
Lot 26	0.05	4.88	5.18
Lot 36	0.03	4.32	4.62
Lot 40	0.05	4.42	4.72
Lot 41	0.05	4.48	4.78
Lot 48	0.03	4.08	4.38
Lot 49	0.03	4.05	4.35
Lot 50	0.03	4.05	4.35
Lot 51	0.03	4.01	4.31
Lot 52	0.03	3.96	4.26
Lot 61	0.03	3.30	3.60
Lot 62	0.03	3.24	3.54
Lot 63	0.03	3.20	3.50



As indicated previously, the finished floor level must exceed by at least 300 mm to comply with Building Regulations S.54. If a new pad level is proposed for future dwellings, there should be a minimum vertical height disparity between the pad level plus flood depth and the FFL.

4. Flood Hazard

Under existing conditions the development, the potential locations of the future building in some of the lots are subject to be inundated from 0.03 m to 0.15 m flood depth and 0.13 m/s to 0.42 m/s velocities. This places the hazard rating as adopted by Australian Flood Resilience and Design Handbook as a maximum H1 – Generally safe for people, vehicles and buildings as shown in Appendix A – Hazard maps.

The existing subdivision development scenario sees the most significant flood depths at the eastern boundary of Lot 8 and Lot 9, which has no effect on the hazard rating that remains within the lowest hazard band of H1 for the lot.

As this study does not extend to the public access roads we cannot comment on the accessibility to the site, only within the site. Therefore, this report would advise that residents and visitors remain inside in the event of a flood unless instructed by emergency services.

A summary of the hazard ratings is shown in Figure 5.

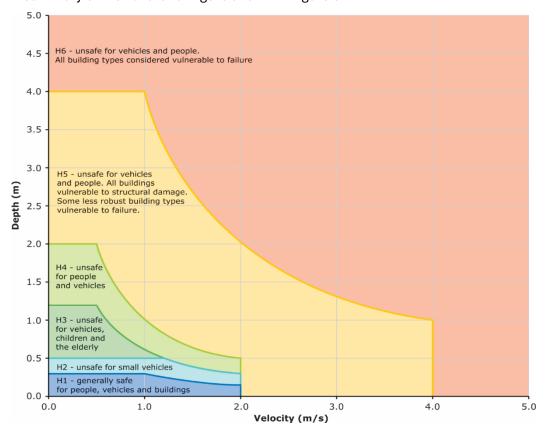


Figure 5. Hazard Categories Australian Disaster and Resilience Handbook

4.1 Tolerable Risk

The lot at Spoonbill Loop Subdivision, Sorell is susceptible to a shallow, slow-moving flood plain flow, with the majority of the immediate surrounding region classified low (H1) hazard rating in the 1% AEP + climate change event.

Even at minor velocity and depths during a storm event, erosion and debris movement nevertheless pose a threat. It is recommended that all structures undertake a hydrostatic/hydrodynamic analysis to ensure suitability. If the recommendations in this report are implemented, the proposed structure, which is intended to be a habitable class 1a structure with a 50-year asset life (BCA2022), can achieve a tolerable risk of flooding over its asset life.



5. Conclusion

The Flood Hazard Report for Spoonbill Loop Subdivision, Sorell development site has reviewed the potential development flood scenario.

The following conclusions were derived in this report:

- 1. The existing subdivision development peak flows for the 1% AEP at 2100 were undertaken to analyse the impact of flooding in the future individual lot development.
- 2. Building Regulations S.54 requires a habitable floor level of no less than the levels outlined in Table 5.
- 3. Flood depths range between 0.03 m to 0.15 m affecting the potential building envelopes of fifteen lots in the existing subdivision.
- 4. Velocity ranges between of 0.13 m/s to 0.42m/s in the riverine flood scenarios.
- 5. Hazard classification within the subdivision remains at the majority of H1, including on neighbouring properties.

6. Recommendations

Flüssig Engineers therefore recommends the following engineering design be adopted for the development and future use to ensure future development meets the Inundation Code:

- 1. Future dwelling affected by the flood extent, to have a minimum floor level as per Table 5 or higher.
- 2. A minimum of 2% grade to be maintained between all entrances from the dwelling to the natural ground level.
- 3. Building pads, if any, must be constructed to fall away at a minimum grade of 2% away from the habitable building and have adequate stormwater drainage within the pad extents.
- 4. Proposed structures, located in the inundation areas, are to be designed and constructed with flood tolerable materials that are deemed flood resistant and they can endure direct exposure to floodwaters.
- 5. Future proposed structures within the flood extent, not depicted in this report, must adhere to the recommendations outlined herein.

According to the local Council authority's regulations, the current development complies with the acceptable solutions and performance criteria outlined in the Tasmanian Planning Scheme 2021.



7. Limitations

Flüssig Engineers were engaged by **JAC Estates Pty Ltd**, for the purpose of a site-specific Flood Hazard Report for Spoonbill Loop Subdivision, Sorell. This study is deemed suitable for purpose at the time of undertaking the study. If the conditions of the site should change, the report will need to be reviewed against all changes.

This report is to be used in full and may not be used in part to support any other objective other than what has been outlined within, unless specific written approval to do otherwise is granted by Flüssig Engineers.

Flüssig Engineers accepts no responsibility for the accuracy of third-party documents supplied for the purpose of this Flood Hazard Report.



8. References

- Australian Disaster Resilience Guideline 7-3: Technical flood risk management guideline: Flood hazard, 2014, Australian Institute for Disaster Resilience CC BY-NC
- Ball J, Babister M, Nathan R, Weeks W, Weinmann E, Retallick M, Testoni I, (Editors), 2019, Australian Rainfall and Runoff: A Guide to Flood Estimation, Commonwealth of Australia
- Grose, M. R., Barnes-Keoghan, I., Corney, S. P., White, C. J., Holz, G. K., Bennett, J. & Bindoff, N. L. (2010). Climate Futures for Tasmania: General Climate Impacts Technical Report.
- T.A. Remenyi, N. Earl, P.T. Love, D.A. Rollins, R.M.B. Harris, 2020, Climate Change Information for Decision Making –Climate Futures Programme, Discipline of Geography & Spatial Sciences, University of Tasmania.



Appendices

Appendix A Flood Study Maps



EXISTING CONDITIONS 1% AEP + CC @2100



EXISTING CONDITIONS 1% AEP + CC @2100




60 m

EXISTING CONDITIONS 1% AEP + CC @2100



Contact Project Manager: Max Moller

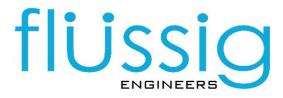

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E: max@flussig.com.au
W: www.flussig.com.au
A: Level 4, 116 Bathurst Street

Hobart TAS 7000



CERTIFICATE OF QUALIFIED PERSON – ASSESSABLE ITEM

Section 321

To:	Sorell Council	Owner /Agent			
		Address Form 55			
		Suburb/postcod⊝			
Qualified perso	on details:				
Qualified person:	Max W. Moller				
Address:	116 Bathurst Street	Phone No: 0431 080 279			
	HOBART 7000	Fax No:			
Licence No:	650370893 Email address: max@flussig.co	m.au			
Qualifications and Insurance details:	Civil - Refer Attached				
Speciality area of expertise:	Hydraulic/ Civil Engineering				
Details of work					
Address:	Spoonbill Loop,	Lot No:			
	Sorell	Certificate of title No:			
The assessable item related to this certificate:	Flood Inundation Report				
Certificate deta	ils:				
Certificate type:	Assessment Work				
This certificate is in	n relation to the above assessable item, at any stago building work, plumbing work or plumbin				
	or	g instantation of demonstration were.			
	a building, temporary	structure or plumbing installation:			
In issuing this certificate the following matters are relevant –					
Documents:	Spoonbill Loop Subdivision, Sorell, Flood Hazard Reportby Flussig	Engineers 09 May 2024 - FE 24028 REV02			
Relevant calculations:	Refer to Flussig Engineers Report				

References:	AS3500 (Parts 0-5)-2015 Plumbing & Drainage set.

Substance of Certificate: (what it is that is being certified)

Flood Inundation Study

Scope and/or Limitations

The hydraulic design of the above elements is based on report provided by Flussig Engineers.

Flussig Engineers recommends that inspections are carried out by the local authority to ensureconstruution has been carried out in accordance with the flood report recommendations.

We must be advised of any proposed alterations to the certified drawings or design discrepancies due to variations of levels or site conditions to those contained in the referenced documents.

We have not been engaged to undertake inspections of the above certified elements.

Max-W-Möller

I certify the matters described in this certificate.

Qualified person:

Certificate No: FE-24028-55 FR

Date: 08/11/2024

DA

TASMANIAN PLANNING SCHEME

SHE	ET INDEX
1	COVER SHEET
2	SITE PLAN
3	SOIL & WATER MANAGEMENT PLAN
4	GROUND FLOOR PLAN
5	ELEVATIONS / SECTION
6	ELEVATIONS
7	WINDOW & DOOR SCHEDULES
8	CALCULATIONS
9	DETAILS (FACE BRICKWORK)
10	DETAILS (CLADDING)
11	ROOF DRAINAGE PLAN
12	FLOOR COVERINGS
13	KITCHEN DETAILS
14	BATHROOM DETAILS
15	WC DETAILS
16	LAUNDRY DETAILS
17	3D VIEWS
18	GENERAL NOTES
19	WET AREA & ENERGY EFFICIENCY NOTES

TOTAL FLOOR AREAS

MAIN DWELLING, GROUND FLOOR			
	ALFRESCO	13.45	
	GARAGE	24.11	
	LIVING	113.64	
	PORCH	1.53	
		152 73 m ²	

HIGHLY REACTIVE / PROBLEMATIC SOIL TYPE. **REFER TO HYDRAULICS PLANS** AND DETAILS PREPARED BY **GANDY AND ROBERTS**

AS & NCC COMPLIANCE

ALL CONSTRUCTION TO BE IN ACCORDANCE WITH NCC 2022 AND APPLICABLE AUSTRALIAN STANDARDS AT TIME OF APPROVAL.
- SLAB IN ACCORDANCE WITH AS 2870. REFER TO ENGINEERS DETAILS

- FOR ALL SLAB DETAILS.
- BRICK CONTROL JOINTS PROVIDED IN ACCORDANCE WITH NCC 2022. ALL STEEL FRAMING TO BE DESIGNED TO AS 4100-2020 OR AS/NZS
- INSULATION TO BE INSTALLED IN ACCORDANCE WITH NCC 2022 AND ALL APPLICABLE AUSTRALIAN STANDARDS.
- TERMITE PROTECTION IN ACCORDANCE WITH AS 3660 AND NCC 2022. GLAZING IN ACCORDANCE WITH AS 1288 AND NCC 2022.
- SMOKE ALARMS IN ACCORDANCE WITH AS 3786 AND NCC 2022.
 INTERNAL WATERPROOFING IN ACCORDANCE WITH NCC 2022.
- HOUSING PROVISIONS PART 10.2. EXTERNAL WATERPROOFING IN ACCORDANCE WITH AS 3740 AND AS WET AREA FLOORS TO FALL TO FLOOR WASTES AT MIN. 1:80 AND MAX
- 1:50 GRADE (IF APPLICABLE). CONDENSATION MANAGEMENT IN ACCORDANCE WITH NCC 2019
- BUILDING SEALING IN ACCORDANCE WITH NCC 2022. SERVICES IN ACCORDANCE WITH NCC 2022.
- EARTHWORKS IN ACCORDANCE WITH AS 3798-2007. EXTERNAL WALL WRAP (SARKING) IN ACCORDANCE WITH NCC 2022 (IF APPLICABLE).
 EXHAUST FANS DUCTED TO OUTSIDE AIR (IF APPLICABLE).

SITE SPECIFIC CONTROLS				
CONTROL	DETAILS			
ACID SULPHATE SOIL	NO			
BIODIVERSITY	NO			
BUILDING ENVELOPE	YES			
BUSHFIRE	NO			
CLIMATE ZONE (NCC)	ZONE 7 - COOL TEMPERATE			
DESIGN WIND CLASSIFICATION	N2 (EXPOSED TBC)			
ESTATE/DEVELOPER GUIDELINES	NO			
FLOOD OVERLAY	YES			
HERITAGE	NO			
LANDSLIP HAZARD	NO			
MINIMUM FLOOR LEVEL	NO			
NATURAL ASSET CODE	YES			
NOISE ATTENUATION	NO			
SALINE SOIL	NO			
SHIELDING FACTOR	PS - PARTIAL SHIELDING			
SITE CLASSIFICATION	H1			
SPECIFIC AREA PLAN OVERLAY	NO			
TERRAIN CATEGORY	TC2			
TOPOGRAPHIC CLASSIFICATION	T3			
WATERWAY & COASTAL OVERLAY	NO			
WIND REGION	A - NORMAL			
WITHIN 1km CALM SALT WATER	NO			
WITHIN 50km BREAKING SURF	6.00km			
ZONING	GENERAL RESIDENTIAL			
PRIORITY VEGETATION	YES			
AIRPORT OBSTACLE LIMITATION	YES			

BUILDING CONTROLS & COMPLIANCE							
CONTROL	REQUIRED	PROPOSED					
SETBACKS							
FRONT	MIN. 4,500mm	5,100mm					
GARAGE TO BOUNDARY	MIN. 5,500mm	5,500mm					
SIDE A	MIN. 1,500mm	1,600mm					
SIDE B	MIN. 1,500mm	900mm					
REAR	MIN. 1,500mm	9,100mm					
BULK & SCALE	BULK & SCALE						
SITE AREA	454m²						
SITE COVERAGE MAX. 50% 33.64%							
BUILDING HEIGHT	MAX. 8,500mm	5,260mm					
LANDSCAPE							
NO APPLICABLE CONTROLS							
EARTHWORKS							
CUT DEPTH	MAX. 2,000mm	313mm					
FILL DEPTH	MAX. 1,000mm	100mm					
ACCESS & AMENITY							
PARKING SPACES	MIN. 2 SPACES	2 SPACES					
PRIVATE OPEN SPACE	MIN. 24m²	24m²					

ALL


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2025.10.22

TRV

DATE DRAWN CHECK

3D PERSPECTIVE

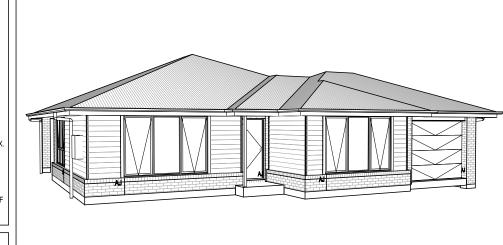

NOTE TO OWNER

THESE PLANS MAY FEATURE WORKS THAT ARE EXCLUDED FROM THE SCOPE OF WORKS WITH THE BUILDER, BUT THEY HAVE BEEN INCLUDED IN THESE DRAWINGS TO ASSIST IN THE OVERALL PLANNING AND ASSESSMENT OF THE BUILDING PROJECT. EXAMPLES OF SOME REGULARLY EXCLUDED WORKS INCLUDE DRIVEWAYS RETAINING WALLS SOLAR PANEL SPACING AND SITE DRAINAGE. PLEASE REFER TO YOUR SCOPE OF WORKS AND COLOUR SELECTIONS DOCUMENTATION FOR DETAILS OF INCLUDED WORKS. SOME DETAILS ARE INDICATIVE ONLY FOR EXAMPLE FLOORING, TILING, BRICKWORK AND CLADDING (EXPANSION JOINTS, ORIENTATION AND LAYOUT) AND ARE SUBJECT TO CHANGE.



GROUND FLOOR TOP OF WALL HEIGHT(S)	2445mm		
NOTE: CEILING HEIGHT 45mm LOWER THAN TOP OF WALL			
ROOF PITCH (U.N.O.)	23.0°		
ELECTRICITY SUPPLY	SINGLE PHASE		
GAS SUPPLY	NONE		
ROOF MATERIAL	SHEET METAL		
ROOF COLOUR	N/A		
WALL MATERIAL	BRICK VENEER CLADDING		
SLAB CLASSIFICATION	TBC		

BUILDING INFORMATION

INSULATION

- 1		
1	ROOF	SARKING UNDER ROOFING
1	CEILING	R4.1 BATTS (EXCL. GARAGE, ALFRESCO)
1	EXT. WALLS	R2.0 BATTS (EXCL. GARAGE)
1		WALL WRAP TO ENTIRE HOUSE
1	INT. WALLS	R2.0 BATTS ADJACENT TO GARAGE AND AS PER PLAN
1	FLOOR	BIAX SLAB R0.60

NCC 2022 LIVABLE HOUSING COMPLIANCE

ACCESSIBLE SANITARY COMPARTMENT: WC ACCESSIBLE SHOWER LOCATION: BATH

GENERAL NOTES:

- THRESHOLD OF ACCESSIBLE SHOWER ENTRY TO BE MAX. 5MM
- 1 EXTERIOR DOOR NOMINATED AS 870 OR GREATER TO ACHIEVE MIN 820MM CLEAR OPENING
- REFER TO APPLICABLE WET AREA PLANS AND INTERIOR ELEVATIONS OR LOCATIONS OF REQUIRED WALL REINFORCEMENT FOR FUTURE GRAB RAIL

INSTALLATION.

THE OWNERS ACKNOWLEDGE THAT THESE CONTRACT PLANS MAY NOT REFLECT ALL THE SELECTIONS THAT HAVE BEEN MADE OR CHANGES REQUESTED. THE OWNERS AGREE THAT FOLLOWING THE COLOUR SELECTIONS VARIATION OR UPDATING OF PLANS. THEY WILL BE PROVIDED WITH CONSTRUCTION PLANS FOR SIGNATURE PRIOR TO COMMENCEMENT OF CONSTRUCTION.

SIGNATURE:

DATE:

Sorell Council

evelopment Application: Development pplication - 3 Spoonbill Loop, Sorell.pdf

Plans Reference: P1 ate Received: 10/11/2025

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PLAN ACCEPTANCE BY OWNER SIGNATURE: DATE:

SUBJECT TO NCC 2022

(1 MAY 2023) WATERPROOFING & PLUMBING

SIGNATURE: DATE:

PLEASE NOTE THAT VARIATIONS WILL NOT BE ACCEPTED

AFTER THIS PLAN ACCEPTANCE HAS BEEN SIGNED

WILSON
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PRELIMINARY PLAN SET

PRELIMINARY PLAN SET - INITIAL ISSUE

AMENDMENT


	IN ANY WAY REPRODUCE, COPY, MODIFY, USE OR TAKE ADVANTAGE OF THE DRAWING TO BUILD A HOUSE BASED ON THIS PLAN (WHETHER IN WHOLE OR IN PART) WITHOUT THE PRIOR WRITTEN CONSENT OF WILSON HOMES PTY LTD.					ı≝			
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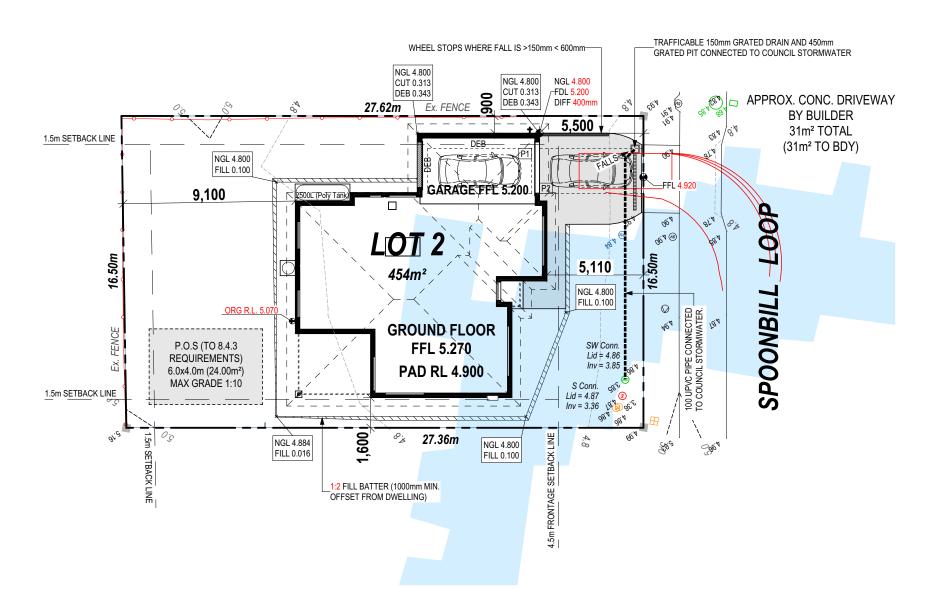
SUSTAINABILITY REQUIREMENTS SITE CLASSIFICATION GENERAL BUILDING INFORMATION


APPROX. CUT/FILL

44 TONNES OF IMPORT FILL					
DIFFERENCE	19.36m³	43.56t			
FILL	19.36m³	43.56t			
CUT	0.00m ³	0.00t			

LOT SIZE: 454m² HOUSE (COVERED AREA): 152.73m² SITE COVERAGE: 33.64%



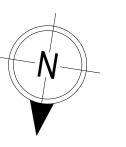

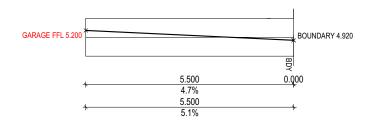



Development Application: Development Application - 3 Spoonbill Loop, Sorell.pdf

Plans Reference: P1 Date Received: 10/11/2025

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SUBJECT TO NCC 2022
(1 MAY 2023)

WATERPROOFING & PLUMBING

PLAN ACCEPTANCE BY OWNER					
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SIGNATURE:	DATE:				
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OWNER TO STABILISE THE SITE ON COMPLETION OF THE BUILD WITH TURF LAWNS, GRASS SEEDS, NATIVE GROUND COVERS AND/ OR MULCH SPREAD TO A DEPTH OF 75-100mm


THE FOLLOWING IS A STANDARD
APPROACH. SEDIMENT AND EROSION
CONTROL MEASURES WILL BE REVIEWED
PRIOR TO COMMENCING WORK AND
INSTALLED BASED ON THE OUTCOME OF
THAT REVIEW.


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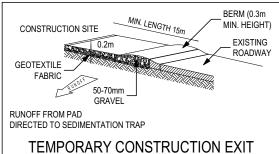
1. ALL EROSION AND SEDIMENT CONTROL STRUCTURES TO BE INSPECTED EACH WORKING DAY AND MAINTAINED IN GOOD WORKING ORDER.


- 2. ALL GROUND COVER VEGETATION
 OUTSIDE THE IMMEDIATE BUILDING AREA
 TO BE PRESERVED DURING THE BUILDING
 PHASE.
- 3. ALL EROSION AND SEDIMENT CONROL MEASURES TO BE INSTALLED PRIOR TO COMMENCEMENT OF MAJOR EARTHWORKS.
- 4. STOCKPILES OF CLAYEY MATERIAL TO BE COVERED WITH AN IMPERVIOUS SHEET.
 5. ROOF WATER DOWNPIPES TO BE
- CONNECTED TO THE PERMAMENT
 UNDERGROUND STORMWATER DRAINAGE
 SYSTEM AS SOON AS PRACTICAL AFTER
 THE ROOF IS LAID.
- 6. DIVERSION DRAINS ARE TO BE CONNECTED TO A LEAGAL DISCHARGE POINT (COUNCIL STORMWATER SYSTEM, WATERCOURSE OR ROAD DRAIN).
 7. SEDIMENT RETENTION TRAPS INSTALLED AROUND THE INLETS TO THE STORMWATER SYSTEM TO PREVENT SEDIMENT & OTHER DEBRIS BLOCKING THE DRAINS.





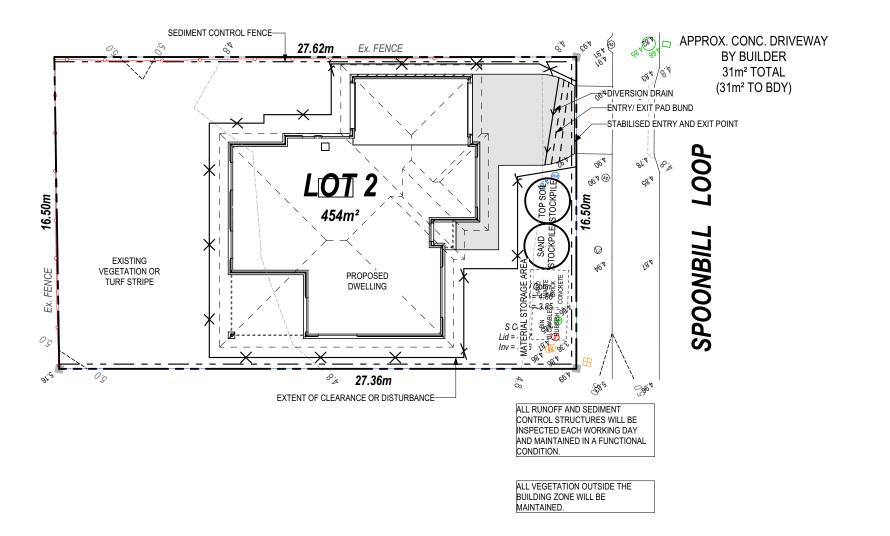

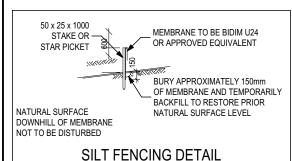

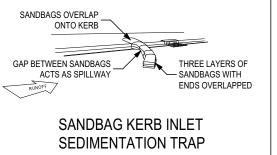



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PLAN ACCEPTANCE BY OWNER						
SIGNATURE:	DATE:					
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	SPECIFICATION:	REVISION	DRAWN	CLIENT:		HOUSE DESIGN:		HOUSE CODE:	DO NOT SCALE DRAWINGS, USE	ĺ
1	DISCOVERY	1 DRAFT SALES PLAN - CT1	MLG 19/08/2025	AMBER LOUISE GADD 8	& ADRIAN JOHN BUTTERWORT	ASCOT 12		H-WDCASC10SA	FIGURED DIMENSIONS ONLY. CHECK AND VERIFY DIMENSIONS AND	46
	COPYRIGHT:	2 DRAFT SALES PLAN - CT1 AMENDMENTS	MFC 24/09/2025			FACADE DESIGN:			LEVELS PRIOR TO THE COMMENCEMENT OF ANY WORK. ALL	
	© 2025	3 PRELIM PLANS - INITIAL ISSUE	TRV 22/10/2025	3 SPOONBILL LOOP, SO	RELL TAS 7172	CLASSIC		F-WDCASC10CLASA	DISCREPANCIES TO BE REPORTED TO THE DRAFTING OFFICE.	Versic
		4			COUNCIL:	SHEET TITLE:		SCALES:	714407	olate
				2 / - / 186811	SORELL	SOIL & WATER MANAGEMENT PLAN	3 / 19	1:200	<i>1</i> 1440 <i>1</i>	Jemb

Last Published: Wednesday, 22 October 2025 1

13,310 ANY PART OF THE FASCIA, GUTTERING OR DOWNPIPE THAT 2,890 390, IS WITHIN 450mm OF ANY BOUNDARY IS TO BE NON-3,560 6,470 COMBUSTIBLE IN ACCORDANCE WITH NCC 2022 6,000 GARAGE 230, REFER TO SHEET 1 (COVER SHEET) FOR MAIN DWELLING, GROUND FLOOR ALL EXTERIOR SLABS TO BE GRADED BY CONCRETER TO ACHIEVE APPROX. 1:100 FALL TO OUTSIDE EDGE WITH MAXIMUM CROSSFALL OF 30mm OVER ENTIRE SLAB. , 1,550 WC 90_{**} 1,830 BATH 90_{**} 1,750 LDRY 90_{**} 1,000 ** ALFRESCO 13.45 SUSTAINABILITY REQUIREMENTS GARAGE 24.11 3,400 BED 2 / ROBE GENERAL BUILDING INFORMATION LIVING 113.64 90_{kk} 1,650 ROBE 90_{kk} 1,060 90_{kk} 5,310 HALL 4.630 BED 1 PORCH 1.53 90,, ALL MECHANICAL VENTILATION TO BE 152.73 m² DISCHARGED TO OUTDOOR AIR AS PER NCC 2022 REQUIREMENTS * 900 * 610 * 1,860 40** FIRE RESISTANT PLASTERBOARD TO BE INSTALLED BEHIND COOKTOP ALL GROUND FLOOR BULKHEAD AND SQUARE SET OPENING FRAMES TO BE MAINS WATER 2155 ABOVE FFL UNLESS NOTED YARD TAP OTHERWISE REFER TO WINDOW AND DOOR SCHEDULES FOR FULL DETAILS OF ALL THRESHOLD OF ACCESSIBLE SHOWER ENTRY WINDOWS AND DOORS. PLEASE NOTE WINDOW AND DOOR SIZES ARE BASED ON

FINAL WINDOW AND EXTERIOR DOOR LOCATIONS MAY BE ADJUSTED ON SITE TO SUIT BRICKWORK GAUGE LINI ESS NOTED OTHERWISE ALL ROOMS ARE REFERENCED AS FOLLOWS:


MANUFACTURERS SPECIFICATIONS AT DEPOSIT STAGE AND MAY DIFFER

SLIGHTLY TO THE SIZES NOMINATED IN


THE SCOPE OF WORKS DUE TO MANUFACTURING CHANGES AT THE TIME

OF CONSTRUCTION



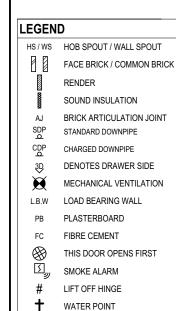

GAS BAYONET

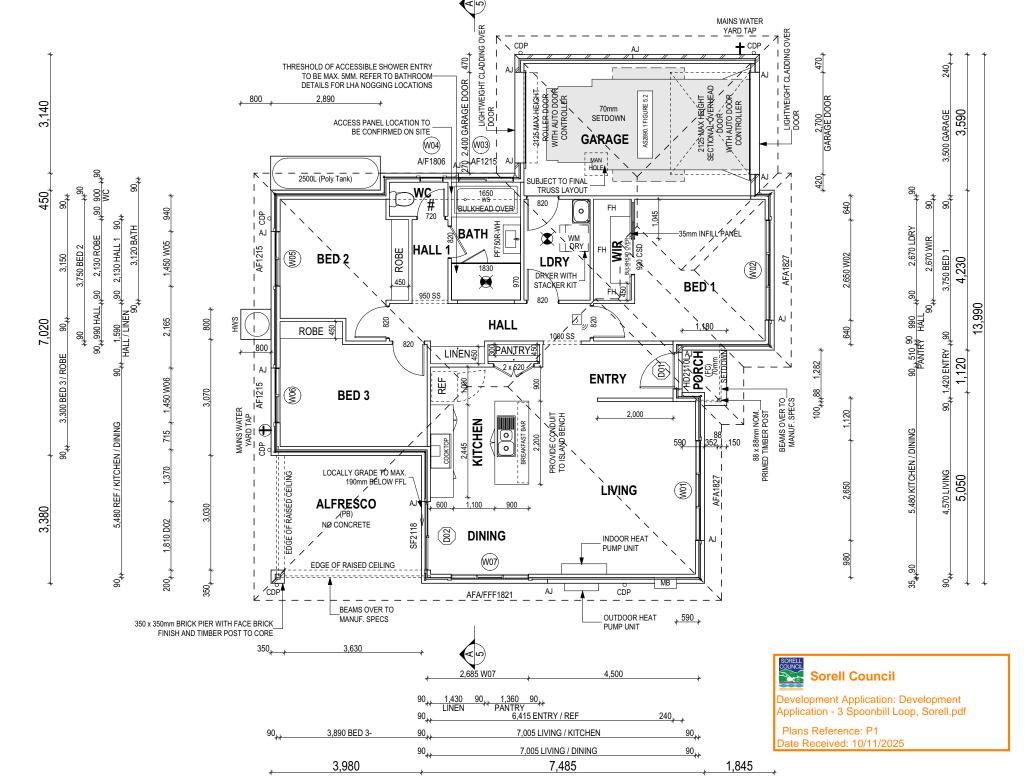

ALL DIMENSIONS ARE FRAME DIMENSIONS

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SUBJECT TO NCC 2022 (1 MAY 2023) WATERPROOFING & PLUMBING

PLAN ACCEPTANC	E BY OWNER		l
SIGNATURE:	DATE:		
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PLEASE NOTE THAT VARIATIONS		ļ.	

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	SPECIFICATION:	REVISION	DRAWN	CLIENT:		HOUSE DESIGN:		HOUSE CODE:	DO NOT SCALE DRAWINGS, USE	i
10	DISCOVERY	DRAFT SALES PLAN - CT1 ML	G 19/08/2025	AMBER LOUISE GADD	& ADRIAN JOHN BUTTERWORT	ASCOT 12		H-WDCASC10SA	FIGURED DIMENSIONS ONLY. CHECK AND VERIFY DIMENSIONS AND	140
		DRAFT SALES PLAN - CT1 AMENDMENTS MF	C 24/09/2025			FACADE DESIGN:			LEVELS PRIOR TO THE COMMENCEMENT OF ANY WORK. ALL	n: 24
)	© 2025	PRELIM PLANS - INITIAL ISSUE TR	V 22/10/2025	3 SPOONBILL LOOP, SO	RELL TAS 7172	CLASSIC		F-WDCASC10CLASA	DISCREPANCIES TO BE REPORTED TO THE DRAFTING OFFICE.	/ersic
)	4			LOT / SECTION / CT:	COUNCIL:		SHEET No.:	SCALES:	714407	late \
				2 / - / 186811	SORELL	GROUND FLOOR PLAN	4 / 19	1:100	, /144U/	_ dwa


SH = SNAP HEADER SILL BEDROOM WINDOW OPENINGS

ARE SUBJECT TO CHANGE.

ABOVE 2m OFF THE SURFACE BENEATH TO BE RESTRICTED AS REQUIRED BY NCC 11.3.7 (VOLUME

ROOMS OTHER THAN BEDROOM WINDOW OPENINGS ABOVE 4m OFF THE SURFACE BENEATH TO BE RESTRICTED AS REQUIRED BY NCC 11.3.7 (VOLUME TWO)

REFER TO THE FOLLOWING DETAILS: BRICK COURSING W-BRIC-001

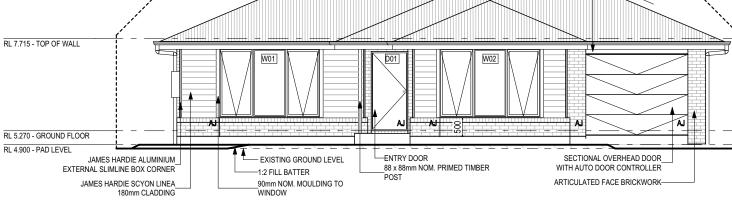


WEST ELEVATION SCALE: 1:100

COLORBOND CORRUGATED /


-CUSTOM ORB METAL ROOFING + SARKING

LIGHTWEIGHT CLADDING OVER

DOOR

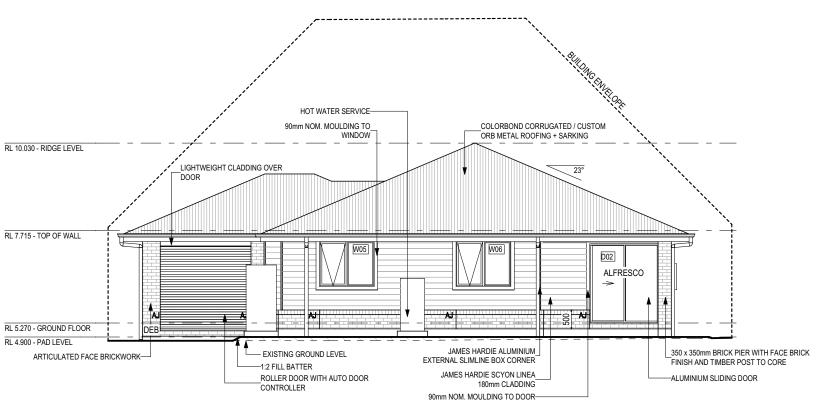

EAST ELEVATION SCALE: 1:100

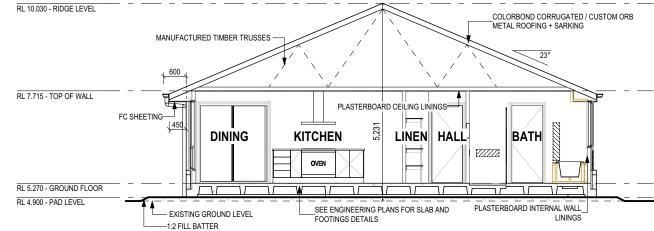

SECTION A-A SCALE: 1:100



SUBJECT TO NCC 2022 (1 MAY 2023)

WATERPROOFING & PLUMBING



WINDOW TYPE LEGEND							
	\ \ \			>			
AWNING	DOUBLE	FIXED	LOUVRE	SLIDING			

PLAN ACCEPTA	NCE BY OWNER
SIGNATURE:	DATE:
SIGNATURE:	DATF:
SIGNATURE.	DATE.
PLEASE NOTE THAT VARIATION	ONS WILL NOT BE ACCEPTED
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RL 10.030 - RIDGE LEVEL

	INTAIL THAT ICE TO BOOK, OUT, INDIED 1, OUT OF THE DISTRICT OF BOILD AT HIGH ENGLISH WHOLE OF THE THAT INTITUTE OF THE THAT INTITUTE OF THE THAT IS A CONCENT OF THE DISTRICT									
	SPECIFICATION:	REVISION	DRAWN CLIENT:		HOUSE DESIGN:		HOUSE CODE:	DO NOT SCALE DRAWINGS, USE	ĺ	
\cap	DISCOVERY	1 DRAFT SALES PLAN - CT1	MLG 19/08/2025 AMBER LOUISE GAI	DD & ADRIAN JOHN BUTTERWORT	ASCOT 12	OT 12		FIGURED DIMENSIONS ONLY. CHECK AND VERIFY DIMENSIONS AND		
ш	COPYRIGHT:	2 DRAFT SALES PLAN - CT1 AMENDMENTS	MFC 24/09/2025 ADDRESS:		FACADE DESIGN:			LEVELS PRIOR TO THE COMMENCEMENT OF ANY WORK. ALL		
	© 2025	3 PRELIM PLANS - INITIAL ISSUE	TRV 22/10/2025 3 SPOONBILL LOOP, SORELL TAS 7172		CLASSIC		F-WDCASC10CLASA	DISCREPANCIES TO BE REPORTED TO THE DRAFTING OFFICE.	/ersic	
		4	LOT / SECTION / CT:	COUNCIL:	SHEET TITLE:	SHEET No.:		714407	ate	
			2 / - / 186811	SORELL	ELEVATIONS / SECTION	5 / 19	1:100	114401	Je Je	


RL 10.030 - RIDGE LEVEL JAMES HARDIE ALUMINIUM EXTERNAL RL 7.715 - TOP OF WALL RL 5.270 - GROUND FLOOR DEB RL 4.900 - PAD LEVEL 1:2 FILL BATTER ARTICULATED FACE BRICKWORK 90mm NOM. MOULDING TO WINDOW-2500L (Poly Tank) (2500L) ABOVE GROUND WATER TANK 2800 x 800 x 1750H ON 2900 x 900-- EXISTING GROUND LEVEL

Sorell Council

Development Application: Development Application - 3 Spoonbill Loop, Sorell.pdf

Plans Reference: P1 ate Received: 10/11/2025 **SOUTH ELEVATION** SCALE: 1:100



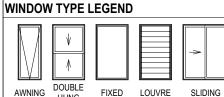

PLAN ACCEPTANCE BY OWNER SIGNATURE: SIGNATURE: PLEASE NOTE THAT VARIATIONS WILL NOT BE ACCEPTED

SUBJECT TO NCC 2022

(1 MAY 2023)

WATERPROOFING & PLUMBING

AFTER THIS PLAN ACCEPTANCE HAS BEEN SIGNED

DATE:

DATE:

714407

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SPECIFICATION:	REVISION	[RAWN	CLIENT:	HOUSE DESIGN:		HOUSE CODE:	DO NOT SCALE DRAWINGS, USE
DISCOVERY	1 DRAFT SALES PLAN - CT1	MLG	19/08/2025	AMBER LOUISE GADD & ADRIAN JOHN BUTTERWORT	ASCOT 12		H-WDCASC10SA	FIGURED DIMENSIONS ONLY. CHECK AND VERIFY DIMENSIONS AND
COPYRIGHT:	2 DRAFT SALES PLAN - CT1 AMENDMENTS	MFC	24/09/2025	ADDRESS:	FACADE DESIGN:		FACADE CODE:	LEVELS PRIOR TO THE COMMENCEMENT OF ANY WORK. ALL
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	4					SHEET No.:	SCALES:	714407
				2 / - / 186811 SORELL	ELEVATIONS	6 / 19	1:100	/ I44U/

EXTERIOR WINDOW & DOOR SCHEDULE 1.2 ASSUME LOOKING FROM OUTSIDE

TYPE

AWNING

AWNING

AWNING

AWNING

AWNING

AWNING

AWNING

SWINGING

SLIDING

ROOM

LIVING

BED 1

BATH

WC

BED 2

BED 3

DINING

ENTRY

DINING

HEIGHT

1.800

1,800

1,200

1,800

1,200

1,200

1,800

2,100

2,100

WIDTH PERIMETER

8,900

8.900

5,300

4,820

5,300

5,300

7,700

6,140

7,820

46,220 mm

13,960 mm

60,180 mm

2.650

2.650

1,450

610

1,450

1,450

2,050

970

1,810

ID CODE1

GROUND FLOOR W01 AFA1827

GROUND FLOOR W02 AFA1827

GROUND FLOOR | W03 | AF1215

GROUND FLOOR W04 A/F1806

GROUND FLOOR | W05 | AF1215

GROUND FLOOR | W06 | AF1215

GROUND FLOOR D01 HD2110L

GROUND FLOOR D02 SF2118

GROUND FLOOR W07 AFA/FFF1821

STOREY

WINDOW

DOOR

velopment Application: Development application - 3 Spoonbill Loop, Sorell.pdf

Plans Reference: P1 ate Received: 10/11/2025

WERS Code	U Value	SHGC
DOW-022-003	2.9	0.64
DOW-005-001	3.9	0.58
DOW-038-001	3.03	0.71
DAR-034-001	3.97	0.63
DAR-034-001	3.97	0.63
DOW-017-001	4.1	0.55
DOW-020-001	4.1	0.54
		SHGC
		0.61
		0.54
		0.66
		0.58
		0.58
		0.53
DOW-020-001	4.1	0.54
		SHGC
	•	0.61
		0.54
		0.66
		0.59
		0.59
GRN-009-001	4.29	0.53
/E Uw better and or equ	ual to stated	figures
	DOW-022-003 DOW-005-001 DOW-038-001 DAR-034-001 DAR-034-001 DOW-017-001 DOW-020-001 WERS Code TND-034-001 STG-001-066 DOW-038-005 AUW-009-009 GRN-009-001 DOW-020-001 WERS Code TND-034-001 STG-001-066 DOW-038-005 AMJ-007-005 AMJ-007-005 GRN-009-001	DOW-022-003 2.9 DOW-005-001 3.9 DOW-038-001 3.03 DAR-034-001 3.97 DAR-034-001 3.97 DOW-017-001 4.1 DOW-020-001 4.1 WERS Code TND-034-001 3.1 STG-001-066 3.91 DOW-038-005 AUW-009-009 4.03 GRN-009-001 4.25 DOW-020-001 4.1 WERS Code TND-034-001 3.1 STG-001-066 3.91 DOW-020-001 3.1 STG-001-066 3.91 DOW-038-005 3.02 AMJ-007-005 4.03 AMJ-007-005 4.03

and SHGC within +/- 5% of stated figures. Restricted windows to have

HEIGHT WIDTH AREA (m²)

ASCOT 12

FACADE DESIGN:

WINDOW & DOOR SCHEDULES

CLASSIC

SHEET TITLE:

PICTURE, TV RECESS AND SS WINDOW OPENINGS

their openability restricted as per N.C.C 11.3.6.

QTY TYPE

INTERIOR WINDOW & DOOR SCHEDULE

STOREY QTY CODE TYPE HEIGHT WIDTH GLAZING TYPE ADDITIONAL INFORMATION DOOR GROUND FLOOR 1 1000 SS SQUARE SET OPENING 2,155 1,000 N/A **GROUND FLOOR** SWINGING 2,040 1,040 N/A 2 x 520 GROUND FLOOR 720 SWINGING 2,040 720 N/A LIFT-OFF HINGES GROUND FLOOR **SWINGING** 820 2.040 820 N/A GROUND FLOOR 1 **CAVITY SLIDING** 920 CSD 2,040 920 N/A SQUARE SET OPENING GROUND FLOOR 1 950 SS 2,155 950 N/A

DRAFT SALES PLAN - CT1

3 PRELIM PLANS - INITIAL ISSUE

2 DRAFT SALES PLAN - CT1 AMENDMENTS

NOTE: INTERNAL DOORS TO WET AREAS WITH MECHANICAL VENTILATION TO BE UNDERCUT 20mm

MFC 24/09/2025 ADDRESS:

AREA FRAME

(m²) TYPE

4.77 ALUMINIUM N/A

4.77 ALUMINIUM N/A

1.74 ALUMINIUM N/A

1.10 ALUMINIUM N/A

1.74 ALUMINIUM N/A

1.74 ALUMINIUM N/A

3.69 ALUMINIUM N/A

2.04 ALUMINIUM N/A

3.80 ALUMINIUM N/A

19.55

5.84

25.39

BAL

RATING

SILL TYPE

NONE

NONE

NONE

NONE

NONE

NONE

NONE

SNAP HEADER

SNAP HEADER

GLAZING

AREA (m²)

15.65

4.72

20.37

1.41 N\A

GLAZING TYPE (SINGLE GLAZING U.N.O.)

1.38 OBSCURE, DOUBLE GLAZED, TOUGHENED

0.80 OBSCURE, DOUBLE GLAZED, TOUGHENED

3.31 CLEAR, DOUBLE GLAZED, TOUGHENED

Window Manufacturer: Dowell Windows

3.93 CLEAR, DOUBLE GLAZED

3.93 CLEAR, DOUBLE GLAZED

1.38 CLEAR, DOUBLE GLAZED

1.38 CLEAR, DOUBLE GLAZED

2.85 CLEAR, DOUBLE GLAZED

ADDITIONAL INFORMATION²

BP 600, MP 683-683/683-683, GLAZING BARS

MP 883-883

MP 883-883

MP 725

BP 600

MP 725

MP 725

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DISCOVERY

REFER TO SHEET 1 (COVER SHEET) FOR SUSTAINABILITY REQUIREMENTS

GENERAL BUILDING INFORMATION

SPECIFICATION:

MLG | 19/08/2025 | AMBER LOUISE GADD & ADRIAN JOHN BUTTERWORT

TRV 22/10/2025 3 SPOONBILL LOOP, SORELL TAS 7172

LOT / SECTION / CT:

2 / - / 186811

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	DEL//OLON	DRAWN CLIENT:	HOUSE DESIGN.

COUNCIL:

SORELL

HOUSE CODE DO NOT SCALE DRAWINGS, USE FIGURED DIMENSIONS ONLY, CHEC H-WDCASC10SA AND VERIFY DIMENSIONS AND I EVELS PRIOR TO THE FACADE CODE: COMMENCEMENT OF ANY WORK. AL DISCREPANCIES TO BE REPORTED TO THE DRAFTING OFFICE. F-WDCASC10CLASA SCALES: 714407

SUBJECT TO NCC 2022

(1 MAY 2023)

WATERPROOFING & PLUMBING

PLAN ACCEPTANCE BY OWNER

PLEASE NOTE THAT VARIATIONS WILL NOT BE ACCEPTED

AFTER THIS PLAN ACCEPTANCE HAS BEEN SIGNED

DATE:

DATE:

SIGNATURE:

SIGNATURE:

SHEET No.:

7 / 19

NATURAL LIGH	T AND VENTI	LATION				
ROOM	AREA (m2)	WINDOW ID	LIGHT REQUIRED (m2)	LIGHT ACHIEVED (m2)	VENTILATION REQ`D (m2)	VENTILATION ACH'D (m2)
OPEN KITCHEN/ LIVING/ DINING	34.84 m²	W01, W07, D02	3.48 m²	9.55 m²	1.74 m²	6.22 m²
BED 1	14.02 m²	W02	1.40 m²	3.39 m²	0.70 m²	2.96 m²

1.38 m²

1.38 m²

0.53 m²

0.57 m²

PART 10.5.1 LIGHT: Minimum 10% of the floor area of a habitable room required (natural light)

W05

W06

10.54 m²

11.34 m²

PART 10.6 VENTILATION: Minimum 5% of the floor area of a habitable room required. (An exhaust fan may be used for sanitary compartment, laundry or bathroom provided contaminated air discharges directly to the outside of the building by way of ducts).

1.05 m²

1.13 m²



Development Application: Development Application - 3 Spoonbill Loop, Sorell.pdf

Plans Reference: P1 Date Received: 10/11/2025

REFER TO SHEET 1 (COVER SHEET) FOR ALL BUILDING INFORMATION REGARDING:
- SUSTAINABILITY REQUIREMENTS
- SITE CLASSIFICATION
- GENERAL BUILDING INFORMATION

BED 2

BED 3

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SIGNATURE:

SUBJECT TO NCC 2022 (1 MAY 2023)

WATERPROOFING & PLUMBING

PLAN ACCEPTANCE BY OWNER

0.79 m²

0.79 m²

	SPECIFICATION:	REVISION	DRAWN	CLIENT:		HOUSE DESIGN:		HOUSE CODE:	DO NOT SCALE DRAWINGS, USE
	DISCOVERY	1 DRAFT SALES PLAN - CT1	MLG 19/08/2025	AMBER LOUISE GADD 8	& ADRIAN JOHN BUTTERWORT	ASCOT 12		H-WDCASC10SA	FIGURED DIMENSIONS ONLY. CHECK AND VERIFY DIMENSIONS AND LEVELS PRIOR TO THE
mir2011	COPYRIGHT:	2 DRAFT SALES PLAN - CT1 AMENDMENTS	MFC 24/09/2025	ADDRESS:		FACADE DESIGN:			COMMENCEMENT OF ANY WORK. ALL
IIUWLC	© 2025	3 PRELIM PLANS - INITIAL ISSUE	TRV 22/10/2025	3 SPOONBILL LOOP, SO	RELL TAS 7172	CLASSIC		F-WDCASC10CLASA	TO THE DRAFTING OFFICE.
HUIIIE2		4		LOT / SECTION / CT:	COUNCIL:	SHEET TITLE:	SHEET No.:	SCALES:	744407
				2 / - / 186811	SORFIL	CALCULATIONS	8 / 19		714407

ile Location: P.\8. Drafting\Job Files\71440\0714407 - Gadd & Butterworth (AC24)\Plans

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14	3350	3370	1200	39	9350	GT	3343
14 ¹ ₂	3470	3490		39 ¹ ₂	9470	H.	
15	3590	3610	1286	40	9590) C	3429
15 ¹ ₂	3710	3730		40 ¹ 2	9710) T(
16	3830	3850	1372	41	9830	, 20	3514
16 ¹ ₂	3950	3970		41 ¹ 2	9950	DD	
17	4070	4090	1457	42	10070	A (3600
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18	4310	4330	1543	43	10310		3686
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19	4550	4570	1629	44	10550	<u> </u>	3772
19 ¹ ₂	4670	4690		44 ¹ ₂	10670	ED	
20	4790	4810	1714	45	10790	UIR	3857
20 ¹ ₂	4910	4930		45 ¹ 2	10910	not often required. If needed Add 20 to length	
21	5030	5050	1800	46	11030	N -	3943
2112	5150	5170		46 ¹ 2	11150		
22	5270	5290	1886	47	11270	님	4029
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23	5510	5530	1972	48	11510	\mathbb{R}^{2}	4114
23 ¹ ₂	5630	5650		48 ¹ 2	11630		
24	5750	5770	2057	49	11750		4200
241 2	5870	5890		49 ¹ 2	11870		
25	5990	6010	2143	50	11990		4286
25 ¹ 2	6110	6130		100	23990		8572

STANDARD BRICK

MANUFACTURING SIZE: 230x110x76mm

36¹ ₂

36¹ ₂

37¹ ₂

all dimensions in mm BRICKWORK DIMENSIONS

Bricks per m² in wall = 48.5 approx.

FORMAT SIZE: 240x120x86mm


11 ¹ ₂

12 ¹ ₂

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	PITCHING POINT	51 51	
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SELECTED ROOFING ON BATTENS AS REQU			1
EV/E VS DED DI		90	
* LAVE AGENT			
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PITCHING POINT TRUSS TOP	CHORD TO TO		BOTTOM CHORD
TRUSS TO			
TIMBER DRC		PACH	ING AS REQUIRED
	SS TOP -	ARCH	HITRAVE
CHORDS AS REC	QUIRED	2	HEAD TRIMMER
DROP OFF			
EAVE FRAMING AS REQUIRED———	T		ER WINDOW REVEAL
31 x 18mm STORM MOULD (ALL CORNERS MUST BE MITRED)	 	III	GS AS REQUIRED 1 PACKING AS REQUIRED
WINDOW AS PER CONSTRUCTION PLANSAND TO GLAZING MANUFACTURER'S DETAIL		201111	TEACHING AS INEQUINED
OUTSIDE		" !	SIDE
BRICKWORK IN DISTANCE	<u>-</u>		GS AS REQUIRED
WATER COMPENSATING APRON BY GLAZING MANUFACTURER—		FACT PER	ORY FITTED TIMBER REVEAL AS WINDOW MANUFACTURER'S DETAIL
00 <mark>0</mark> 0			WINDOW SILL
		110	SILL TRIMMER
FALL T		18	
200750 000		L_ARCH	HITRAVE
RAKED SILL		20mn	PACKING AS REQUIRED
20 OVERHANG			ER FOR SUPPORT ABOVE 1200mm
SPLIT BRICK————————————————————————————————————		BY B	JILDER
FLASHING (ALCOR OR SIMILAR) TO SILL ONLY-	100000000000000000000000000000000000000	SERVE	
		Beresta	
	122-213-313-313-31	90	
WALL WRAP(RED)	 	PLAS	TERBOARD LINING
	F3554573474	NEGRESS:	
		WALL	INSULATION AS PER
	12027077772		STRUCTION PLANS
			TIMO
DPC(BROWN)	-	SKIR	FFL
WEEP HOLE-			A A A A A A
155		4 4 4 4	4 4 4 4 4
KORDON TB(GREEN)	 	b b b	
* -	Passabarat A	J	A A B A A
	4 4 4	4 4 4	
	A A A	A A A A	4 4 4 4
	4 4	A A A A	

SECTIONS

SCALE: 1:10

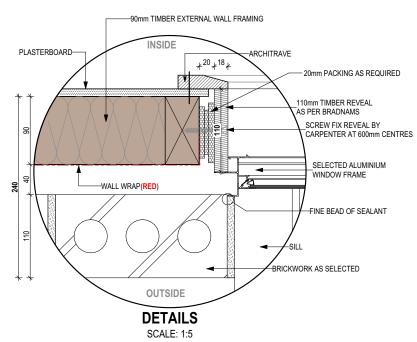

STANDARD BRICK

MANUFACTURING SIZE: 230x110x76mm

26¹ ₂

27¹ ₂

28¹ ₂

29¹ ₂

30¹ ₂

31¹₂

32¹ ₂

33¹ ₂

34¹ ₂

VERTICAL GAUGE: 7 Courses to 600mm

BRICKWORK DIMENSIONS Bricks per m² in wall = 48.5 approx.

FORMAT SIZE: 240x120x86mm

2¹ ₂

3¹ ₂

4¹ ₂

5¹ ₂

6¹ 2

7¹ ₂

8¹ ₂

9¹ ₂

Sorell Council

Development Application: Development Application - 3 Spoonbill Loop, Sorell.pdf

Plans Reference: P1
Date Received: 10/11/2025

SUBJECT TO NCC 2022 (1 MAY 2023) WATERPROOFING & PLUMBING


PLAN ACCEPTANCE BY OWNER SIGNATURE: DATE: SIGNATURE: DATE: PLEASE NOTE THAT VARIATIONS WILL NOT BE ACCEPTED AFTER THIS PLAN ACCEPTANCE HAS BEEN SIGNED

REFER TO SHEET 1 (COVER SHEET) FOR ALL BUILDING INFORMATION REGARDING: - SUSTAINABILITY REQUIREMENTS - SITE CLASSIFICATION - GENERAL BUILDING INFORMATION

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HOMES

SPECIFICATION:	REVISION	DRAWN	CLIENT:		HOUSE DESIGN:		HOUSE CODE:	DO NOT SCALE DRAWINGS, USE
DISCOVERY	DRAFT SALES PLAN - CT1	MLG 19/08/2025	AMBER LOUISE GADD 8	& ADRIAN JOHN BUTTERWORT	ASCOT 12		H-WDCASC10SA	FIGURED DIMENSIONS ONLY. CHECK AND VERIFY DIMENSIONS AND LEVELS PRIOR TO THE
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© 2025	PRELIM PLANS - INITIAL ISSUE	TRV 22/10/2025	3 SPOONBILL LOOP, SO	RELL TAS 7172	CLASSIC		F-WDCASC10CLASA	DISCREPANCIES TO BE REPORTED TO THE DRAFTING OFFICE.
4				COUNCIL:		SHEET No.:	SCALES:	714407
			2 / - / 186811	SORELL	DETAILS (FACE BRICKWORK)	9 / 19		114401

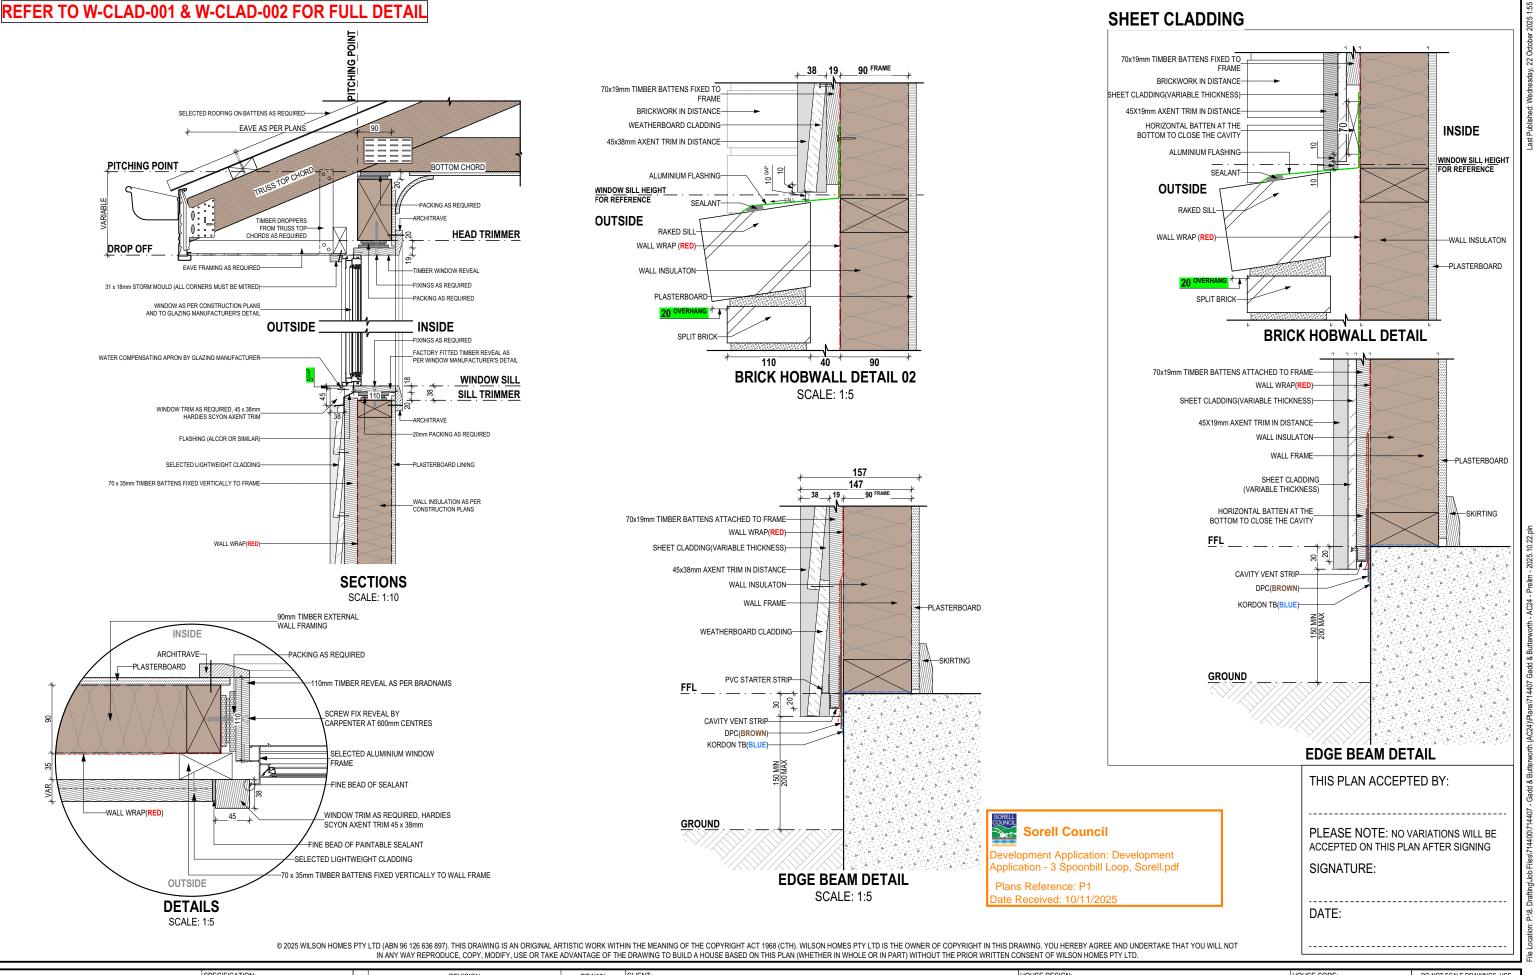

WILSONHOMES


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\cap	DISCOVERY	1	DRAFT SALES PLAN - CT1	MLG	19/08/2025	AMBER LOUISE GADD 8	ADRIAN JOHN BUTTERWORT	ASCOT 12		H-WDCASC10SA	FIGURED DIMENSIONS ONLY. CHECK AND VERIFY DIMENSIONS AND	14
ш	COPYRIGHT:	2			24/09/2025			FACADE DESIGN:		FACADE CODE:	LEVELS PRIOR TO THE COMMENCEMENT OF ANY WORK. ALL	.Z
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		4					COUNCIL:	SHEET TITLE:	SHEET No.:	SCALES:	711107	late
						2 / - / 186811	SORELL	DETAILS (CLADDING)	10 / 19		714407	Lemp

WHERE DOWNPIPES ARE FURTHER THAN 1.2m AWAY FROM VALLEY REFER TO N.C.C. 7.3.5(2)

POSITION AND QUALITY OF DOWNPIPES ARE NOT TO BE ALTERED WITHOUT CONSULTATION WITH DESIGNER.

AREA'S SHOWN ARE SURFACE AREAS/ CATCHMENT AREAS, NOT PLAN AREAS

Roofi	ng Data	
	177.13	Flat Roof Area (excluding gutter and slope factor) (m²)
	192.43	Roof Surface Area (includes slope factor, excludes gutter) (m²)
Dowr	pipe roof	calculations (as per AS/NZA3500.3:2021)
Ah	187.50	Area of roof catchment (including 115mm Slotted Quad Gutter) (m²)
Ac	226.88	Ah x Catchment Area Multiplier for slope (Table 3.4.3.2 from AS/NZS 3500.3:2021) (1.21 for 23° pitch) (m²)
Ae	6300	Cross sectional area of 57 x 115 Slotted Quad Gutter (mm²)
DRI	86	Design Rainfall Intensity (determined from Table E1 from AS/NZS 3500.3:2021)
Acdp	64	Catchment area per Downpipe (determined from Figure 3.5(A) from AS/NZS 3500.3:2021) (m²)
Required Downpipes	3.54	Ac / Acdp
Downpipes Provided	6	

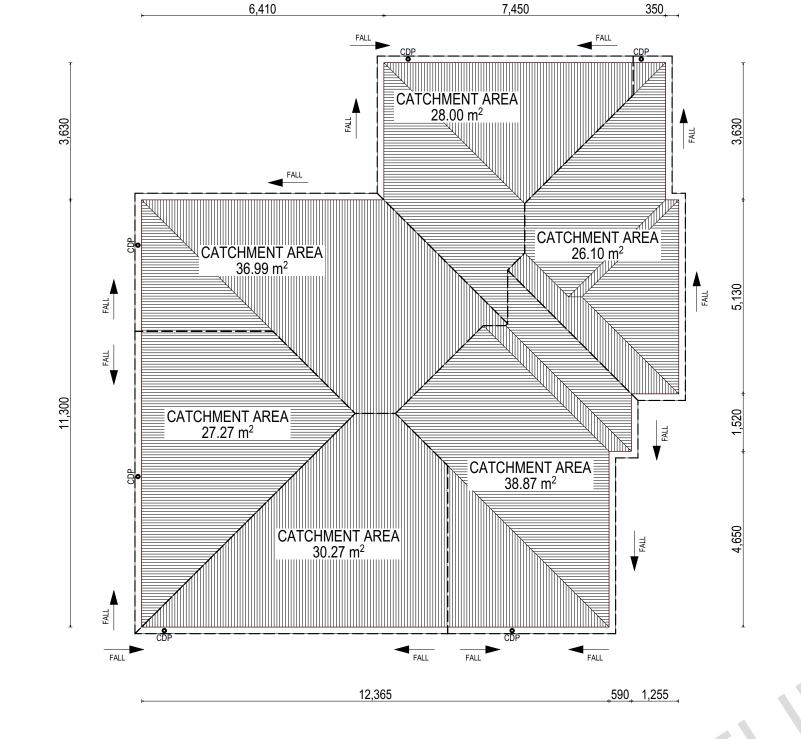



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Plans Reference: P1 Date Received: 10/11/2025

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SOFFIT EAVE VENT PROPOSED LOCATION TO BE MIN. 1M FROM CORNER JOINT

SUBJECT TO NCC 2022 (1 MAY 2023) WATERPROOFING & PLUMBING

PLAN ACCEPTANCE BY OWNER					
DATE:					
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\cap	DISCOVERY	1 DRAFT SALES PLAN - CT1	MLG 19/08/2025 AMBER LOUISE GADD 8	& ADRIAN JOHN BUTTERWORT	ASCOT 12		H-WDCASC10SA	FIGURED DIMENSIONS ONLY. CHECK AND VERIFY DIMENSIONS AND	140
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	© 2025	3 PRELIM PLANS - INITIAL ISSUE	TRV 22/10/2025 3 SPOONBILL LOOP, SO	PRELL TAS 7172	CLASSIC		F-WDCASC10CLASA	DISCREPANCIES TO BE REPORTED TO THE DRAFTING OFFICE.	/ersic
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			2 / - / 186811	SORELL	ROOF DRAINAGE PLAN	11 / 19	1:100	114401	Гетр

COVERINGS LEGEND

NO COVERING


COVER GRADE CONCRETE

CARPET

LAMINATE

TILE (STANDARD WET AREAS) TILE (UPGRADED AREAS)

DECKING

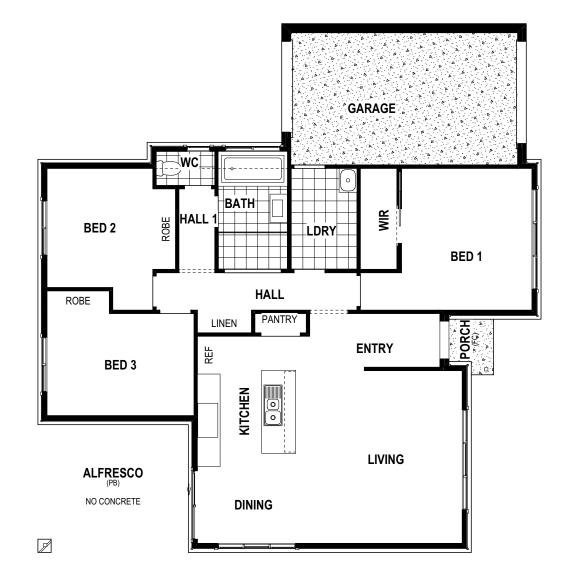



Sorell Council

Development Application: Development Application - 3 Spoonbill Loop, Sorell.pdf

Plans Reference: P1 Date Received: 10/11/202

SIGNATURE: DATE:

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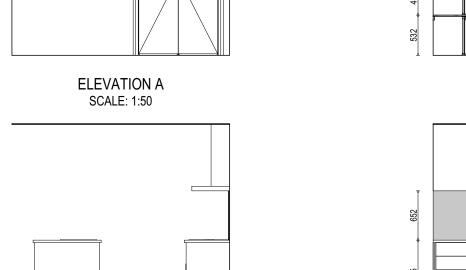
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	4		LOT / SECTION / CT: COUNCIL:	SHEET TITLE:	SHEET No.:	SCALES:	744407
			2 / - / 186811 SORELL	FLOOR COVERINGS	12 / 19	1:100	714407

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velopment Application: Development Application - 3 Spoonbill Loop, Sorell.pdf

Plans Reference: P1 Date Received: 10/11/2025



PANTRY


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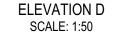
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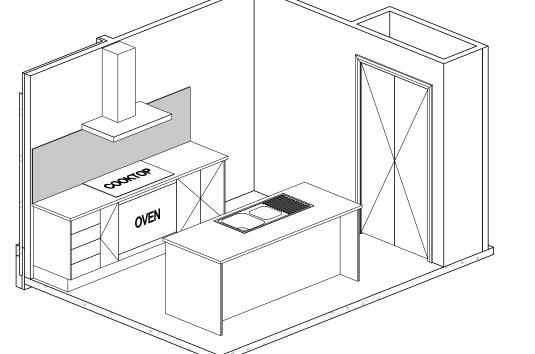
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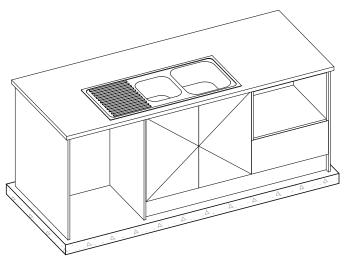







ELEVATION C

SCALE: 1:50

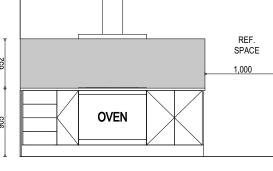

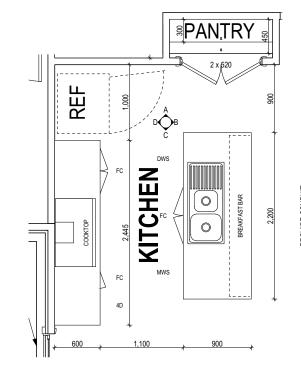

KITCHEN PLAN SCALE: 1:50

(1 MAY 2023) WATERPROOFING & PLUMBING


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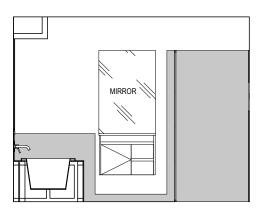
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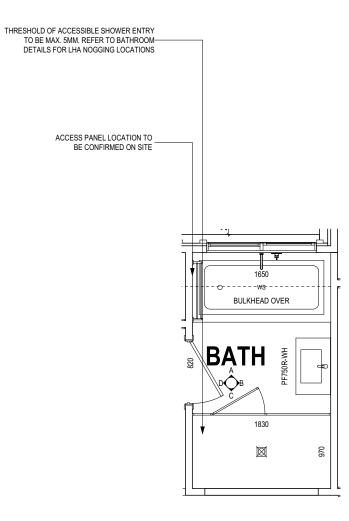
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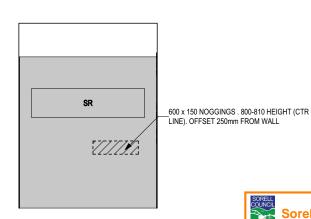
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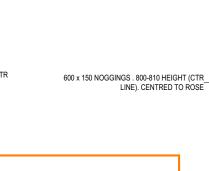
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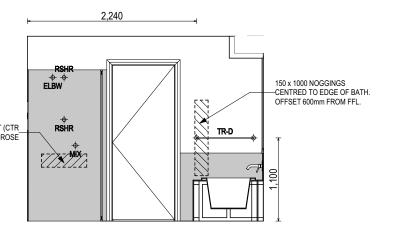
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ELEVATION C SCALE: 1:50



Sorell Council velopment Application: Development application - 3 Spoonbill Loop, Sorell.pdf Plans Reference: P1 Date Received: 10/11/2025



ELEVATION D SCALE: 1:50

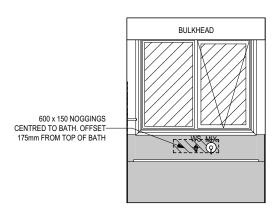BATHROOM PLAN SCALE: 1:50

_							
SHAMPOO	RECESS SIZE	STRUCTU	RAL DIMENSIONS				
		WIDTH	HEIGHT				
"SMALL"	470 x 380mm	548mm	446mm				
"MEDIUM"	800 x 380mm	878mm	446mm				
"LARGE"	1500 x 380mm	1578mm	446mm				
REFER WILSON HOMES' DETAIL G-WETA-TILE01 FOR							
FURTHER D	FTAIL PRIOR TO) INSTALLA	TION				

SUBJECT TO NCC 2022 (1 MAY 2023) WATERPROOFING & PLUMBING

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SIGNATURE:	DATE:
SIGNATURE:	DATE:
	ATIONS WILL NOT BE ACCEPTED

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			2 / - / 186811	SORELL	BATHROOM DETAILS	14 / 19	1:50	714407 Jagus

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ELBW CONNECTION MIX MIXER TAP HT HOT TAP CT COLD TAP HS HOB SPOUT WS WALL SPOUT SC STOP COCK TRH TOILET ROLL HOLDER TR-S TOWEL RAIL - SINGLE TR-D TOWEL RAIL - DOUBLE TL TOWEL LADDER TH TOWEL HOLDER TR TOWEL RACK TMB TUMBLER HOLDER


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SHLF SHELF


ROBE HOOK

SR SHAMPOO RECESS SOAP SOAP HOLDER


LEGEND

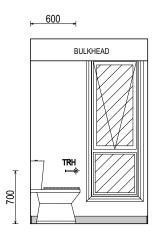


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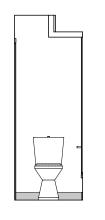


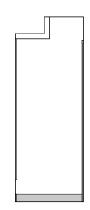ELEVATION B SCALE: 1:50

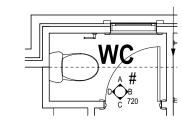

WC PLAN



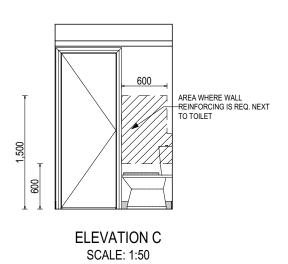

ELEVATION D SCALE: 1:50




Development Application: Development Application - 3 Spoonbill Loop, Sorell.pdf

Plans Reference: P1 Date Received: 10/11/2025


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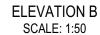
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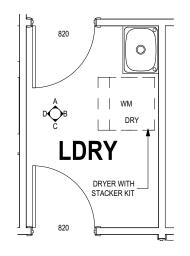



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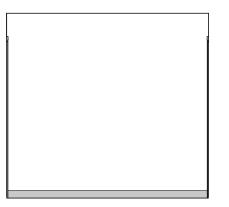




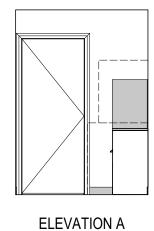

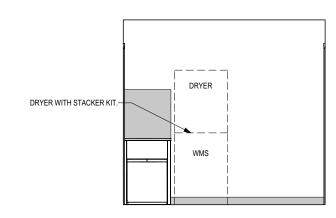

ELEVATION C SCALE: 1:50

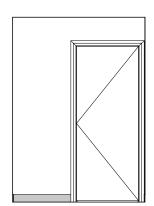

ELEVATION D SCALE: 1:50

(1 MAY 2023) WATERPROOFING & PLUMBING

PLAN ACCEPTA	PLAN ACCEPTANCE BY OWNER						
SIGNATURE:	DATE:						
SIGNATURE:	DATE:						
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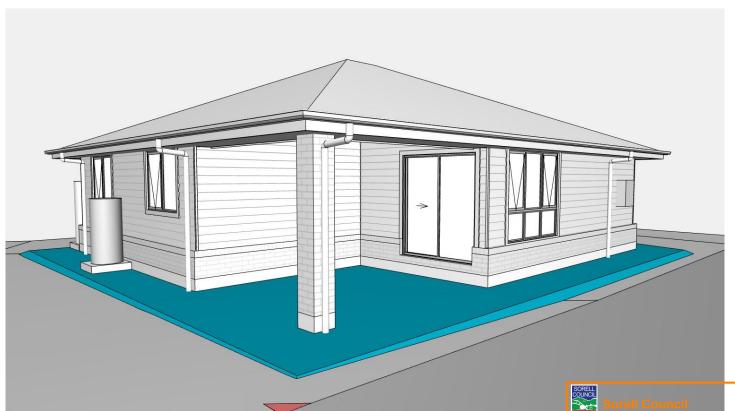


	SPECIFICATION:	REVISION	DRAWN	CLIENT:		HOUSE DESIGN:	HOUSE CODE:	DO NOT SCALE DRAWINGS, USE
N	DISCOVERY	1 DRAFT SALES PLAN - CT1	MLG 19/08/202	₃ AMBER LOUISE GADD {	& ADRIAN JOHN BUTTERWORT	ASCOT 12	H-WDCASC10SA	FIGURED DIMENSIONS ONLY. CHECK AND VERIFY DIMENSIONS AND LEVELS PRIOR TO THE
	COPYRIGHT:		1 1	ADDRESS:		FACADE DESIGN:	FACADE CODE:	COMMENCEMENT OF ANY WORK. ALL
	© 2025	3 PRELIM PLANS - INITIAL ISSUE	TRV 22/10/202	3 SPOONBILL LOOP, SO	DRELL TAS 7172	CLASSIC	F-WDCASC10CLASA	DISCREPANCIES TO BE REPORTED TO THE DRAFTING OFFICE.
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Development Application: Development Application - 3 Spoonbill Loop, Sorell.pdf

Plans Reference: P1 Date Received: 10/11/2025 REAR RIGHT

SIGNATURE: DATE:

PLAN ACCEPTANCE BY OWNER

SUBJECT TO NCC 2022 (1 MAY 2023) WATERPROOFING & PLUMBING

SIGNATURE: DATE:

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	SPECIFICATION:	REVISION		DRAWN	CLIENT:	HOUSE DESIGN:	HOUSE CODE:	DO NOT SCALE DRAWINGS, USE
10	DISCOVERY	DRAFT SALES PLAN - CT1	MLG	19/08/2025	AMBER LOUISE GADD & ADRIAN JOHN BUTTERWORT	ASCOT 12	H-WDCASC10SA	FIGURED DIMENSIONS ONLY. CHECK AND VERIFY DIMENSIONS AND
Ш		DRAFT SALES PLAN - CT1 AMENDMENTS	MFC	24/09/2025		FACADE DESIGN:	FACADE CODE:	LEVELS PRIOR TO THE COMMENCEMENT OF ANY WORK. ALL
)	© 2025	PRELIM PLANS - INITIAL ISSUE	TRV	22/10/2025	3 SPOONBILL LOOP, SORELL TAS 7172	CLASSIC	F-WDCASC10CLASA	DISCREPANCIES TO BE REPORTED TO THE DRAFTING OFFICE.
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- WHERE RAKED CEILINGS EXIST, IT IS HIGHLY RECCOMENDED THAT SUITABLE SPACING BETWEEN SARKING AND BULK INSULATION EXISTS. (NO CONTACT BETWEEN PRODUCTS). THE BUILDER IS TO ENSURE ADEQUATE SIZED TIMBER IS USED TO ENSURE THIS SEPARATION IS PROVIDED.
- IN STANDARD ROOF SPACES. IT IS HIGHLY RECOMMENDED TO PROVIDE SEPARATION BETWEEN SARKING AND CEILING INSULATION AROUND THE BUILDING PERIMETER, TO ENSURE AIRFLOW FROM EAVE VENTS IS MAINTAINED
- IT IS HIGHLY RECOMMENDED THAT ALL LIGHTWEIGHT CLADDING IS BATTENED OUT FROM STUDS (METAL / FC SHEET / TIMBER)

WOOD HEATERS

CONDENSATION

- ALL WOOD HEATERS ARE TO COMPLY WITH MANUFACTURERS SPECIFICATION AND NCC PART 12.4

FIRE SAFETY

- SMOKE ALARMS TO BE MAINS POWERED AND INSTALLED AS PER AS3786. LOCATIONS AS PER NCC 9.5.
- SMOKE ALARMS TO BE INTERCONNECTED WHERE THERE IS MORE THAN ONE ALARM
- INSTALLATION OF WOOD HEATERS TO COMPLY WITH AS2918. PROVIDE LOCAL AUTHORITIES WITH INSULATION AND **COMPLIANCE CERTIFICATES**

- WINDOWS TO BE ALUMINIUM FRAMED SLIDING UNLESS NOTED OTHERWISE
- ALL WINDOWS TO BE FABRICATED AND INSTALLED IN ACCORDANCE WITH AS1288 AND AS2047 TO SPECIFIC WIND SPEED AS PER ENGINEERS REPORT
- ALL OPENING WINDOWS TO COMPLY WITH NCC 8

WINDOWS

REQUIREMENTS

- AS PER NCC 11.3.6 ALL BEDROOM WINDOWS WHERE THE LOWEST OPENABLE PORTION OF THE WINDOW IS WITHIN 1.7m OF FFL AND THE FFL IS 2m OR MORE ABOVE NGL. REQUIRE A PERMANANTLY FIXED DEVICE RESTRICTING ANY OPENINGS OF THE WINDOW OR SCREEN SO THAT A 125mm SPHERE CANNOT PASS THROUGH: AND RESISTING OUTWARDS HORIZONTAL ACTION OF 250N AGAINST THE WINDOW. WHERE THE DEVICE OR SCREEN CAN BE REMOVED, UNLOCKED OR OVER-RIDDEN, THE DEVICE OR SCREEN MUST HAVE A CHILD RESISTANT RELEASE MECHANISM INSTALLED AND BARRIER BELOW THE WINDOW THAT IS 865mm HIGH ABOVE FFL AND RESTRICTS ANY OPENING WITHIN THE BARRIER SO THAT A 125mm SPHERE CANNOT PASS THROUGH, AND HAS NO HORIZONTAL OR NEAR HORIZONTAL ELEMENTS BETWEEN
- GLAZING INSTALLED IN AREAS WITH HIGH POTENTIAL FOR HUMAN IMPACT TO COMPLY WITH NCC PART 8.4

DRAINAGE / WATER

150mm AND 760mm FROM FFL.

- ROOF TO BE COLORBOND 'CUSTOM ORB' METALDECK UNLESS NOTED OTHERWISE. PROVIDED AND INSTALLED IN ACCORDANCE WITH AS1562.1 (IF TILED REFER TO AS2050)
 - PREFABRICATED ROOF TRUSSES TO BE SUPPLIED AND INSTALLED TO MANUFACTURERS SPECIFICATIONS, TRUSS MANUFACTURER TO CONFIRM LINTEL SIZES.

STAIRCASES / BALUSTRADES / HANDRAILS

- HANDRAIL REQUIRED WHERE CHANGE OF LEVEL BETWEEN

- NO GAPS IN STAIRCASES OR BALUSTRADE TO BE GREATER

BALUSTRADE REQUIRED WHERE LEVEL OF LANDING OR DECK

IS GREATER THAN 1000mm ABOVE ADJACENT GROUND LEVEL

BALUSTRADE TO BE MINIMUM 1000mm ABOVE FFL (INCLUDING

- DOORS OPENING OUTWARDS EXTERNALLY MUST OPEN TO A

NON-SLIP TREADS TO ALL TREADS AND TO COMPLY WITH NCC

DOORS. OPERATING DOOR LEAFS ARE TO BE SCREWED FIXED

- GLAZED BALUSTRADE AND HANDRAILS TO COMPLY WITH NCC

LANDING (MIN. 750mm WIDE) WHERE THE DIFFERENCE IN

WHERE LANDINGS ARE NOT NOMINATED TO EXTERNAL

SHUT, OR PROVIDED WITH A FORMED FCR LANDING

NOMINALLY 180mm BELOW FLOOR LEVEL.

PART 8.4, 11.3 AND AS1288 REQUIREMENTS

FLOOR / LANDINGS > 1m AS PER CURRENT NCC 11.3.5

240mm MIN. - 355mm MAX.

115mm MIN. - 190mm MAX.

ELECTRICAL

ROOFING

STAIR TREADS

STAIR RISERS

THAN 125mm

11.2.4

ANY FLOOR COVERINGS)

LEVELS IS GREATER THAN 570mm

- EXHAUST FAN TO COMPLY WITH CURRENT NCC PART 10.6.2 SECTION C
- EXHAUST FANS TO BE SEALED AND DUCTED TO OUTSIDE OF DWELLING IN ACCORDANCE WITH NCC VOLUME 2, PARTS 10.8.2 AND 10.8.3
- IF VENTING OCCURS DIRECTLY THROUGH WALLS/ROOF ADJACENT TO FAN. THEN UNIT REQUIRES SELF CLOSING BAFFLES TO BE CLASSIFIED AS A SEALED UNIT
- ELECTRICIAN IS TO ENSURE THAT ALL GPO'S IN WET AREAS MEET ALL STANDARD AND CODE REQUIREMENTS - ALL GPO'S TO BE 300mm FROM FFL UNLESS NOTED OTHERWISE

WET AREAS

- WALLS TO WET AREAS TO BE FINISHED WITH WET AREA PLASTERBOARD
- COMPLIANCE WITH NCC PART 10.2 AND AS3740
- ALL UNENCLOSED SHOWERS ABOVE BATHS TO HAVE MINIMUM 900mm SHOWER SCREEN OR FLOORWASTE WITHIN 1500mm OF SHOWER CONNECTION AS PER AS3740

OUSE DESIGN

ASCOT 12

FACADE DESIGN:

CLASSIC

SHEET TITLE:

GENERAL NOTES

SITE WORKS

GENERAL

CUT AND FILL BATTERS ARE INDICATIVE ONLY. BATTER TO COMPLY WITH THE NCC TABLE 3.2.1

BUILDER TO VERIFY ALL DIMENSIONS AND LEVELS ON SITE

ALL WORK TO BE CARRIED OUT IN ACCORDANCE WITH THE

INTERNAL DIMENSIONS ARE TO WALL FRAMING ONLY AND DO

PRIOR TO COMMENCEMENT OF WORK

NATIONAL CONSTRUCTION CODE (NCC)

NOT INCLUDE WALL LININGS

- ALL CUTS AND FFL'S SHOWN (DA DRAWINGS) ARE SUBJECT TO ENGINEERING ADVICE ONCE À SATISFACTORY SOIL TEST HAS BEEN RECEIVED AND REVIEWED
- ALL EMBANKMENTS THAT ARE LEFT EXPOSED MUST BE STABILISED WITH VEGETATION OR SIMILAR TO PREVENT
- EMBANKMENTS CANNOT EXCEED 2.0m IN HEIGHT WITHOUT THE AID OF RETAINING WALLS OR OTHER APPROVED TYPES OF SOIL RETAINING METHODS
- ALL UNPROTECTED EMBANKMENTS MUST COMPLY WITH THE SLOPE RATIOS FOR SOIL TYPE IN TABLE 3.2.1 OF THE NCC

SOIL TYPE /	EMBANKMENT OF SLOPE			
CLASSIFICATION	COMPACTED FILL	CUT		
STABLE ROCK (A)	3:3	8:1		
SAND (A)	1:2	1:2		
SILT (P)	1:4	1:4		
FIRM CLAY	1:2	1:1		
SOFT CLAY	NOT SUITABLE	2:3		
SOFT SOILS (P)	NOT SUITABLE	NOT SUITABLE		

MASONRY

- ALL MASONRY TO BE CONSTRUCTED IN ACCORDANCE WITH AS3700
- EXTERNAL WALLS TO BE 110mm BRICKWORK UNLESS NOTED OTHERWISE
- MORTAR MIXED @ 1:1:6 CEMENT:LIME:SAND UNLESS STATED OTHERWISE BY ENGINEER
- DAMP-PROOF COURSE IN ALL PERIMETER WALLS CUT INTO EXTERNAL WALLS BELOW FLOOR LEVEL WITH WEEP HOLES @ 1200 CTRS IN ACCORDANCE WITH AS2904
- VERTICAL ARTICULATION JOINTS TO BE PROVIDED @ 6m MAX. CTRS FOR UNREINFORCED MASONARY WALLS EXCEPT WHERE BUILT ON CLASS A OR S SOIL AND SPACED AS PER AS3700 SECTION 12.6.4. WILSON HOMES REQUEST THAT @ 5M
- WHERE NECESSARY, STEEL LINTELS ARE TO BE PROVIDED IN ACCORDANCE WITH AS4100 AND AS3700a

BRACING / LINTELS

AND MGP COMPONENTS

TIMBER FRAMING

CURRENT NCC

WITH AS1684

- WALL BRACING AS PER AS1684-2 2021 AND AS1170 WIND

- ALL WORK TO BE CARRIED OUT IN ACCORDANCE WITH THE

- ALL TIMBER FRAMING TO BE CARRIED OUT IN ACCORDANCE

- MGP10 PINE FRAMING OR F17 SOLID AND FINGER JOINED

FRAMING TO INTERNAL AND EXTERNAL WALLS. TIMBER

- GALVANISED WALL TIES TO MASONRY @ 450 CTRS

REDUCED BY 50% AROUND OPENINGS

FRAMING TO ALL STRUCTURAL COMPONENTS. 90 x 35mm

COMPOSITE ENGINEERED ROOF TRUSSES WITH HARDWOOD

HORIZONTALLY AND 600 CTRS VERTICALLY, WITH SPACING

- WALL BRACING AS SHOWN ON PLAN IS A MINIMUM ONLY. BUILDER TO PROVIDE ADDITIONAL BRACING TO SUIT THE CONSTRUCTION OF WALL FRAMES IN ACCORDANCE WITH GOOD BUILDING PRACTICE.
- PLYWOOD BRACING IN ACCORDANCE WITH AS1684 TABLE 8.18 (H) METHOD B. 900 WIDE SHEET PLY BRACING PANELS (6mm THICK F11 OR 4mm THICK F14) TO BE FIXED TO STUD FRAME WITH 2.8mm DIA x 30mm LONG MIN. FLAT HEAD NAILS.
- 65 x 19mm HW DIAGONAL TIMBER BRACING CHECKED INTO STUDS AND FIXED IN ACCORDANCE WITH AS1684

TIMBER LINTELS FOR SINGLE (OR UPPER STORY) TO BE F17 HARDWOOD AS FOLLOWS:

0 - 1500 120 x 35 1500 - 2400 140 x 35 2400 - 2700 190 x 35

TIEDOWN AND FIXING CONNECTIONS TO COMPLY WITH AS1684

STEEL LINTELS FOR SINGLE (OR UPPER STOREY) TO BE AS FOLLOWS:

0 - 2700 90 x 90 x 6 EA 2700 - 3200 100 x 100 x 8 EA 3200 - 4000 150 x 90 x 8 EA

*LINTELS REQUIRE 150mm BEARING EITHER SIDE OF OPENING

ALL LINTEL SIZES SHOWN ARE SUBJECT TO ENGINEERS DETAILS

CONCRETE

- CONCRETE FOOTING AND SLABS TO BE IN ACCORDANCE WITH AS2870
- CONCRETE TO BE MANUFACTURED TO COMPLY WITH AS3600 AND:
- HAVE A STRENGTH @ 28 DAYS OF NOT LESS THAN 25MpA (N25 GRADE)
- HAVE A 20mm NOMINAL AGGREGATE SIZE
- HAVE A NOMINAL 80mm SLUMP
- CONCRETE SLAB TO BE LAID OVER 0.2mm POLYTHENE MEMBRANE, 50mm WELL BEDDED SAND AND MINIMUM COMPACTED FCR (20mm)
- SLAB THICKNESS AND REINFORCEMENT TO BE AS PER ENGINEERS DESIGN

- DRAINAGE TO BE DESIGNED AND CONSTRUCTED IN ACCORDANCE WITH AS3500 AND LOCAL AUTHORITY
- STORMWATER PIPES TO BE UPVC CLASS HD
- SEWER PIPES TO BE UPVC CLASS SH
- PROVIDE Ø20mm K2 POLYETHYLENE WATER RETICULATION
- TYPE B STOP VALVE TO BE LOCATED ADJACENT TO ENTRY
- BACKFILL ALL TRENCHES BENEATH VEHICLE PAVEMENT AND SLABS ON GRADE TO FULL DEPTH WITH 20 FCR
- PROVIDE OVERFLOW RELIEF GULLY WITH TAP OVER. INVERT LEVEL TO BE 150 MIN. BELOW LOWEST SANITARY DRAINAGE POINT
- CUT AND BATTER ARE INDICATIVE. BATTER TO COMPLY WITH **CURRENT NCC TABLE 3.1.1.1**
- AG DRAIN REQUIRED AROUND PERIMETER OF DWELLING FOR ALL CLASS M, H, E SITES. LOCATE AG DRAIN NOT CLOSER THAN 1.5m FROM FOOTINGS IN ACCORDANCE WITH AS2870 SECTION 5.6
- PROVIDE SURFACE DRAINAGE IN ACCORDANCE WITH AS2870 SECTION 5.6.3
- PROVIDE FLEXIBLE JOINTS IN ALL DRAINAGE EMERGING FROM UNDERNEATH OR ATTACHED TO BUILDING IN ACCORDANCE WITH AS2870 SECTION 5.6.4 FOR ALL CLASS H AND E SITES. REFER TO GEOTECH FOR FURTHER INFORMATION
- DOWNPIPES AND GUTTERS DESIGNED IN ACCORDANCE WITH AS/NZS 3500 3

Sorell Council

evelopment Application: Development Application - 3 Spoonbill Loop, Sorell.pdf

Plans Reference: P1 ate Received: 10/11/2029

H-WDCASC10SA

F-WDCASC10CLASA

FACADE CODE:

SCALES:

SHEET No :

18 / 19

SUBJECT TO NCC 2022 (1 MAY 2023) WATERPROOFING & PLUMBING

DI AN ACCEDTANCE DV OWNED

PLAN ACCEPTANCE DE OWNER			
SIGNATURE:	DATE:		
SIGNATURE:	DATE:		
PLEASE NOTE THAT VARIATION			

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SPECIFICATION REVISION DRAWN MLG 19/08/2025 AMBER LOUISE GADD & ADRIAN JOHN BUTTERWORT DISCOVERY DRAFT SALES PLAN - CT1 MFC 24/09/2025 ADDRESS: 2 DRAFT SALES PLAN - CT1 AMENDMENTS TRV 22/10/2025 3 SPOONBILL LOOP, SORELL TAS 7172 3 PRELIM PLANS - INITIAL ISSUE LOT / SECTION / CT: COUNCIL 2 / - / 186811 SORELL

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WET AREA NOTES VESSELS OR AREA WHERE FLOORS AND WALLS PENETRATIONS WALL JUNCTIONS AND JOINTS THE FIXTURE IS INSTALLED HORIZONTAL SURFACES WATERPROOF ENTIRE ENCLOSED ENCLOSED SHOWER WITH HOB WATERPROOF TO NOT LESS THAN 150mm ABOVE THE WATERPROOF INTERNAL AND EXTERNAL WATERPROOF ALL SHOWER FLOOR SUBSTRATE OR NOT LESS THAN 25mm SHOWER AREA INCLUDING HOR CORNERS AND HORIZONTAL JOINTS WITHIN A PENETRATIONS ABOVE THE MAXIMUM RETAINED WATER LEVEL WHICH HEIGHT OF 1800mm ABOVE THE FLOOR LEVEL WITH NOT LESS THAN 40mm WIDTH EITHER EVER IS THE GREATER WITH THE REMAINDER BEING SIDE OF THE JUNCTION. WATERPROOF TO A HEIGHT OF NOT LESS THAN 1800mn

ABOVE THE FINISHED FLOOR LEVEL WATERPROOF ALL ENCLOSED SHOWER WITHOUT HOB WATERPROOF ENTIRE ENCLOSED WATERPROOF TO NOT LESS THAN 150mm ABOVE THE WATERPROOF INTERNAL AND EXTERNAL SHOWER FLOOR SUBSTRATE WITH THE REMAINDER CORNERS AND HORIZONTAL JOINTS WITHIN A SHOWER AREA. INCLUDING PENETRATIONS BEING WATERPROOF TO A HEIGHT OF NOT LESS THAN HEIGHT OF 1800mm ABOVE THE FLOOR LEVEL 1800mm ABOVE THE FINISHED FLOOR LEVEL WITH NOT LESS THAN 40mm WIDTH EITHER SIDE OF THE JUNCTION. WATERPROOF ALL ENCLOSED SHOWER WITH STEPDOWN WATERPROOF ENTIRE ENCLOSED WATERPROOF TO NOT LESS THAN 150mm ABOVE THE WATERPROOF INTERNAL AND EXTERNAL SHOWER AREA INCLUDING THE SHOWER FLOOR SUBSTRATE OR NOT LESS THAN 25mm CORNERS AND HORIZONTAL JOINTS WITHIN A PENETRATIONS. STEPDOWN. ABOVE THE MAXIMUM RETAINED WATER LEVEL HEIGHT OF 1800mm ABOVE THE FLOOR LEVEL WHICHEVER IS THE GREATER WITH THE REMAINDER WITH NOT LESS THAN 40mm WIDTH EITHER BEING WATERPROOF TO A HEIGHT OF NOT LESS THAN SIDE OF THE JUNCTION.

1800mm ABOVE THE FINISHED FLOOR LEVEL WATERPROOF INTERNAL AND EXTERNAL ENCLOSED SHOWER WITH PRE-FORMED N/A WATERPROOF TO A HEIGHT OF NOT LESS THAN 1800mm SHOWER BASE ABOVE FINISHED FLOOR LEVEL. CORNERS AND HORIZONTAL JOINTS WITHIN A HEIGHT OF 1800mm ABOVE THE FLOOR LEVEL WITH NOT LESS THAN 40mm WIDTH EITHER SIDE OF THE JUNCTION.

UNENCLOSED SHOWERS WATERPROOF ENTIRE UNCLOSED WATERPROOF TO NOT LESS THAN 150mm ABOVE THE WATERPROOF INTERNAL AND EXTERNAL WATERPROOF ALL SHOWER AREA SHOWER FLOOR SUBSTRATE OR NOT LESS THAN 25mm CORNERS AND HORIZONTAL JOINTS WITHIN A PENETRATIONS ABOVE THE MAXIMUM RETAINED WATER LEVEL WHICH HEIGHT OF 1800mm ABOVE THE FLOOR LEVEL EVER IS THE GREATER WITH THE REMAINDER BEING WITH NOT LESS THAN 40mm WIDTH EITHER SIDE OF THE JUNCTION.

WATERPROOF TO A HEIGHT OF NOT LESS THAN 1800mm ABOVE THE FINISHED FLOOR LEVEL. AREAS OUTSIDE THE SHOWER AREA FOR WATER RESISTANT TO ENTIRE FLOOR. WATERPROOF ALL WALL/FLOOR JUNCTIONS. N/A CONCRETE AND COMPRESSED FIBRE WHERE A FLASHING IS USED THE HORIZONTAL CEMENT SHEET FLOORING LEG MUST BE NOT LESS THAN 40mm. AREAS OUTSIDE THE SHOWER AREA FOR WATERPROOF ENTIRE FLOOR. N/A WATERPROOF ALL WALL/FLOOR JUNCTIONS. TIMBER FLOORS INCLUDING WHERE A FLASHING IS USED THE HORIZONTAL PARTICLEBOARD, PLYWOOD AND OTHER LEG MUST BE NOT LESS THAN 40mm. TIMBER BASED EL CORING MATERIALS

AREAS ADJACENT TO BATHS AND SPAS FOR WATER RESISTANT TO ENTIRE FLOOR WATERPROOF TO A HEIGHT OF NOT LESS THAN 150mm WATERPROOF EDGES OF THE VESSEL AND WATERPROOF ALL TAP AND CONCRETE AND COMPRESSED FIBRE ABOVE THE VESSEL AND EXPOSED SURFACES BELOW JUNCTION OF BATH ENCLOSURE WITH FLOOR. SPOUT PENETRATIONS CEMENT SHEET FLOORING. THE VESSEL LIP TO FLOOR LEVEL WHERE THE LIP OF THE BATH IS SUPPORTED VHERE THEY OCCUR IN A BY A HORIZONTAL SURFACE, THIS MUST BE HORIZONTAL SURFACE WATERPROOF FOR SHOWERS OVER BATH AND WATER RESISTANT FOR ALL OTHER CASES.

AREAS ADJACENT TO BATHS AND SPAS (SEE | WATERPROOF ENTIRE FLOOR WATERPROOF TO A HEIGHT OF NOT LESS THAN 150mm WATERPROOF EDGES OF THE VESSEL AND WATERPROOF ALL TAP AND SPOUT PENETRATIONS NOTE 1) FOR TIMBER FLOORS INCLUDING ABOVE THE VESSEL AND EXPOSED SURFACES BELOW JUNCTION OF BATH ENCLOSURE WITH FLOOR. PARTICLEBOARD, PLYWOOD AND OTHER THE VESSEL LIP TO FLOOR LEVEL. WHERE THE LIP OF THE BATH IS SUPPORTED WHERE THEY OCCUR IN A TIMBER BASED FLOORING MATERIALS. BY A HORIZONTAL SURFACE. THIS MUST BE IORIZONTAL SURFACE. WATERPROOF FOR SHOWERS OVER BATH AND WATER RESISTANT FOR ALL OTHER CASES. INSERTED BATHS WATERPROOF ALL TAP AND N/A FOR FLOOR LINDER BATH, ANY N/A FOR WALL LINDER BATH WATERPROOF TO NOT N/A FOR WALL UNDER BATH, WATERPRROF TO

SHELF AREA ADJOINING THE BATH OR NOT LESS THAN 150 mm ABOVE THE LIP OF A SPOUT PENETRATIONS LESS THAN 150mm ABOVE THE LIP OF THE BATH. SPA MUST BE WATERPROOF AND BATH OR SPA. WHERE THEY OCCUR IN A INCLUDE A WATERSTOP UNDER THE HORIZONTAL SURFACE. VESSEL LIP WALLS ADJOINING OTHER VESSELS (EG. N/A WATERPROOF TO A HEIGHT OF NOT LESS THAN 150mm WHERE THE VESSEL IS FIXED TO A WALL WATERPROOF ALL TAP AND SINKS, LAUNDRY TUBS AND BASINS) ABOVE THE VESSEL IF THE VESSEL IS WITHIN 75mm OF WATERPROOF EDGES FOR EXTENT OF VESSEL POUT PENETRATIONS THE WALL WHERE THEY OCCUR IN A

HORIZONTAL SURFACE LAUNDRIES AND WCS WATER RESISTANT TO ENTIRE FLOOR. WATERPROOF ALL WALL/FLOOR JUNCTIONS TO NOT WATERPROOF ALL WALL/FLOOR JUNCTIONS. LESS THAN 25mm ABOVE THE FINISHED FLOOR LEVEL, WHERE A FLASHING IS USED THE HORIZONTAL LEG MUST BE NOT LESS THAN 40mm. SEALED TO FLOOR

THE ABOVE INFORMATION IS FOR GENERAL GUIDANCE AND IS INDICATIVE ONLY. WATERPROOFING INSTALLERS TO COMPLY WITH ALL CURRENT CODES OF LEGISLATION WHICH TAKE PRECEDENCE OVER THIS SPECIFICATION.

WET AREA WAERPROOFING BY LICENSED AND ACCREDITED INSTALLER. CERTIFICATION TO BE PROVIDED TO BUILDING SURVEYOR. CONTRACTOR OR BUILDER TO DETERMINE THE APPROPRIATE WATERPROOFING IN ACCORDANCE WITH AS3740 PART 10.2 OF N.C.C. AND TO NOTIFY THE RUIL DING SURVEYOR FOR INSPECTION ARRANGEMENTS DURING INSTALLATION.

ENERGY EFFICIENCY - GENERAL

STATED R VALUES ARE FOR ADDITIONAL INSULATION REQUIRED AND ARE NOT RT VALUES (TOTAL SYSTEM VALUE)

INSULATION TO BE INSTALLED TO MANUFACTURERS SPECIFICATIONS AND ANY RELEVANT STANDARDS

BULK INSULATION IS NOT TO BE COMPRESSED AS THIS REDUCES THE EFFECTIVE R RATING

IN TASMANIA. FOR NCC PART H6 REFER TO NCC 2019 AMENDMENT 1 PART 2.6; FOR NCC PART 13.1 REFER TO NCC 2019 PART 3.12

N.C.C 2019 3.12.0 (A)

N.C.C 2022 TAS PART H6

PERFORMANCE REQUIREMENT P2.6.1 FOR THE THERMAL PERFORMANCE OF THE BUILDING IS SATISFIED BY COMPLYING WITH

3.12.0.1 - FOR REDUCING THE HEATING AND COOLING LOADS TO REDUCE HEATING AND COOLING LOADS MUST ACHIEVE AN ENERGY

RATING USING HOUSING ENERGY RATING SOFTWARE OF NOT LESS THAN 6

3.12.1.1 - FOR BUILDING FABRIC THERMAL INSULATION

BUILDER TO ENSURE THAT ALL INSULATION COMPLIES WITH AS/NZS 4859.1 AND BE INSTALLED TO N.C.C 3.12.1.1

3.12.1.2(e) - FOR COMPENSATING FOR A LOSS OF CEILING INSULATION REFER TO ATTACHED THERMAL PERFORMANCE CERTIFICATE

- (i) IF ALLOWANCE HAS BEEN MADE FOR CEILING PENERATIONS IN NATHERS (FIRST RATE 5) CERTIFICATION PROCESS THEN NO FURTHER ACTION REQUIRED.
- (ii) IF NO ALLOWANCE HAS BEEN MADE FOR CEILING PENETRATIONS IN NATHERS (FIRST RATE 5) CERTIFICATION PROCESS THEN CEILING PENETRATION AREA MUST BE CALCULATED AND THE NECESSARY ADJUSTMENT MADE TO THE SPECIFIED INSULATION AS PER TABLE 3.12.1.1B OF NCC

3.12.1.5(c) AND 3.12.1.5(d) - FOR FLOOR EDGE INSULATION FOR CONCRETE SLAB ON GROUNG WITH IN SLAB HEATING OR COOLING.

3.12.3 - FOR BUILDING SEALING

3.12.3.1 - CHIMNEYS AND FLUES

THE CHIMNEY OR FLUE OF AN OPEN SOLID FUEL BURNING APPLIANCE MUST BE PROVIDED WITH A DAMPER OR FLAP THAT CAN BE CLOSED TO SEAL THE

- 3.12.3.2 ROOF LIGHTS
 (a) A ROOF LIGHT MUST BE SEALED, OR CAPABLE OF BEING SEALED WHEN
 - (i) A CONDITIONED SPACE; OR
 - A HABITABLE ROOM IN CLIMATE ZONES 4, 5, 6, 7 OR 8
- (b) A ROOF LIGHT REQUIRED BY (a) TO BE SEALED, OR CAPABLE OF BEING SEALED MUST BE CONSTRUCTED WITH:
- (i) AN IMPERFORATE CEILING DIFFUSER OR THE LIKE INSTALLED AT A CEILING OR INTERNAL LINING LEVEL; OR
- (ii) A WATERPROOF SEAL; OR

Sorell Council

Plans Reference: P1 ate Received: 10/11/202

elopment Application: Development

ASCOT 12

FACADE DESIGN

CLASSIC

SHEET TITLE:

WET AREA & ENERGY EFFICIENCY NOTES 19 / 19

pplication - 3 Spoonbill Loop, Sorell.pdf

(iii) A SHUTTER SYSTEM READILY OPERATED MANUALLY, MECHANICALLY OR ELECTRONICALLY BY THE OCCUPANT

- 3.12.0.1 EXTERNAL WINDOWS AND DOORS

 (a) A SEAL TO RESTRIC AIR INFILTRATION MUST BE FITTED TO EACH OF AN EXTERNAL DOOR, OPENABLE WINDOW AND OTHER SUCH OPENING
- WHEN SERVING A CONDITIONED SPACE; OR
- (II) IN CLIMATE ZONES 4, 5, 6, 7 OR 8, WHEN SERVING A HABITABLE ROOM
- (b) A WINDOW COMPLYING WITH THE MAXIMUM AIR INFILTRATION RATES. SPECIFIED IN AS2047 NEED NOT COMPLY WITH (a).
- (c) A SEAL REQUIRED BY (a)

WAFFLE POD ALLOWANCES:

R0.6 - 175mm DEEP

R0 7 - 225mm DEEP

- R0.8 - 300mm DEEF

- R0.9 - 375mm DEEP

- (i) FOR THE BOTTOM EDGE OF AN INTERNAL SWING DOOR, MUST BE A DRAFT PROTECTION DEVICE; AND
- (ii) FOR THE OTHER EDGES OF AN EXTERNAL SWING DOOR OR THE EDGES OF AN OPENABLE WINDOW OR OTHER SUCH OPENING MAY BE A FOAM OR RUBBER COMPRESSIBLE STRIP, FIBROUS SEAL OR

3.12.3.4 - EXHAUST FANS

AN EXHAUST FAN MUST BE FITTED WITH A SEALING DEVICE SUCH AS A SELF CLOSE DAMPER, FILTER OR THE LIKE WHEN SERVING:

(a) A CONDITIONED SPACE: OR

(b) A HABITABLE ROOM IN THE CLIMATE ZONES 4, 5, 6, 7 OR 8.

3.12.3.5 - CONSTRUCTION OF ROOF, WALLS AND FLOORS

- (a) ROOFS, EXTERNAL WALLS, EXTERNAL FLOORS AND AN OPENING SUCH AS A WINDOW FRAME, DOOR FRAME, ROOF LIGHT FRAME OR THE LIKE MUST BE CONSTRUCTED TO MINIMISE AIR LEAKAGE IN ACCORDANCE WITH (b) WHEN FORMING PART OF THE EXTERNAL FABRIC OF:
 - (i) A CONDITIONED SPACE; OR
 - (ii) A HABITABLE ROOM IN CLIMATE ZONE 4, 5, 6, 7 OR 8.
- (b) CONSTRUCTION REQUIRED BY (a) MUST BE:
- ENCLOSED BY AN INTERNAL LINING SYSTEM THAT ARE CLOSE FITTING AT CEILING, WALL AND FLOOR JUNCTIONS; OR
- (ii) SEALED BY CAULKING, SKIRTING, ARCHITRAVES, CORNICES OR THE

3.12.3.6 - EVAPORATIVE COOLERS

AN EVAPORATIVE COOLER MUST BE FITTED WITH A SELF CLOSING DAMPER OR THE LIKE WHEN SERVING:

(a) A HEATED SPACE: OR

(b) A HABITABLE ROOM IN CLIMATE ZONES 4 5 6 7 OR 8

3.12.5.5 - ARTIFICIAL LIGHTING

SHEET No.

- (a) LAMP POWER DENSITY OR ILLUMINATION POWER DENSITY OF AN ARTIFICIAL LIGHT, EXCLUDING HEATING THAT EMITS LIGHT, MUST NOT EXCEED THE ALLOWANCE OF
- (i) 5W/m2 IN A CLASS 1 BUILDING
- (ii) 4W/m² ON A VERANDAH, BALCONY OR THE LIKE ATTACHED TO A CLASS 1 BUILDING (NOT EXCLUDING EAVE PERIMETER LIGHTS); (iii) 3W/m² IN A CLASS 10A BUILDING ASSOCIATED WITH A CLASS 1
- BUILDING.
- (b) THE ILLUMINATION POWER DENSITY ALLOWANCE IN (a) MAY BE INCREASED BY DIVIDING IT BY THE ILLUMINATION POWER DENSITY ADJUSTMENT FACTOR FOR A CONTROL DEVICE AS PER N.C.C TABLE 3.12.5.3

SUBJECT TO NCC 2022 (1 MAY 2023)

WATERPROOFING & PLUMBING

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ENETRATIONS.

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