

NOTICE OF PROPOSED DEVELOPMENT

Notice is hereby given that an application has been made for planning approval for the following development:

SITE:

LOT 32 OAKMONT ROAD, MIDWAY POINT - ADJOINING 7 OAKMONT ROAD, MIDWAY POINT

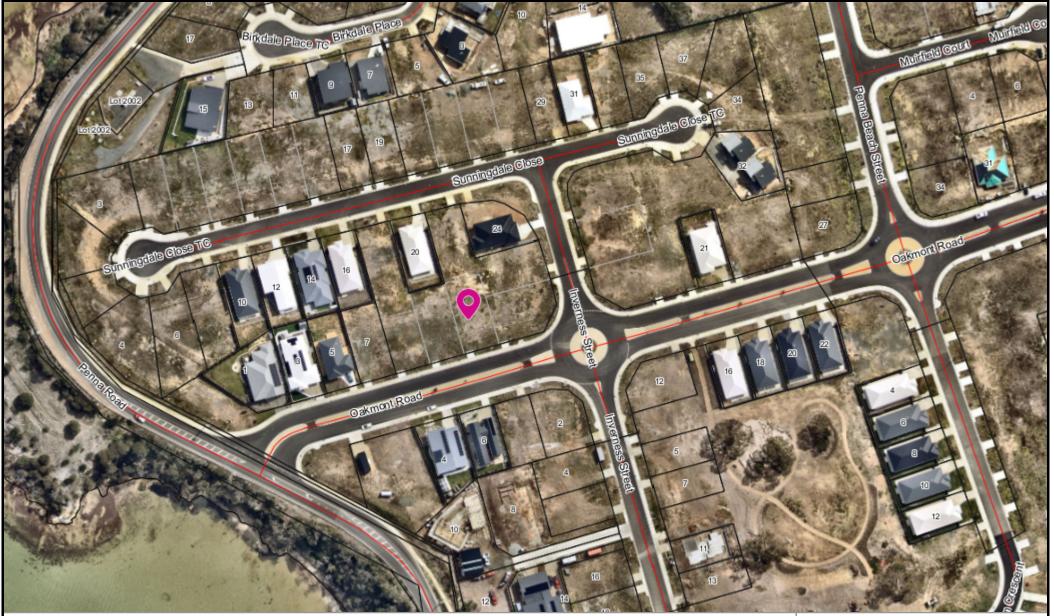
PROPOSED DEVELOPMENT: DWELLING

The relevant plans and documents can be inspected at the Council Offices at 47 Cole Street, Sorell during normal office hours, or the plans may be viewed on Council's website at www.sorell.tas.gov.au until Monday 24th November 2025.

Any person may make representation in relation to the proposal by letter or electronic mail (sorell.council@sorell.tas.gov.au) addressed to the General Manager. Representations must be received no later than Monday 24th November 2025.

APPLICATION NO: 5.2025-278.1

DATE: 31 OCTOBER 2025





Disclaimer

Any information extracted from this document (from the face of the document or by scale) should be verified on site. Council takes no responsibility for the accuracy of any information contained or presented in the document. While every care has been taken to ensure the accuracy of this information, Council makes no representations or warranties about the accuracy, reliability, completeness or suitability for any particular purpose and disclaims all responsibility and liability.

50 m

6-Nov-2025

Part B: Please note that Part B of this form is publicly exhibited.

Full description of Proposal:	Use:				
55 p 5.50	Development:				
	Large or complex proposals s	should be	described	in a letter or planning report.	
Design and con	struction cost of proposal:		\$		
Is all, or some th	ne work already constructed	:	No: 🗆	Yes: □	
Location of proposed	Street address:				
works:				code:	
	Certificate of Title(s) Volum	ne:		Folio:	
Current Use of Site					
Current Owner/s:	Name(s)				
Is the Property on the Tasmanian Heritage Register? No: □ Yes: □			If yes, please provide written advice from Heritage Tasmania		
Is the proposal to be carried out in more than one stage?		No: □	Yes: □	If yes, please clearly describe in plans	
Have any potentially contaminating uses been undertaken on the site? No: Yes: If yes, please complete the Additional Information for Non-Residential Use			If yes, please complete the Additional Information for Non-Residential Use		
Is any vegetation proposed to be removed?			Yes: □	If yes, please ensure plans clearly show area to be impacted	
Does the proposal involve land administered or owned by either the Crown or Council? No: Yes: If yes, please complete the Council or Crown land section on page 3			If yes, please complete the Council or Crown land section on page 3		
, ,	ded vehicular crossing is requi			• • •	
•	hicular Crossing (and Associa			cation form	
HLLPS://WWW.SO	https://www.sorell.tas.gov.au/services/engineering/				

Sorell Council

Development Application: 5.2025.278.1 -Development Application - 32 Oakmont Road, Midway Point P1.pdf Plans Reference:P1 Date Received:10/10/2025

Declarations and acknowledgements

- I/we confirm that the application does not contradict any easement, covenant or restriction specified in the Certificate of Title, Schedule of Easements or Part 5 Agreement for the land.
- I/we consent to Council employees or consultants entering the site and have arranged permission and/or access for Council's representatives to enter the land at any time during normal business hours.
- I/we authorise the provision of a copy of any documents relating to this application to any person for the purposes of assessment or public consultation and have permission of the copyright owner for such copies.
- I/we declare that, in accordance with s52(1) of the Land Use Planning and Approvals Act 1993, that I have notified the owner(s) of the intention to make this application.
- I/we declare that the information in this application is true and correct.

Details of how the Council manages personal information and how you can request access or corrections to it is outlined in Council's Privacy Policy available on the Council website.

- I/we acknowledge that the documentation submitted in support of my application will become a public record held by Council and may be reproduced by Council in both electronic and hard copy format in order to facilitate the assessment process, for display purposes during public exhibition, and to fulfil its statutory obligations. I further acknowledge that following determination of my application, Council will store documentation relating to my application in electronic format only.
- Where the General Manager's consent is also required under s.14 of the *Urban Drainage Act 2013*, by making this application I/we also apply for that consent.

Applicant Signature:	Signature: Lutzia Brown Date:
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Crown or General Manager Land Owner Consent

If the land that is the subject of this application is owned or administered by either the Crown or Sorell Council, the consent of the relevant Minister or the Council General Manager whichever is applicable, must be included here. This consent should be completed and signed by either the General Manager, the Minister, or a delegate (as specified in s52 (1D-1G) of the *Land Use Planning and Approvals Act 1993*).

Please note:

- If General Manager consent if required, please first complete the General Manager consent application form available on our website www.sorell.tas.gov.au
- If the application involves Crown land you will also need a letter of consent.
- Any consent is for the purposes of making this application only and is not consent to undertaken work or take any other action with respect to the proposed use or development.

I		being responsible for the
administration of land at		Sorell Council
declare that I have given permis	Development Application: 5.2025.278.1 - Development Application - 32 Oakmont Road, Midway Point P1.pdf Plans Reference:P1 Date Received:10/10/2025	
Signature of General Manager, Minister or Delegate:	Signature:	Date:

DISPERSIVE SOIL ASSESSMENT

Lot 32 Oakmont Road Midway Point June 2025

Wilson Homes Reference: 714358







GEO-ENVIRONMENTAL

SOLUTIONS



Disclaimer: The author does not warrant the information contained in this document is free from errors or omissions. The author shall not in any way be liable for any loss, damage or injury suffered by the User consequent upon, or incidental to, the existence of errors in the information.



Investigation Details

Client: Wilson Homes

Site Address: Lot 32 Oakmont Road, Midway Point

Date of Inspection: 23/06/2025

Proposed Works: New house

Investigation Method: Geoprobe 540UD - Direct Push

Inspected by: C. Cooper

Site Details

Certificate of Title (CT): TBA

Title Area: Approx. 529 m²

Applicable Planning Overlays: Bushfire-prone areas, Airport obstacle limitation area

Slope & Aspect: 6° W facing slope

Vegetation: Grass & Weeds

Background Information

Geology Map: MRT

Geological Unit: Triassic Sandstone

Climate: Annual rainfall 400mm

Water Connection: Mains

Sewer Connection: Serviced-Mains

Testing and Classification: AS2870:2011, AS1726:2017 & AS4055:2021



Investigation

A number of bore holes were completed to identify the distribution and variation of the soil materials at the site, bore hole locations are indicated on the site plan. See soil profile conditions presented below. Tests were conducted across the site to obtain bearing capacities of the material at the time of this investigation.

Soil Profile Summary

BH 1 Depth (m)	BH 2 Depth (m)	USCS	Description
0.00-0.10	0.00-0.10	SP	Silty SAND: grey, brown, dry, loose
0.10-0.40	0.10-0.60	CI	Sandy CLAY: medium plasticity, brown, yellow mottled grey, slightly moist, stiff,
0.40-1.10	0.60-0.80	CL	Sandy CLAY: medium plasticity, brown mottled pale grey, slightly moist, stiff,
1.10-1.30	0.80-0.90	SC	Clayey SAND: with gravels, pale yellow, pale grey, slightly moist dense, refusal on sandstone

Site Notes

The soil on site has formed from Triassic sandstone. The subsoil was tested for dispersion using the Emerson Test and was found to be slightly dispersive Class 2(2) -obvious milkiness, <50% of the aggregate affected.

Dispersive Soil Assessment

The dispersive soil assessment of the property considers the proposed construction area.

Potential for dispersive soils

The site has been identified as an area subject to tunnel erosion hazard according to 'Dispersive Soils and Their Management: Technical Reference Manual'. This is due to the soils present on site that developed from Triassic Sandstone that contain considerable fine sand/silt content and medium plastic clays. Triassic Sandstone in the local area is known to produce soils with an excess of sodium on the soil exchange complex, which can cause soil dispersion. Under some circumstances the presence of dispersive soils can also lead to significant erosion, and in particular tunnel erosion. Based upon field survey of the property, no visible tunnel or gully erosion was identified. However, a soil sampling program was undertaken to identify the presence of dispersive soils in the proposed development areas.

Soil sampling and testing

Samples were taken at the site for assessment of dispersion. An Emerson (1968) Dispersion test was conducted to determine if these samples were dispersive.

The soil samples taken from site were found to be Slightly dispersive Class 2(2) -obvious milkiness, <50% of the aggregate affected.



Management Recommendations

A number of site and soil management measures are recommended for development on the site.

The proposed site cut/fill and driveway areas must be managed by:

- Applying a geo-fabric, jute mesh or similar material to the exposed batters of any cutting on site and revegetating the slope
- Applying a surface layer of at least 50mm of suitable crushed rock/gravel to the driveway surface (and any proposed house pad), with adequate compaction to ensure a relatively impervious surface to maintain site surface stability
- Vegetation on any fill batters must be established and maintained, if any bare area of soil on the batter
 develops then it must be top-dressed with suitable topsoil and additional vegetation planted

The risk or erosion and tunnel erosion associated with construction must be minimized by:

- Any new water, power, or other service trenches within the property must ensure recommendations for dispersive soils are followed:
- o Where possible trenches to be placed shallow in topsoil and mounded over to achieve the required cover depth
- o If buried the trench must be backfilled in layers of no more than 200mm with clay with 5% by weight gypsum added (the clay must be sufficiently moist to allow good compaction).
- o The trench must be finished with at least 150mm depth of non-dispersive suitable topsoil and finished to a level at least 75mm above natural ground to allow for possible settlement
- Vegetation cover must be maintained wherever possible on the property
- Foundations may be placed into the natural soil; however, care must be taken to ensure all exposed soil in the foundation area is compacted and 1Kg/m2 of gypsum is applied. Excavated fill from the construction area is not recommended for reuse on site in landscaping unless it is appropriately treated with gypsum, compacted, and capped with topsoil with natural soil and gypsum
- All stormwater runoff from the dwelling to be directed to mains connection (all the drains are to be adequately treated with gypsum)
- Drainage of any site cut must not employ conventional rock drain construction; it must adhere to recommendations for dispersive soils (unless founded entirely in rock)



• All excavation works on site should be monitored for signs of soil dispersion and remedial action taken as required – any excavated fill from the construction area is not recommended for reuse on site in landscaping unless it is appropriately treated with gypsum, compacted, and capped with topsoil

Conclusions

There is a low to moderate risk associated with dispersive soils and potential erosion on the site provided the recommendations in this report are adhered to. Efforts should be made to cover all exposed soils on cut/fill batters with topsoil and seeded with well suited pasture species to avoid rainwater, runoff, surface water flows from intercepting exposed subsoils.

A number of site management recommendations have been made in this report and further information can also be found in the publication "Dispersive soils and their management – Technical manual" (DPIWE Tas 2009)

It is recommended that during construction that GES be notified of any variation to the soil conditions as outlined in this report.

Dr John Paul Cumming B.Agr.Sc (hons) PhD CPSS GAICD

Environmental and Engineering Soil Scientist



Appendix 1- Soil test results

Laboratory Test Results

Sample Submitted By: C Cooper

Date Submitted: 23/06/2025

Sample Identification: 2 samples – Lot 32 Oakmont Road, Midway Point

Soil to be tested: Emerson soil dispersion test

Result:

Sample	Texture	Emerson class	Description
Sample 1	clay	Class 2 (2)	Some dispersion <50% affected
Sample 2	clay	Class 2 (2)	Some dispersion <50% affected

Notes: Some dispersion with obvious milkiness affecting <50% of the aggregate.

Sample Tested by: C Cooper

24/06/2025



Disclaimer

This Report has been prepared in accordance with the scope of services between Geo-Environmental Solutions Pty. Ltd. (GES) and the Client. To the best of GES's knowledge, the information presented herein represents the client's requirements at the time of printing of the Report. However, the passage of time, manifestation of latent conditions or impacts of future events may result in findings differing from that discussed in this Report. In preparing this Report, GES has relied upon data, surveys, analyses, designs, plans and other information provided by the Client and other individuals and organizations referenced herein. Except as otherwise stated in this Report, GES has not verified the accuracy or completeness of such data, surveys, analyses, designs, plans and other information.

The scope of this study does not allow for the review of every possible geotechnical parameter or the soil conditions over the whole area of the site. Soil and rock samples collected from the investigation area are assumed to be representative of the areas from where they were collected and not indicative of the entire site. The conclusions discussed within this report are based on observations and/or testing at these investigation points.

This report does not purport to provide legal advice. Readers of the report should engage professional legal practitioners for this purpose as required.

No responsibility is accepted for the use of any part of this report in any other context or for any other purpose by a third party.

TOTAL FLOOR AREAS

VERANDAH

N	MAIN DWELLING, GROUND FLOOR	
Г	ALFRESCO	13.05
	GARAGE	38.96
	LIVING	149.39
	DODCH	2.75

7 44 211.59 m²

AS & NCC COMPLIANCE

ALL CONSTRUCTION TO BE IN ACCORDANCE WITH NCC 2022 AND APPLICABLE AUSTRALIAN STANDARDS AT TIME OF APPROVAL

- SLAB IN ACCORDANCE WITH AS 2870. REFER TO ENGINEERS DETAILS FOR ALL SLAB DETAILS.
- BRICK CONTROL JOINTS PROVIDED IN ACCORDANCE WITH NCC 2022. ALL STEEL FRAMING TO BE DESIGNED TO AS 4100-2020 OR AS/NZS
- INSULATION TO BE INSTALLED IN ACCORDANCE WITH NCC 2022 AND ALL APPLICABLE AUSTRALIAN STANDARDS.
- TERMITE PROTECTION IN ACCORDANCE WITH AS 3660 AND NCC 2022. GLAZING IN ACCORDANCE WITH AS 1288 AND NCC 2022.
- SMOKE ALARMS IN ACCORDANCE WITH AS 3786 AND NCC 2022. INTERNAL WATERPROOFING IN ACCORDANCE WITH NCC 2022 HOUSING PROVISIONS PART 10.2. EXTERNAL WATERPROOFING IN ACCORDANCE WITH AS 3740 AND AS
- WET AREA FLOORS TO FALL TO FLOOR WASTES AT MIN. 1:80 AND MAX.
- 1:50 GRADE (IF APPLICABLE). CONDENSATION MANAGEMENT IN ACCORDANCE WITH NCC 2022
- HOUSING PROVISIONS PART 10.8.
 BUILDING SEALING IN ACCORDANCE WITH NCC 2022.
- SERVICES IN ACCORDANCE WITH NCC 2022. EARTHWORKS IN ACCORDANCE WITH AS 3798-2007.
- EXTERNAL WALL WRAP (SARKING) IN ACCORDANCE WITH NCC 2022 (IF
- EXHAUST FANS DUCTED TO OUTSIDE AIR (IF APPLICABLE).

SITE SPECIFIC CONTROLS		
CONTROL	DETAILS	
ACID SULPHATE SOIL	NO	
BIODIVERSITY	NO	
BUILDING ENVELOPE	YES	
BUSHFIRE	TBC	
CLIMATE ZONE (NCC)	ZONE 7 - COOL TEMPERATE	
DESIGN WIND CLASSIFICATION	N3 (EXPOSED TBC)	
ESTATE/DEVELOPER GUIDELINES	NO	
FLOOD OVERLAY	NO	
HERITAGE	NO	
LANDSLIP HAZARD	NO	
MINIMUM FLOOR LEVEL	TBC	
NATURAL ASSET CODE	NO	
NOISE ATTENUATION	NO	
SALINE SOIL	NO	
SHIELDING FACTOR	PS - PARTIAL SHIELDING	
SITE CLASSIFICATION	P	
SPECIFIC AREA PLAN OVERLAY	YES	
SORELL LOCAL PROVISIONS SC	HEDULE	
TERRAIN CATEGORY	TC2	
TOPOGRAPHIC CLASSIFICATION	T3	
WATERWAY & COASTAL OVERLAY	NO	
WIND REGION	A - NORMAL	
WITHIN 1km CALM SALT WATER	NO	
WITHIN 50km BREAKING SURF	6.50km	
ZONING	GENERAL RESIDENTIAL	
AIRPORT OBSTACLE LIMITATION AREA		
PRIORITY VEGETATION AREA		

BUILDING CONTROLS & COMPLIANCE		
CONTROL	REQUIRED	PROPOSED
SETBACKS		
FRONT	MIN. 4,500mm	5,009mm
SIDE A	MIN. 1,500mm	3,082mm
SIDE B	MIN. 1,500mm	1,500mm
REAR	MIN. 1,500mm	6,855mm
BULK & SCALE		
SITE AREA	529m²	
SITE COVERAGE	MAX. 50%	40%
LANDSCAPE		
NO APPLICABLE CONTROLS		
EARTHWORKS		
CUT DEPTH	MAX. 2,000mm	515mm
FILL DEPTH	MAX. 1,000mm	0mm
ACCESS & AMENITY		
PARKING SPACES	MIN. 2 SPACES	2 SPACES

ALL

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SHEET

2025.10.25

2025.09.25

2025.07.24

DATE

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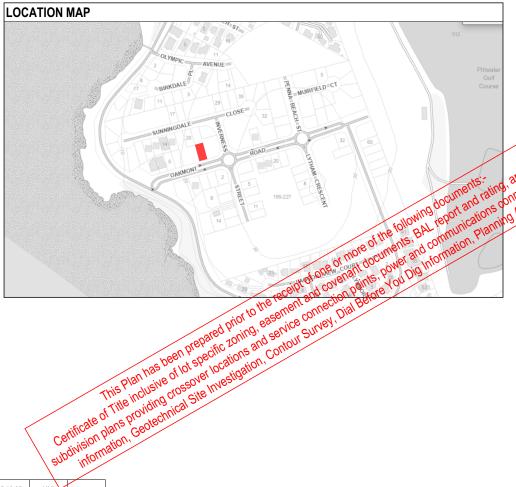
DRAWN CHECK

3D PERSPECTIVE



NOTE TO OWNER

THESE PLANS MAY FEATURE WORKS THAT ARE EXCLUDED FROM THE SCOPE OF WORKS WITH THE BUILDER, BUT THEY HAVE BEEN INCLUDED IN THESE DRAWINGS TO ASSIST IN THE OVERALL PLANNING AND ASSESSMENT OF THE BUILDING PROJECT. EXAMPLES OF SOME REGULARLY EXCLUDED WORKS INCLUDE DRIVEWAYS, RETAINING WALLS, SQUAR PANEL SPACING AND SITE DRAINAGE, PLEASE REFER TO YOUR SCOPE OF WORKS AND COLOUR SELECTIONS DOCUMENTATION FOR DETAILS OF INCLUDED WORKS. SOME DETAILS ARE INDICATIVE ONLY FOR EXAMPLE FLOORING, TILING, BRICKWORK AND CLADDING (EXPANSION JOINTS, ORIENTATION AND LAYOUT) AND ARE SUBJECT TO CHANGE.



NCC 2022 LIVABLE HOUSING COMPLIANCE

ACCESSIBLE SANITARY COMPARTMENT: TRA ACCESSIBLE SHOWER LOCATION: TBA

GENERAL NOTES:

INSTALLATION.

- THRESHOLD OF ACCESSIBLE SHOWER ENTRY TO BE MAX. 5MM
- 1 EXTERIOR DOOR NOMINATED AS 870 OR GREATER TO ACHIEVE MIN 820MM CLEAR OPENING
 REFER TO APPLICABLE WET AREA PLANS AND INTERIOR ELEVATIONS OR LOCATIONS OF REQUIRED WALL REINFORCEMENT FOR FUTURE GRAB RAIL

BUILDING INFORMATION GROUND FLOOR TOP OF WALL HEIGHT(S) 2445mm NOTE: CEILING HEIGHT 45mm LOWER THAN TOP OF WALL ROOF PITCH (UNO) **ELECTRICITY SUPPLY** SINGLE PHASE GAS SUPPLY NONE ROOF MATERIAL SHEET METAL ROOF COLOUR WALL MATERIAL BRICK VENEER CLADDING SLAB CLASSIFICATION

INSULATION

ROOF	SARKING UNDER ROOFING
CEILING	R4.1 BATTS (EXCL. GARAGE, ALFRESCO & PATIO)
EXT. WALLS	R2.0 BATTS (EXCL. GARAGE) WALL WRAP TO ENTIRE HOUSE
INT. WALLS	R2.0 BATTS ADJACENT TO GARAGE AND AS PER PLAN
FLOOR	BIAX SLAB R0.60 OR AIRCELL FOR B&J

THE OWNERS ACKNOWLEDGE THAT THESE CONTRACT PLANS MAY NOT REFLECT ALL THE SELECTIONS THAT HAVE BEEN MADE OR CHANGES REQUESTED. THE OWNERS AGREE THAT FOLLOWING THE COLOUR SELECTIONS VARIATION OR UPDATING OF PLANS, THEY WILL BE PROVIDED WITH CONSTRUCTION PLANS FOR SIGNATURE PRIOR TO COMMENCEMENT OF CONSTRUCTION.

SIGNATURE: DATE:

HOUSE CODE

ACADE CODE

1:100

SUBJECT TO NCC 2022 (1 MAY 2023)

WATERPROOFING & PLUMBING **CONDENSATION MANAGEMENT**

PLAN ACCEPTANCE BY OWNER SIGNATURE: DATE: SIGNATURE: DATE:

PLEASE NOTE THAT VARIATIONS WILL NOT BE ACCEPTED AFTER THIS PLAN ACCEPTANCE HAS BEEN SIGNED.

DO NOT SCALE DRAWINGS, USE

FIGURED DIMENSIONS ONLY, CHEC

AND VERIFY DIMENSIONS AND I EVELS PRIOR TO THE

TO THE DRAFTING OFFICE.

714358

by Wilson Homes

PRELIMINARY PLAN SET

PRELIMINARY PLAN SET - INITIAL ISSUE

AMENDMENT

No.

PRELIMINARY PLAN SET - PLANNING RFI (27/10/2025)

PRELIMINARY PLAN SET - SHADOW DIAGRAMS & TITLE UPDATE

IN ANY WAY REPRODUCE, COPY, MODIFY, USE OR TAKE ADVANTAGE OF THE DRAWING TO BUILD A HOUSE BASED ON THIS PLAN (WHETHER IN WHOLE OR IN PART) WITHOUT THE PRIOR WRITTEN CONSENT OF WILSON HOMES PTY LTD. SPECIFICATION REVISION DRAWN CAL 17/05/2025 WILSON HOMES NOW BY WILSON HOMES PEMBROKE 20 CONCEPT COPYRIGHT HMI 25/07/2025 ADDRESS: FACADE DESIGN: 2 PRELIM PLANS - INITIAL ISSUE © 2025 HMI 27/09/2025 LOT 32 OAKMONT ROAD, MIDWAY POINT TAS 7171 RIVERSIDE 3 PRELIM PLAN - SHADOW DIAGRAM UPDATE HMI 27/10/2025 LOT / SECTION / CT: SHEET TITLE: COUNCIL SHEET No.: SCALES 4 PRELIM PLAN - PLANNING RFI (27/10/2025) SORELL 32 / - / 189367 COVER SHEET 1 / 14

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REFER TO SHEET 1 (COVER SHEET) FOR ALL BUILDING INFORMATION REGARDING SUSTAINABILITY REQUIREMENTS SITE CLASSIFICATION GENERAL BUILDING INFORMATION


APPROX. CUT/FILL


15 TONNES OF EXPORT FILL		
DIFFERENCE	6.77m³	15.23t
FILL	0.00m³	0.00t
CUT	6.77m³	15.23t

LOT SIZE: 529m² HOUSE (COVERED ARE 211.59m² SITE COVERAGE: 39.99%

DEB AREA

DROPPED EDGE BEAMS		
HEIGHT (mm)	SURFACE AREA (m²)	
86	0.71	
172	0.47	
257	1.37	
429	5.95	
514	1.84	
600	3.40	
686	6.19	
772	7.08	
	27.01 m²	

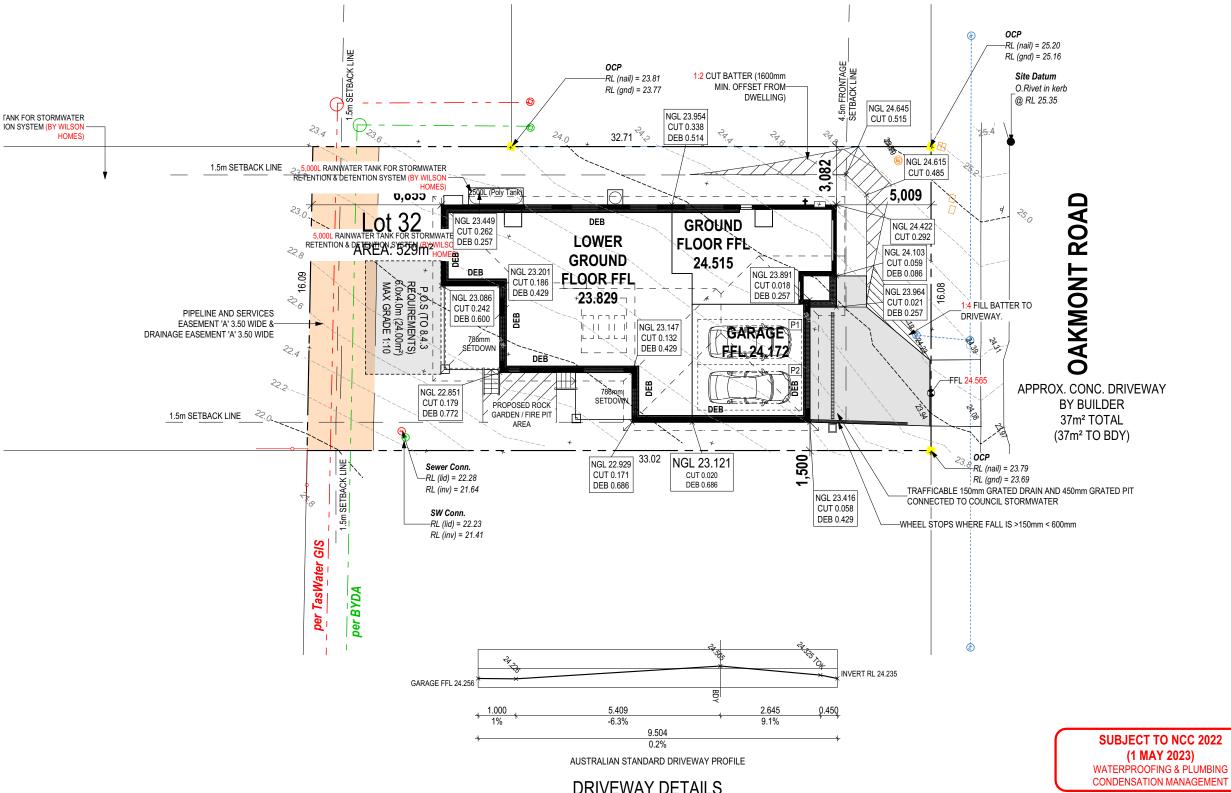

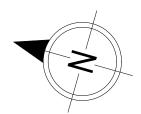

DRIVEWAY DETAILS

SCALE: 1:100

PLAN ACCEPTANCE BY OWNER SIGNATURE: DATE: SIGNATURE: DATE:

PLEASE NOTE THAT VARIATIONS WILL NOT BE ACCEPTED

AFTER THIS PLAN ACCEPTANCE HAS BEEN SIGNED

© 2025 WILSON HOMES PTY LTD (ABN 96 126 636 897). THIS DRAWING IS AN ORIGINAL ARTISTIC WORK WITHIN THE MEANING OF THE COPYRIGHT ACT 1968 (CTH). WILSON HOMES PTY LTD IS THE OWNER OF COPYRIGHT IN THIS DRAWING. YOU HEREBY AGREE AND UNDERTAKE THAT YOU WILL NOT IN ANY WAY REPRODUCE, COPY, MODIFY, USE OR TAKE ADVANTAGE OF THE DRAWING TO BUILD A HOUSE BASED ON THIS PLAN (WHETHER IN WHOLE OR IN PART) WITHOUT THE PRIOR WRITTEN CONSENT OF WILSON HOMES PTY LTD.

NOW
by Wilson Homes


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7	NOW BY WILSON HOMES	1 CONCEPT	CAL	17/05/2025	WILSON HOMES	PEMBROKE 20			AND VERIFY DIMENSIONS AND LEVELS PRIOR TO THE
	COPYRIGHT:	2 PRELIM PLANS - INITIAL ISSUE		25/07/2025		FACADE DESIGN:		FACADE CODE:	COMMENCEMENT OF ANY WORK. ALL
	© 2025	3 PRELIM PLAN - SHADOW DIAGRAM UPDATE	HMI	27/09/2025	LOT 32 OAKMONT ROAD, MIDWAY POINT TAS 7171	RIVERSIDE			DISCREPANCIES TO BE REPORTED TO THE DRAFTING OFFICE.
		4 PRELIM PLAN - PLANNING RFI (27/10/2025)	HMI	27/10/2025	LOT / SECTION / CT: COUNCIL:	SHEET TITLE:	SHEET No.:	SCALES:	71/250
25					32 / - / 189367 SORELL	SITE PLAN	2 / 14	1:200, 1:100	714358


OWNER TO STABILISE THE SITE ON COMPLETION OF THE BUILD WITH TURF LAWNS, GRASS SEEDS, NATIVE GROUND COVERS AND/ OR MULCH SPREAD TO A DEPTH OF 75-100mm


THE FOLLOWING IS A STANDARD APPROACH. SEDIMENT AND EROSION CONTROL MEASURES WILL BE REVIEWED PRIOR TO COMMENCING WORK AND INSTALLED BASED ON THE OUTCOME OF THAT REVIEW.


1. ALL EROSION AND SEDIMENT CONTROL STRUCTURES TO BE INSPECTED EACH WORKING DAY AND MAINTAINED IN GOOD WORKING ORDER.

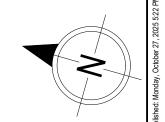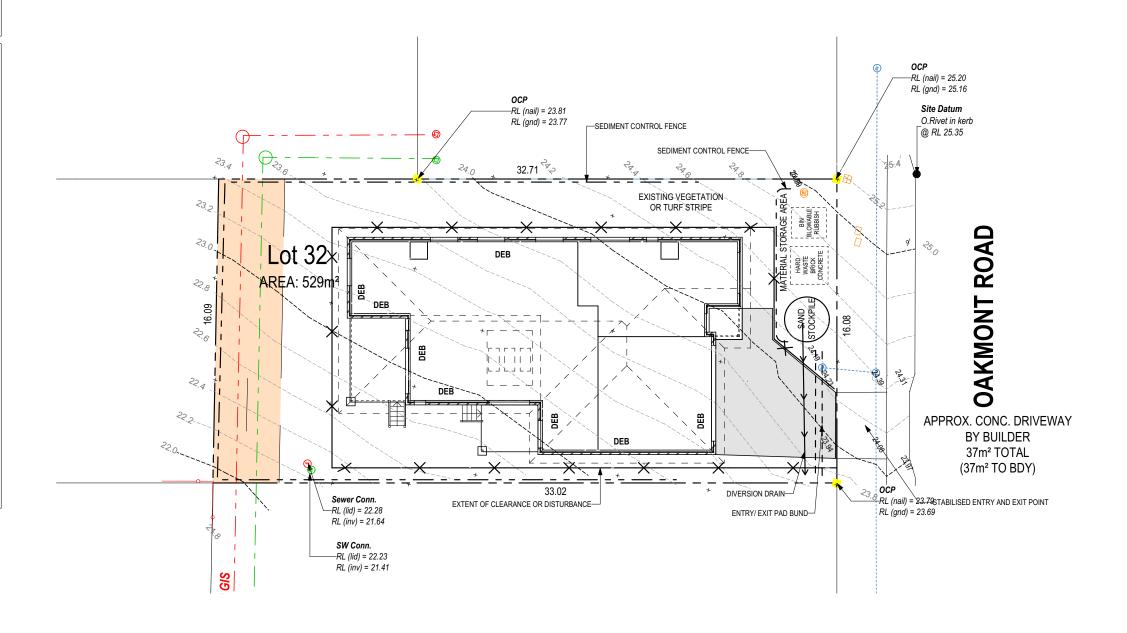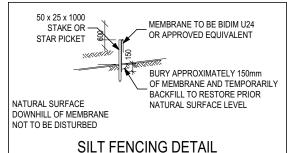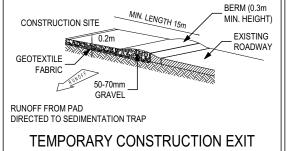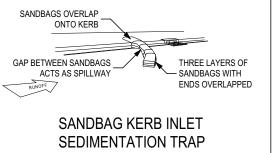
- 2. ALL GROUND COVER VEGETATION OUTSIDE THE IMMEDIATE BUILDING AREA TO BE PRESERVED DURING THE BUILDING
- 3. ALL EROSION AND SEDIMENT CONROL MEASURES TO BE INSTALLED PRIOR TO COMMENCEMENT OF MAJOR EARTHWORKS.
- 4. STOCKPILES OF CLAYEY MATERIAL TO BE COVERED WITH AN IMPERVIOUS SHEET. 5. ROOF WATER DOWNPIPES TO BE CONNECTED TO THE PERMAMENT UNDERGROUND STORMWATER DRAINAGE SYSTEM AS SOON AS PRACTICAL AFTER THE ROOF IS LAID.
- 6. DIVERSION DRAINS ARE TO BE CONNECTED TO A LEAGAL DISCHARGE POINT (COUNCIL STORMWATER SYSTEM, WATERCOURSE OR ROAD DRAIN). 7. SEDIMENT RETENTION TRAPS INSTALLED AROUND THE INLETS TO THE STORMWATER SYSTEM TO PREVENT SEDIMENT & OTHER DEBRIS BLOCKING THE DRAINS.











ALL RUNOFF AND SEDIMENT CONTROL STRUCTURES WILL BE INSPECTED EACH WORKING DAY AND MAINTAINED IN A FUNCTIONAL

ALL VEGETATION OUTSIDE THE BUILDING ZONE WILL BE MAINTAINED.

SUBJECT TO NCC 2022 (1 MAY 2023) WATERPROOFING & PLUMBING **CONDENSATION MANAGEMENT**

DI ANI ACCEDTANCE DV OWNED

PLAN ACCEPTANCE BY OWNER									
SIGNATURE:	DATE:								
SIGNATURE:	DATE:								

PLEASE NOTE THAT VARIATIONS WILL NOT BE ACCEPTED

AFTER THIS PLAN ACCEPTANCE HAS BEEN SIGNED

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	4 PRELIM PLAN - PLANNING RFI (27/10/2025)	HMI 27/10/2025	LOT / SECTION / CT:	COUNCIL:	SHEET TITLE:	SHEET No.: SCALES:	714358
			32 / - / 189367	SORELL	SOIL & WATER MANAGEMENT PLAN	3 / 14	<i> </i> 14330 §

Sorell Council evelopment Application: 5.2025.278.1 -Response to Request For Information - Lot 32 Dakmont Road, Midway Point P2.pdf Plans Reference: P2

IS WITHIN 450mm OF ANY BOUNDARY IS TO BE NON-

ALL EXTERIOR SLABS TO BE GRADED BY CONCRETER TO ACHIEVE APPROX. 1:100 FALL TO OUTSIDE EDGE WITH MAXIMUM CROSSFALL OF 30mm OVER ENTIRE SLAB.

2,310

1,400

1,040 1,90

760

1,260

5,910 6,480

SIGNATURE:

SIGNATURE:

11,500

SUBJECT TO NCC 2022

(1 MAY 2023)

WATERPROOFING & PLUMBING CONDENSATION MANAGEMENT

PLAN ACCEPTANCE BY OWNER

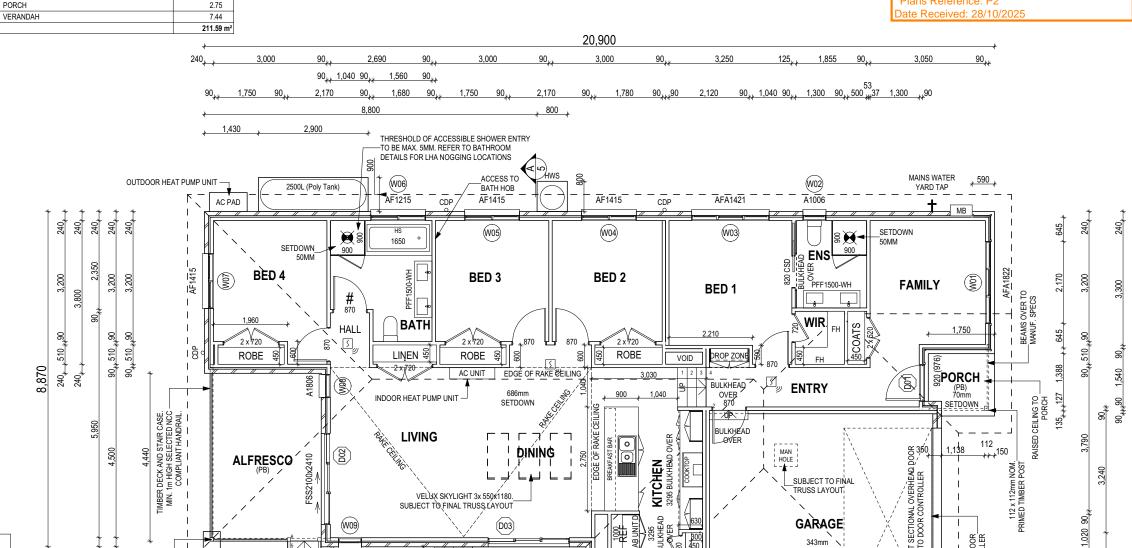
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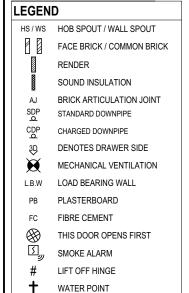
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DATE:

DATE:

1,930





REFER TO SHEET 1 (COVER SHEET) FOR

SUSTAINABILITY REQUIREMENTS

GENERAL BUILDING INFORMATION

ALL MECHANICAL VENTILATION TO BE

DISCHARGED TO OUTDOOR AIR AS PER

FIRE RESISTANT PLASTERBOARD TO BE INSTALLED BEHIND COOKTOP

ALL GROUND FLOOR BULKHEAD AND SQUARE SET OPENING FRAMES TO BE

MANUFACTURERS SPECIFICATIONS AT DEPOSIT STAGE AND MAY DIFFER SLIGHTLY TO THE SIZES NOMINATED IN

MANUFACTURING CHANGES AT THE TIME

FINAL WINDOW AND EXTERIOR DOOR

LOCATIONS MAY BE ADJUSTED ON SITE

2155 ABOVE FFL UNLESS NOTED

REFER TO WINDOW AND DOOR SCHEDULES FOR FULL DETAILS OF ALL WINDOWS AND DOORS. PLEASE NOTE WINDOW AND DOOR SIZES ARE BASED ON

THE SCOPE OF WORKS DUE TO

TO SUIT BRICKWORK GAUGE

UNLESS NOTED OTHERWISE ALL ROOMS ARE REFERENCED AS FOLLOWS:

2022 REQUIREMENTS

ALL STAIR TREADS TO PROVIDE A MINIMUM SLIP RESISTANCE TO MEET NCC

OF CONSTRUCTION

OTHERWISE

SITE CLASSIFICATION

NCC 2022 REQUIREMENTS

MAIN DWELLING, GROUND FLOOR

240

2,630

SHS

13.05

38.96

149 39

CDPA1806

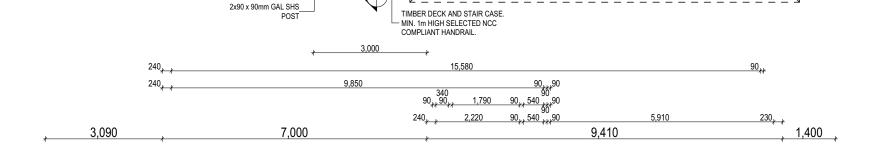
2,940

ALFRESCO

GARAGE

LIVING

PORCH



CDP

BROOM

LDRÝ (FC1000)

(°)

CDP

VERANDAH

ALL DIMENSIONS ARE FRAME DIMENSIONS

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	(
	(
by Wilson Homes	

XFW FLOOR WASTE

GAS BAYONET

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7	NOW BY WILSON HOMES	1 CONCEPT	CAL	17/05/2025	WILSON HOMES	PEMBROKE 20			AND VERIFY DIMENSIONS AND
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	© 2025	3 PRELIM PLAN - SHADOW DIAGRAM UPDATE	НМІ	27/09/2025	LOT 32 OAKMONT ROAD, MIDWAY POINT TAS 7171	RIVERSIDE			DISCREPANCIES TO BE REPORTED
		4 PRELIM PLAN - PLANNING RFI (27/10/2025)	НМІ		LOT / SECTION / CT: COUNCIL:	SHEET TITLE:	SHEET No.:		714358
es					32 / - / 189367 SORELL	GROUND FLOOR PLAN	4 / 14	1:100	/ / 14336 _層

343mm \

OVERHEAD DOR CONTRI

CDP

SETDOWN

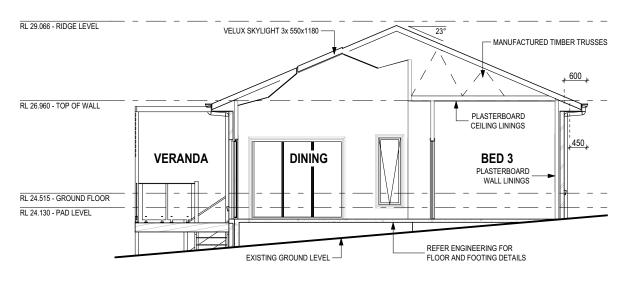
INDICATIVE ONLY FOR EXAMPLE BRICKWORK AND CLADDING (EXPANSION JOINTS, ORIENTATION AND LAYOUT) AND ARE SUBJECT TO CHANGE.

SH = SNAP HEADER SILL

BEDROOM WINDOW OPENINGS ABOVE 2m OFF THE SURFACE BENEATH TO BE RESTRICTED AS REQUIRED BY NCC 11.3.7 (VOLUME

ROOMS OTHER THAN BEDROOM WINDOW OPENINGS ABOVE 4m OFF THE SURFACE BENEATH TO BE RESTRICTED AS REQUIRED BY NCC 11.3.7 (VOLUME TWO)

REFER TO THE FOLLOWING DETAILS: BRICK COURSING W-BRIC-001



Sorell Council

Date Received: 28/10/2025

evelopment Application: 5.2025.278.1 -

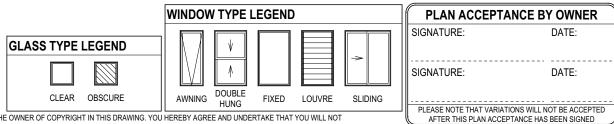
Dakmont Road, Midway Point P2.pdf Plans Reference: P2

Response to Request For Information - Lot 32

SECTION A-A SCALE: 1:100


SUBJECT TO NCC 2022 (1 MAY 2023)

WATERPROOFING & PLUMBING CONDENSATION MANAGEMENT



LIGHTWEIGHT CLADDING COLORBOND CORRUGATED / —CUSTOM ORB METAL ROOFING + _JAMES HARDIE SCYON LINEA 180mm CLADDING RL 29.066 - RIDGE LEVEL 45 x 38mm SCYON AXENT RL 26.960 - TOP OF WALL JAMES HARDIE SCYON INEA 180mm CLADDING RL 24.515 - GROUND FLOOR RL 24.130 - PAD LEVEL DEB _112 x 112mm NOM. PRIMED TIMBER POST ARTICULATED FACE BRICKWORK

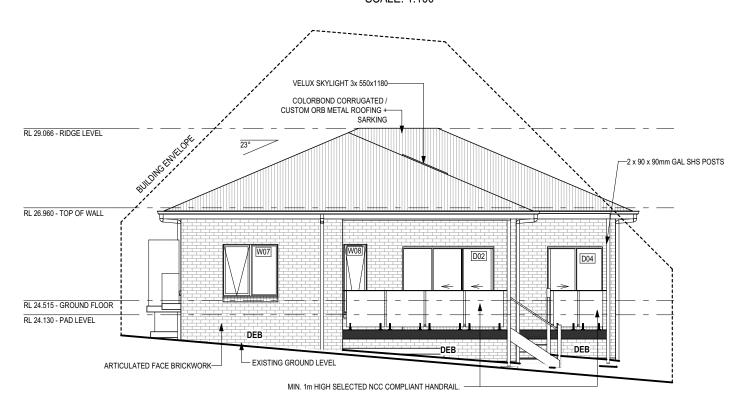SOUTH ELEVATION SCALE: 1:100




NORTH ELEVATION SCALE: 1:100

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NOW
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714358

FACADE CODE:

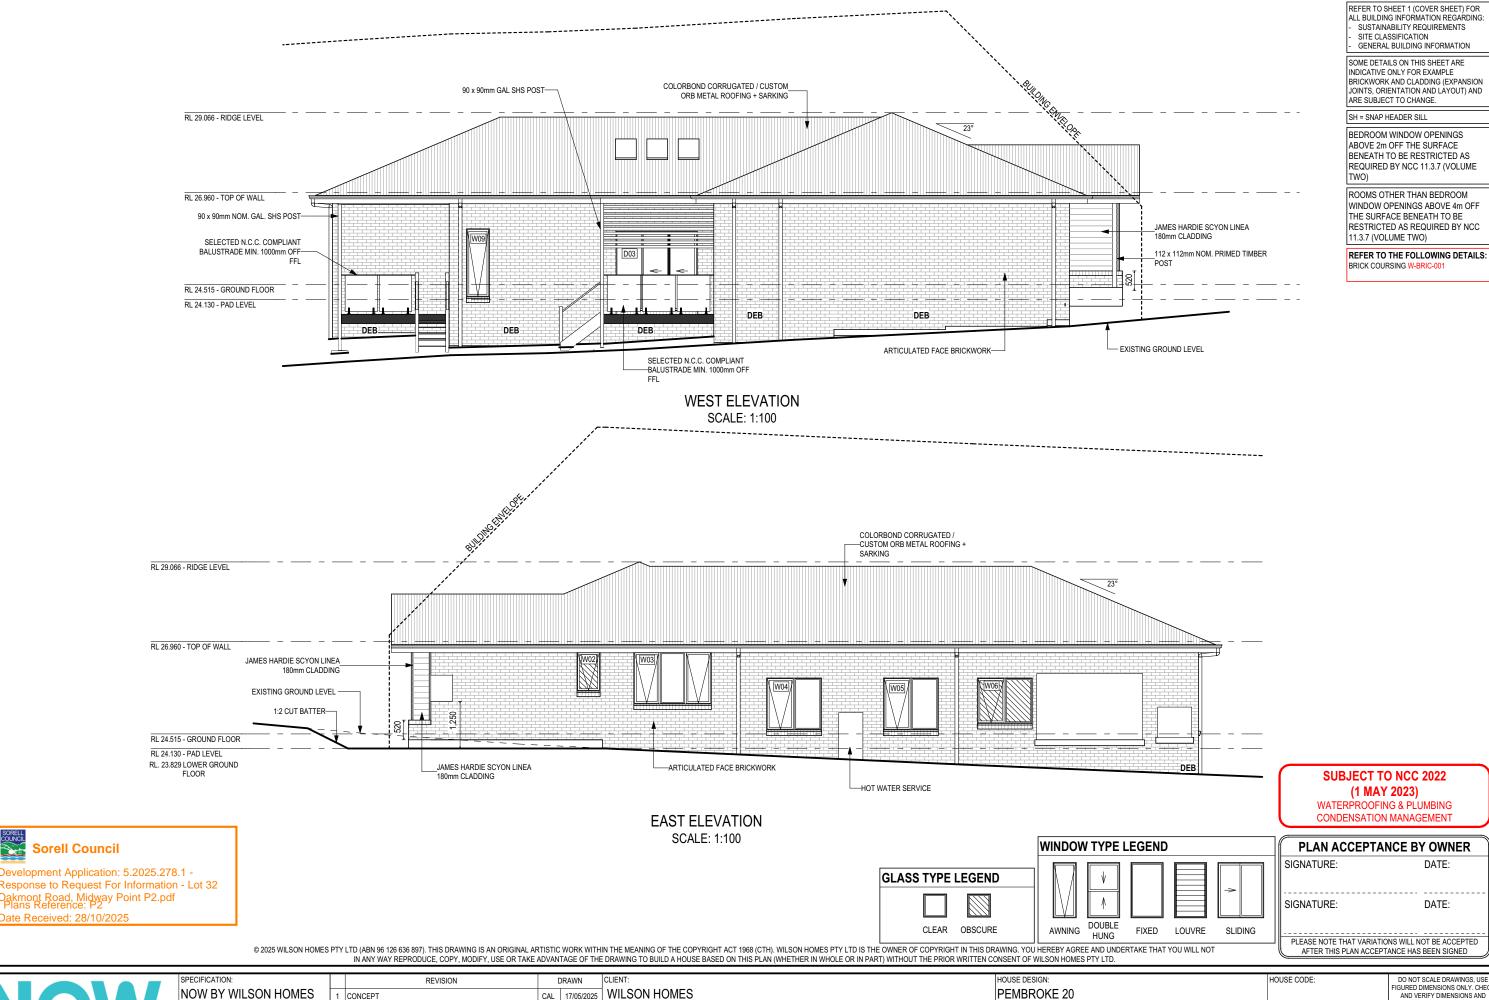1:100

SHEET No.: SCALES:

6 / 14

Template Version: 24.038 File

_									
I	NTERIOR WIND	WO	& DOOR SCH	1EDULE					
Ī	STOREY	QTY	CODE	TYPE	HEIGHT	WIDTH	GLAZING TYPE	ADDITIONAL INFORMATION	
ı	DOOR								
	GROUND FLOOR	1	2 x 420	SWINGING	2,040	840	N/A		
	GROUND FLOOR	1	2 x 520	SWINGING	2,040	1,040	N/A		
	GROUND FLOOR	4	2 x 720	SWINGING	2,040	1,440	N/A		
	GROUND FLOOR	1	620	SWINGING	2,040	620	N/A		
	GROUND FLOOR	1	720	SWINGING	2,040	720	N/A		
	GROUND FLOOR	1	820 CSD	CAVITY SLIDING	2,040	820	N/A		
	GROUND FLOOR	5	870	SWINGING	2,040	870	N/A		
	GROUND FLOOR	1	870	SWINGING	2,040	870	N/A	LIFT-OFF HINGES	
=	•						·	·	

Date Received: 28/10/2025

Sorell Council

Development Application: 5.2025.278.1 -

Oakmont Road, Midway Point P2.pdf Plans Reference: P2

Response to Request For Information - Lot 32

NOTE: INTERNAL DOORS TO WET AREA

	PICT	PICTURE, TV RECESS AND SS WINDOW OPENINGS							
	QTY	TYPE	HEIGHT	WIDTH	AREA (m²)				
FAS WITH MECHANICAL VENTILATION TO BE UNDERCUT 20mm	1								

Manufacturer - Clark Windows Glazing U-Value SHGC Window Type **Awning** Single 0.67 Double 4.1 0.57 Fixed Single 5.9 0.75 Double 3.2 0.67 Sliding 6.4 0.76 Single **Double** 4.2 0.59 5.9 0.75 **Fixed Pane** Single **Double** 3.2 0.67 **Fixed Glass Panel Hinged Door** Single 6.0 0.62 **Double** 4.3 0.55 0.74 **Sliding Door** Single 6.1 Double 3.6 0.66 **Stacking Door** 6.3 0.74 Single **Double** 3.8 0.66 135 deg. Awning Bay Window Single 6.5 0.67 4.1 **Double** 0.57 135 deg. Sliding Bay Window Single 6.5 0.76 **Double** 4.2 0.59 90 deg. Awning Bay Window Single 6.5 0.67 4.1 0.57 Double 90 deg. Sliding Bay Window 6.5 Single 0.76 Double 4.2 0.59 **Bifold Doors** Single 6.1 0.61 4.4 0.53 Double

Windows supplied MUST HAVE Uw better and or equal to stated figures and SHGC within +/- 5% of stated figures. Restricted windows to have their openability restricted as per N.C.C 11.3.6.

> **SUBJECT TO NCC 2022** (1 MAY 2023)

WATERPROOFING & PLUMBING **CONDENSATION MANAGEMENT**

PLAN ACCEPTANCE BY OWNER								
SIGNATURE:	DATE:							
SIGNATURE:	DATE:							
	IONS WILL NOT BE ACCEPTED							
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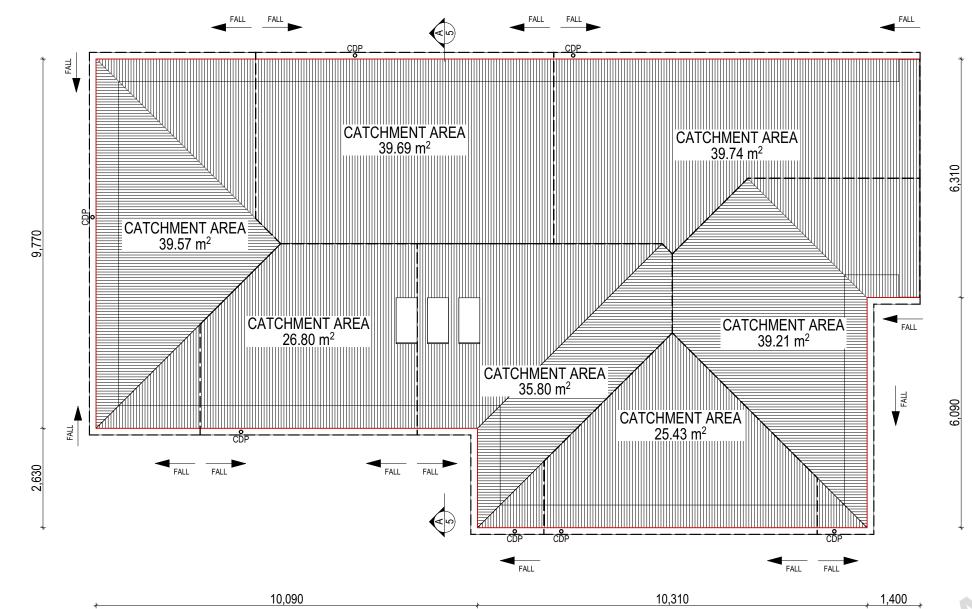


REFER TO SHEET 1 (COVER SHEET) FOR SUSTAINABILITY REQUIREMENTS

GENERAL BUILDING INFORMATION

SPECIFICATION HOUSE CODE DRAWN DO NOT SCALE DRAWINGS, USE REVISION FIGURED DIMENSIONS ONLY, CHECK NOW BY WILSON HOMES CAL 17/05/2025 WILSON HOMES PEMBROKE 20 CONCEPT AND VERIFY DIMENSIONS AND I EVELS PRIOR TO THE COPYRIGHT HMI 25/07/2025 ADDRESS: FACADE DESIGN: ACADE CODE: 2 PRELIM PLANS - INITIAL ISSUE © 2025 HMI 27/09/2025 LOT 32 OAKMONT ROAD, MIDWAY POINT TAS 7171 RIVERSIDE 3 PRELIM PLAN - SHADOW DIAGRAM UPDATE TO THE DRAFTING OFFICE. HMI 27/10/2025 LOT / SECTION / CT: SHEET TITLE: COUNCIL: SHEET No.: SCALES: 4 PRELIM PLAN - PLANNING RFI (27/10/2025) 7 / 14 32 / - / 189367 SORELL WINDOW & DOOR SCHEDULES

21,800



WHERE DOWNPIPES ARE FURTHER THAN 1.2m AWAY FROM VALLEY REFER TO N.C.C. 7.3.5(2)

POSITION AND QUALITY OF DOWNPIPES ARE NOT TO BE ALTERED WITHOUT CONSULTATION WITH DESIGNER.

AREA'S SHOWN ARE SURFACE AREAS CATCHMENT AREAS, NOT PLAN AREAS

Roofi	ng Data	
	246.23	Flat Roof Area (excluding gutter and slope factor) (m²)
	32.19	Roof Surface Area (includes slope factor, excludes gutter) (m²)
Dowr	pipe roof	calculations (as per AS/NZA3500.3:2021)
Ah	246.24	Area of roof catchment (including 115mm Slotted Quad Gutter) (m²)
Ac	297.95	Ah x Catchment Area Multiplier for slope (Table 3.4.3.2 from AS/NZS 3500.3:2021) (1.21 for 23° pitch) (m²)
Ae	6300	Cross sectional area of 57 x 115 Slotted Quad Gutter (mm²)
DRI	86	Design Rainfall Intensity (determined from Table E1 from AS/NZS 3500.3:2021)
Acdp	64	Catchment area per Downpipe (determined from Figure 3.5(A) from AS/NZS 3500.3:2021) (m²)
Required Downpipes	4.65	Ac / Acdp
Downpipes Provided	7	



evelopment Application: 5.2025.278.1 -Response to Request For Information - Lot 32 Dakmont Road, Midway Point P2.pdf Plans Reference: P2 Date Received: 28/10/2025

SOFFIT EAVE VENT PROPOSED LOCATION

SUBJECT TO NCC 2022 (1 MAY 2023)

WATERPROOFING & PLUMBING CONDENSATION MANAGEMENT

PLAN ACCEPTA	NCE BY OWNER	۱
SIGNATURE:	DATE:	
SIGNATURE:	DATE:	
PLEASE NOTE THAT VARIAT	IONS WILL NOT BE ACCEPTED	П
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		4	PRELIM PLAN - PLANNING RFI (27/10/2025)	НМІ	27/10/2025		COUNCIL:	SHEET TITLE:	SHEET No.:	SCALES:	711250
5						32 / - / 189367	SORELL	ROOF DRAINAGE PLAN	8 / 14	1:100	714358

FLOOR TILES SHOWN ON PLAN DO NOT INDICATE THE SIZE OR JOINT LOCATIONS OF THE ACTUAL FLOOR TILES.
TIMBER FLOORING SHOWN ON PLAN DOES NOT INDICATE THE BOARD SIZE OR DIRECTION OF THE ACTUAL FLOORING.

COVERINGS LEGEND

NO COVERING

COVER GRADE CONCRETE

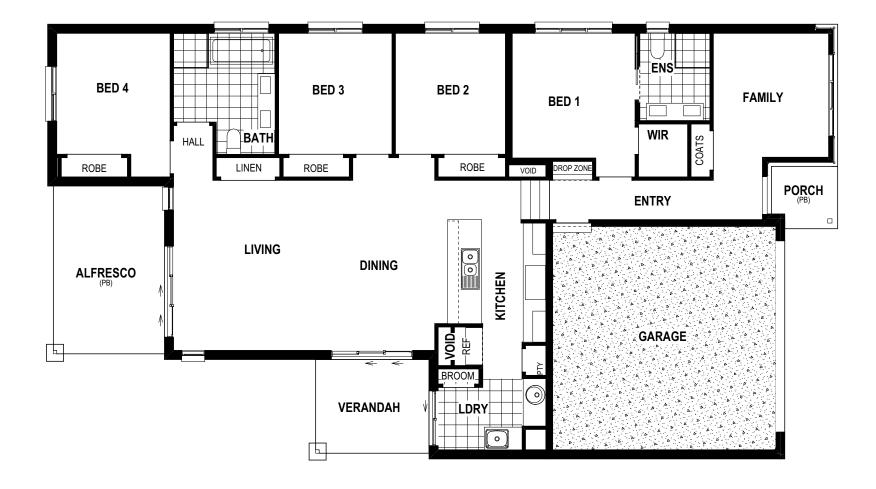
CARPET

LAMINATE

TILE (STANDARD WET AREAS)

TILE (UPGRADED AREAS)

DECKING





Sorell Council

evelopment Application: 5.2025.278.1 esponse to Request For Information - Lot 32 Dakmont Road, Midway Point P2.pdf Plans Reference: P2 ate Received: 28/10/2025

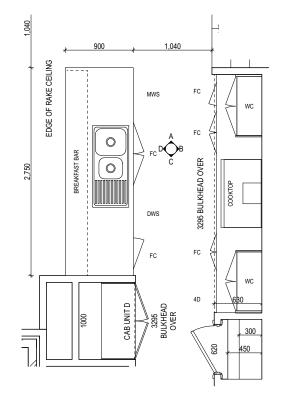
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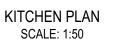
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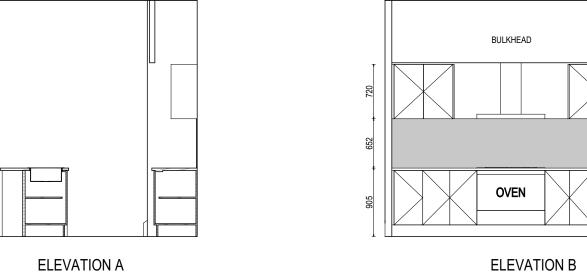


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	4 PRELIM PLAN - PLANNING RFI (27/10/2025)		LOT / SECTION / CT:	COUNCIL: SORELL	SHEET TITLE: FLOOR COVERINGS	SHE 9 /	SCALES: 1:100	714358

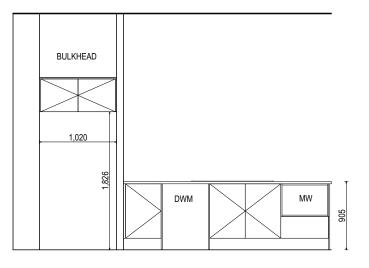





Sorell Council Development Application: 5.2025.278.1 -Response to Request For Information - Lot 32 Oakmont Road, Midway Point P2.pdf Plans Reference: P2 Date Received: 28/10/2025



SCALE: 1:50



ELEVATION D SCALE: 1:50

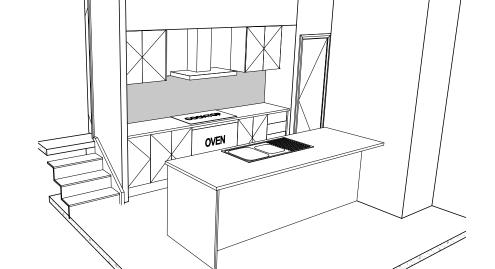


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SPACE

PANTRY



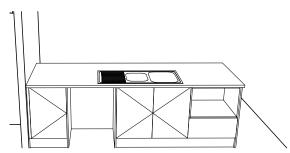PANTRY,

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© 2025	3	PRELIM PLAN - SHADOW DIAGRAM UPDATE	HMI 27/09/2025	LOT 32 OAKMONT ROAI	D, MIDWAY POINT TAS 7171	RIVERSIDE			DISCREPANCIES TO BE REPORTED TO THE DRAFTING OFFICE.
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				32 / - / 189367	SORELL	KITCHEN DETAILS	10 / 14	1:50	714358

PLAN ACCEPTANCE BY OWNER

PLEASE NOTE THAT VARIATIONS WILL NOT BE ACCEPTED

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DATE:

SIGNATURE:

SIGNATURE:

Sorell Council

Response to Request For Information - Lot 32 Oakmont Road, Midway Point P2.pdf Plans Reference: P2 Date Received: 28/10/2025

REFER TO THE FOLLOWING DETAILS: VANITY DETAILS G-VANI-001
WINDOW OVER BATH HOB D-WIND-ALU001

STANDARD BATH HOB D-WETA-BATH003
WET AREA TILING LAYOUTS D-WETA-TILE002

SQUARE SET WINDOWS G-WIND-SSET02 FULL HEIGHT TILING D-LINI-WETA

LEGEND RSHR RAIL SHOWER

ROSE SHOWER ROSE SHOWER ELBOW ELBW CONNECTION

MIXER TAP HOT TAP

CT COLD TAP HS HOB SPOUT

WS WALL SPOUT SC STOP COCK

TRH TOILET ROLL HOLDER TR-S TOWEL RAIL - SINGLE

TR-D TOWEL RAIL - DOUBLE TL TOWEL LADDER

TOWEL HOLDER TOWEL RACK

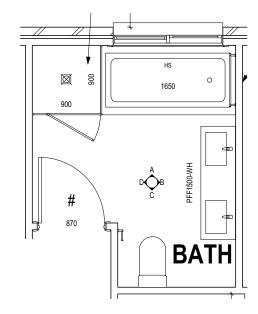
TMB TUMBLER HOLDER

RH ROBE HOOK


SR SHAMPOO RECESS SOAP SOAP HOLDER

TH TR RNG TOWEL RING SHLF SHELF

evelopment Application: 5.2025.278.1 -




BATHROOM PLAN SCALE: 1:50

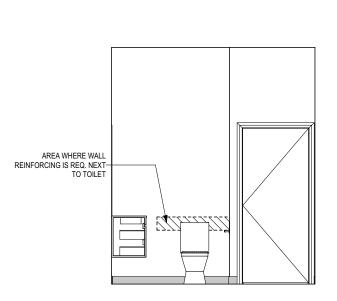

ELEVATION C SCALE: 1:50

ELEVATION A

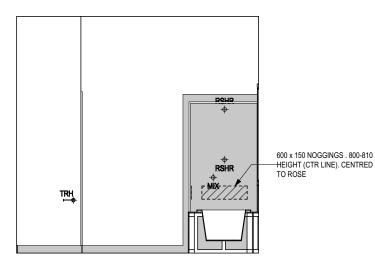SCALE: 1:50



ELEVATION B

SCALE: 1:50

150 x 1000 NOGGINGS CENTRED TO EDGE OF BATH. OFFSET—

600 x 150 NOGGINGS -CENTRED TO BATH. OFFSET 175mm FROM TOP OF BATH

ELEVATION D SCALE: 1:50

	SHAMPOO	RECESS SIZE	STRUCTURAL	DIMENSIONS						
			WIDTH	HEIGHT						
7	"SMALL"	470 x 380mm	548mm	446mm						
	"MEDIUM"	800 x 380mm	878mm	446mm						
Ĺ	"LARGE"	1500 x 380mm	1578mm	446mm						
٧	REFER WILSON HOMES' DETAIL G-WETA-TILE01 FOR									
	FURTHER D	ETAIL PRIOR TO) INSTALLATION	٧.						

SUBJECT TO NCC 2022 (1 MAY 2023)

WATERPROOFING & PLUMBING CONDENSATION MANAGEMENT

DATE:
DATE:
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VA/Slaam IIIamaaa	
by Wilson Homes	

600 x 150 NOGGINGS . 800-810 HEIGHT (CTR LINE). OFFSET— 250mm FROM WALL

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	© 2025	3 PRELIM PLAN - SHADOW DIAGRAM UPDATE	НМІ	27/09/2025	LOT 32 OAKMONT ROAD, MIDWAY POINT TAS 7171	RIVERSIDE			TO THE DRAFTING OFFICE.	/ersic
		4 PRELIM PLAN - PLANNING RFI (27/10/2025)	HMI	27/10/2025		SHEET TITLE: SH	HEET No.:	SCALES:	711250	ate
es					32 / - / 189367 SORELL	BATHROOM DETAILS 11	1 / 14	1:50	714358	Temp

SUSTAINABILITY REQUIREMENTS SITE CLASSIFICATION GENERAL BUILDING INFORMATION DETAILS DEPICTED ON THIS SHEET ARE A REPRESENTATION ONLY LEGEND

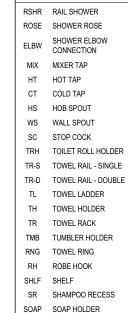


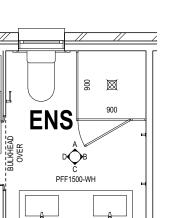
Development Application: 5.2025.278.1 -Response to Request For Information - Lot 32 Oakmont Road, Midway Point P2.pdf Plans Reference: P2 Date Received: 28/10/2025

REFER TO THE FOLLOWING DETAILS: VANITY DETAILS G-VANI-001
WINDOW OVER BATH HOB D-WIND-ALU001


STANDARD BATH HOB D-WETA-BATH003
WET AREA TILING LAYOUTS D-WETA-TILE002

SQUARE SET WINDOWS G-WIND-SSET02 FULL HEIGHT TILING D-LINI-WETA





ENSUITE PLAN

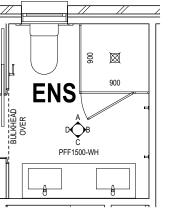

SCALE: 1:50

SHAMPOO	RECESS SIZE	STRUCTURAL	DIMENSIONS
		WIDTH	HEIGHT
"SMALL"	470 x 380mm	548mm	446mm
"MEDIUM"	800 x 380mm	878mm	446mm
"LARGE"	1500 x 380mm	1578mm	446mm
DEEED WILL	ON HOMEOURE	TAIL O META T	II F04 F0B

REFER WILSON HOMES' DETAIL G-WETA-TILE01 FOR FURTHER DETAIL PRIOR TO INSTALLATION.

SUBJECT TO NCC 2022 (1 MAY 2023)


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PLAN ACCEPTA	ANCE BY OWNER	
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	TIONS WILL NOT BE ACCEPTED	

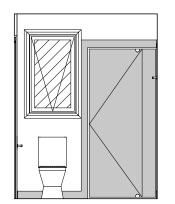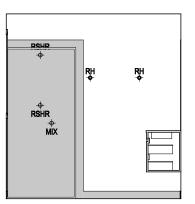
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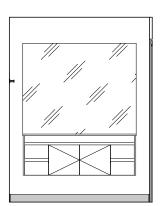
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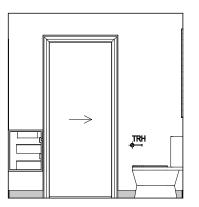
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ELEVATION B SCALE: 1:50



ELEVATION C SCALE: 1:50



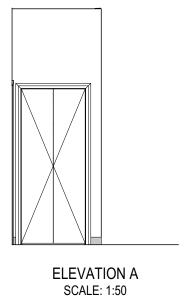
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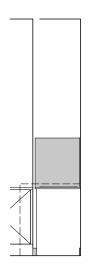
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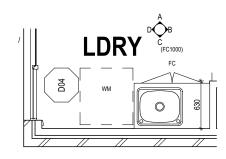
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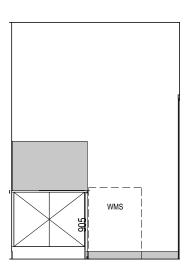





ELEVATION B

SCALE: 1:50





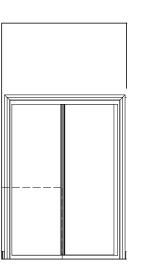ELEVATION C SCALE: 1:50



ELEVATION D SCALE: 1:50


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	_		PRELIM PLAN - PLANNING RFI (27/10/2025)	НМІ			COUNCIL:	SHEET TITLE:	SHEET No.:		711250	
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SUBJECT TO NCC 2022 (1 MAY 2023)
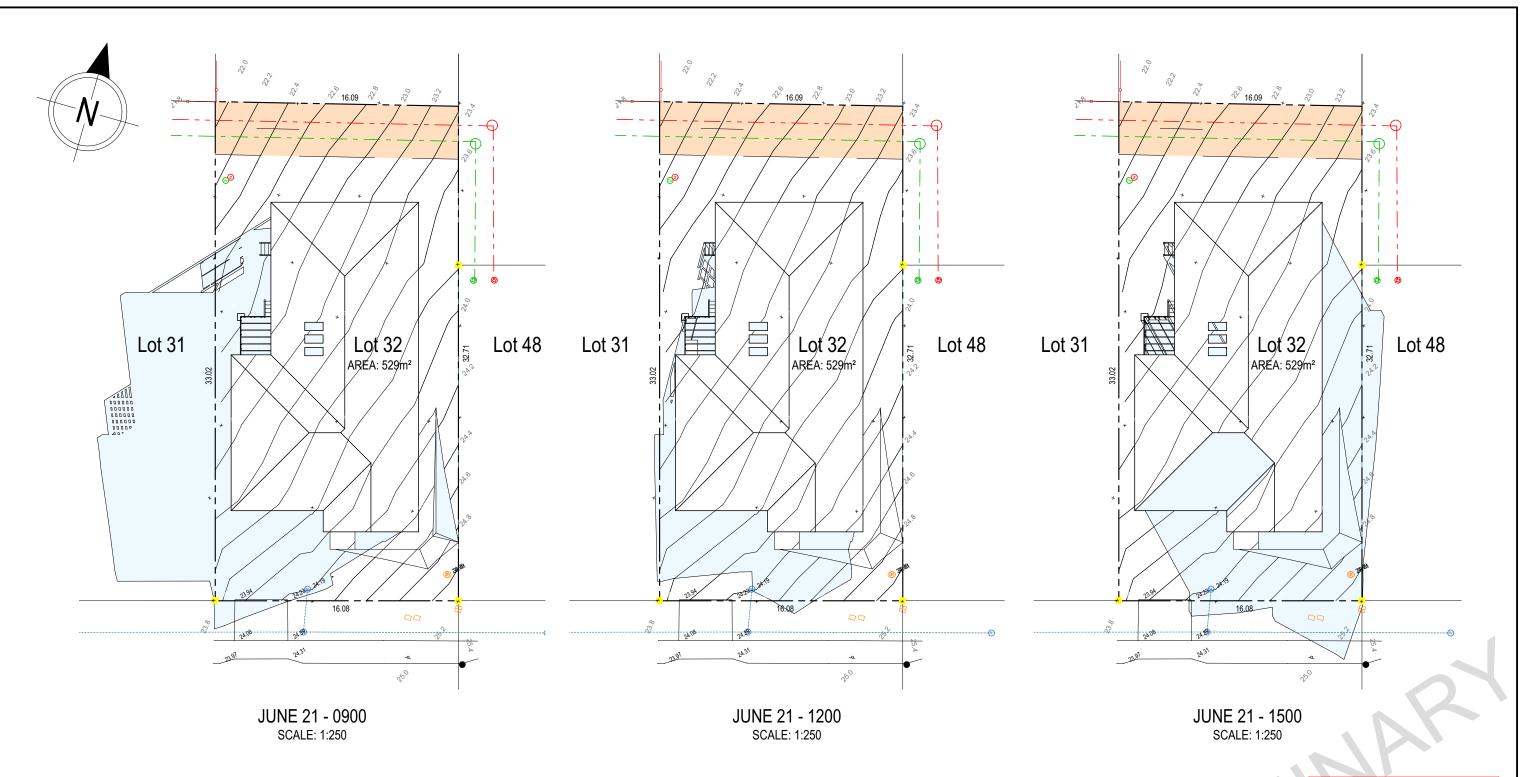
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