

NOTICE OF PROPOSED DEVELOPMENT

Notice is hereby given that an application has been made for planning approval for the following development:

SITE: 6 Thoroughbred Road, Orielton

PROPOSED DEVELOPMENT:

DWELLING

The relevant plans and documents can be inspected at the Council Offices at 47 Cole Street, Sorell during normal office hours, or the plans may be viewed on Council's website at www.sorell.tas.gov.au until Monday 14th July 2025.

Any person may make representation in relation to the proposal by letter or electronic mail (sorell.council@sorell.tas.gov.au) addressed to the General Manager. Representations must be received no later than **Monday 14th July 2025**.

APPLICANT: Wilson Homes Tasmania Pty Ltd

APPLICATION NO: DA 2025 / 158 1 DATE: 25 June 2025

Part B: Please note that Part B of this form is publicly exhibited.

Full description of Proposal:	Use:								
or roposui.	Development:								
	Large or complex proposals s	hould be	described	in a letter or planning report.					
Design and cons	struction cost of proposal:		\$						
Is all, or some th	ne work already constructed:		No: □	Yes: □					
Location of proposed									
works:	Certificate of Title(s) Volum			code:					
Current Use of Site									
Current Owner/s:	Name(s)								
Is the Property of Register?	on the Tasmanian Heritage	No: □	Yes: □	If yes, please provide written advice from Heritage Tasmania					
Is the proposal t than one stage?	o be carried out in more	No: □	Yes: □	If yes, please clearly describe in plans					
Have any potent been undertake	tially contaminating uses n on the site?	No: □	Yes: □	If yes, please complete the Additional Information for Non-Residential Use					
Is any vegetation proposed to be removed?			Yes: □	If yes, please ensure plans clearly show area to be impacted					
Does the propos administered or or Council?	sal involve land owned by either the Crown	No: □	Yes: □	If yes, please complete the Council or Crown land section on page 3					
complete the Ve	If a new or upgraded vehicular crossing is required from Council to the front boundary please complete the Vehicular Crossing (and Associated Works) application form								
https://www.sor	ell.tas.gov.au/services/egine	ering/		Sorell Council					

Development Application: 5.2025.158.1 Development Application - 6 Thoroughbred
Road, Orielton - P1.pdf
Plans Reference: P1
Date Received: 16/06/2025

Declarations and acknowledgements

- I/we confirm that the application does not contradict any easement, covenant or restriction specified in the Certificate of Title, Schedule of Easements or Part 5 Agreement for the land.
- I/we consent to Council employees or consultants entering the site and have arranged permission and/or access for Council's representatives to enter the land at any time during normal business hours.
- I/we authorise the provision of a copy of any documents relating to this application to any person for the purposes of assessment or public consultation and have permission of the copyright owner for such copies.
- I/we declare that, in accordance with s52(1) of the Land Use Planning and Approvals Act 1993, that I have notified the owner(s) of the intention to make this application.
- I/we declare that the information in this application is true and correct.

Details of how the Council manages personal information and how you can request access or corrections to it is outlined in Council's Privacy Policy available on the Council website.

- I/we acknowledge that the documentation submitted in support of my application will become a public record held by Council and may be reproduced by Council in both electronic and hard copy format in order to facilitate the assessment process, for display purposes during public exhibition, and to fulfil its statutory obligations. I further acknowledge that following determination of my application, Council will store documentation relating to my application in electronic format only.
- Where the General Manager's consent is also required under s.14 of the *Urban Drainage Act 2013*, by making this application I/we also apply for that consent.

Applicant Signature:	Signature:	Date:
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Crown or General Manager Land Owner Consent

If the land that is the subject of this application is owned or administered by either the Crown or Sorell Council, the consent of the relevant Minister or the Council General Manager whichever is applicable, must be included here. This consent should be completed and signed by either the General Manager, the Minister, or a delegate (as specified in s52 (1D-1G) of the *Land Use Planning and Approvals Act 1993*).

Please note:


- If General Manager consent if required, please first complete the General Manager consent application form available on our website www.sorell.tas.gov.au
- If the application involves Crown land you will also need a letter of consent.
- Any consent is for the purposes of making this application only and is not consent to undertaken work or take any other action with respect to the proposed use or development.

1		being responsible for the
administration of land at		Sorell Council
declare that I have given permis	Development Application: 5.2025.158.1 - Development Application - 6 Thoroughbred Road, Orielton - P1.pdf Plans Reference: P1 Date Received: 16/06/2025	
Signature of General Manager,		
Minister or Delegate:	Signature:	Date:



RESULT OF SEARCH

RECORDER OF TITLES

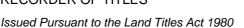



SEARCH OF TORRENS TITLE

VOLUME	FOLIO
186369	7
EDITION	DATE OF ISSUE
2	10-Apr-2025

SEARCH DATE : 12-Jun-2025 SEARCH TIME : 10.28 AM

DESCRIPTION OF LAND

Parish of SORELL Land District of PEMBROKE Lot 7 on Sealed Plan 186369 Derivation: Part of Lot 30000, 276A-1R-25P Gtd. to Owen Douglas Townsend

Prior CTs 167839/1 and 182991/2

SCHEDULE 1

N244157 TRANSFER to CASSANDRA LEE ATILEO and FALEUPOLU ATILEO Registered 10-Apr-2025 at noon

SCHEDULE 2

Reservations and conditions in the Crown Grant if any SP186369 COVENANTS in Schedule of Easements SP186369 FENCING PROVISION in Schedule of Easements SP 31317 FENCING COVENANT in Schedule of Easements SP103907, SP155615 & SP167839 FENCING PROVISION in Schedule of Easements SP 31317 COUNCIL NOTIFICATION under Section 468(12) of the Local Government Act 1962 E405810 MORTGAGE to B&E Ltd Registered 10-Apr-2025 at 12.01 PM

UNREGISTERED DEALINGS AND NOTATIONS

No unregistered dealings or other notations



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SCHEDULE OF EASEMENTS

THE SCHEDULE MUST BE SIGNED BY THE OWNERS NOTE:

& MORTGAGEES OF THE LAND AFFECTED.

SIGNATURES MUST BE ATTESTED.

Registered Number

PAGE 1 OF 4 PAGES

EASEMENTS AND PROFITS

Each lot on the plan is together with:-

- such rights of drainage over the drainage easements shown on the plan (if any) as may be necessary to drain the stormwater and other surplus water from such lot; and
- any easements or profits a prendre described hereunder.

Each lot on the plan is subject to:-

- such rights of drainage over the drainage easements shown on the plan (if any) as passing through such lot as may be necessary to drain the stormwater and other surplus water from any other lot on the plan; and
- any easements or profits a prendre described hereunder.

The direction of the flow of water through the drainage easements shown on the plan is indicated by arrows.

₁(private) **EASEMENTS** Lot 11 is SUBJECT TO a Right of Carriageway over the area marked "RIGHT OF WAY 'A '3.00 WIDE" appurtenant to lot 12 on the Plan.

Lot 11 is TOGETHER WITH a Right of Carriageway over the area marked "RIGHT OF WAY ' B ' 3.00 WIDE" over lot 12 on the Plan.

Lot 12 is SUBJECT TO a Right of Carriageway over the area marked "RIGHT OF WAY 'B 3.00 WIDE" appurtenant to lot 11 on the Plan.

Lot 12 is TOGETHER WITH a Right of Carriageway over the area marked "RIGHT OF WAY ' A 3.00 WIDE" over lot 11 on the Plan.

Lot 13 is SUBJECT TO a Right of Drainage over the area marked "DRAINAGE EASEMENT 4.00 WIDE" appurtenant to the Sorell Council

Lot 20 is SUBJECT TO a Right of Drainage over the area marked "DRAINAGE EASEMENT 6.00 WIDE" appurtenant to the Sorell Council

(as defined herein)

Lots 2, 3 and 18-21 (inclusive) are SUBJECT TO a Wayleave Easement marked "WAYLEAVE EASEMENT VARIABLE WIDTH 'B' appurtenant to Tasmanian Networks Pty Ltd.
Lots 13, 14 & 15 are each on the plan (as defined herein)
Lot 13 is SUBJECT TO are SUBJECT TO a Wayleave Easement marked "WAYLEAVE EASEMENT

VARIABLE WIDTH 'A' appurtenant to Tasmanian Networks Pty Ltd.

on the plan

Sorell Council

evelopment Application: 5.2025.158.1 -Development Application - 6 Thoroughbred oad, Orielton - P1.pdf lans Reference: P1 ceived: 16/06/2029

(USE ANNEXURE PAGES FOR CONTINUATION)

SUBDIVIDER: JAC MULTI ASSET PTY LTD

FOLIO REF: 182990/1 & 182991/2 SOLICITOR & REFERENCE:

Butler McIntyre & Butler (JS:222609)

PLAN SEALED BY: SORELL COUNCIL

DATE: ...\./2/24

SA 2016/00011 REF NO.

Council Delegate

NOTE: The Council Delegate must sign the Certificate for the purposes of identification.

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ANNEXURE TO SCHEDULE OF EASEMENTS

PAGE 2 OF 4 PAGES

Registered Number

SP 186369

SUBDIVIDER: JAC MULTI ASSET PTY LTD FOLIO REFERENCE: 182990/1 & 182991/2

Definitions

"Right of Carriageway" means a right of drainage as defined within Schedule 8 of the Conveyancing and Law of Property Act 1884 (Tas).

"Right of Drainage" means a right of drainage as defined within Schedule 8 of the Conveyancing and Law of Property Act 1884 (Tas).

"Wayleave Easement means:

FIRSTLY the full and free right and liberty for Tasmanian Networks Pty Ltd and its successors and its and their servants, agents, invitees and contractors ("TasNetworks") at all times:

- (a) TO clear the lands marked "WAYLEAVE EASEMENT VARIABLE WIDTH" Plan (described as "the servient land") and to lay, erect, construct, inspect, install, maintain, repair, modify, add to, replace, remove and operate in, upon, through, over, along and under the servient land the following:
 - (i) Towers, poles, wires, cables, apparatus, appliances, and all other ancillary and associated equipment which includes telecommunication equipment (described collectively as "electricity infrastructure")

for, or principally for, the transmission and distribution of electrical energy and for any incidental purposes.

- (b) TO operate and maintain electricity infrastructure on the servient land.
- (c) TO cut away remove and keep clear of the electricity infrastructure all trees and other obstructions or erections of any nature whatsoever which may at any time:
 - (i) overhang, encroach upon or be in or on the servient land; or
 - (ii) which may in the opinion of TasNetworks endanger or interfere with the proper operation of the electricity infrastructure.
- (d) TO enter the servient land for all or any of the above purposes and to cross the remainder of the land with any and all necessary plant, equipment, machinery and vehicles for the purpose of access and egress to and from the servient land, and where reasonably practicable, in consultation with the registered proprietor/s (except when urgent or emergency repair work is needed).

SECONDLY the benefit of a covenant for TasNetworks and with the registered proprietor/s for themselves and their successors not to:

- (i) erect any buildings; or
- (ii) place any structures, objects or vegetation;

within the servient land without the prior written consent of TasNetworks. TasNetworks may rescind their consent if in the opinion of TasNetworks there are safety, access or operational concerns.

Director – JAC Multi-Asset Pty Ltd

Director - JAC Multi Asset Pty Ltd

NOTE: Every annexed page must be signed by the parties to the dealing or where the party is a corporate body be signed by the persons who have attested the affixing of the seal of that body to the dealing.

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SORELL

Sorell Council

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ANNEXURE TO SCHEDULE OF EASEMENTS

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COVENANTS

SEE BELOW

The owners of lots 2, 3, 4, 7, 8, 9, 13 and 14 on the Plan covenant with Tasmanian Irrigation Pty Ltd (ACN 133 148 384) as a covenant in gross that no building or other structure, including concreted areas or landscaping and walls (other than a boundary fence) are to be erected or maintained on that part of the Lot shown as "NO BUILDING ZONE" on the Plan to the intent that the burden of this covenant will run with and bind the covenantor's lot and every part of that lot

FENCING PROVISION

In respect to the lots on the plan the vendor (JAC MULTI ASSET PTY LTD) shall not be required to fence.

COVENANTS

The subdivider as the owner of Lots 2, 3, 4, 7, 8, 9, 13 and 14 on the plan covenants with Tasmanian Irrigation Pty Ltd (ACN 133 148 384) to the intent that the burden of this covenant may run with and bind the covenantor's lot and every part thereof, and that the benefit thereof may be created in favour of Tasmanian Irrigation Pty Ltd to observe the following stipulations:

1. Not to allow any building or other structure, including concreted areas or landscaping and walls (other than a boundary fence) to be erected or maintained on that part of the Lot shown as "NON-BUILDING ZONE" on the plan.

Director - JAC Multi Asset Pty Ltd

Director - JAC Multi Asset Pty Ltd



Sorell Council

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ANNEXURE TO SCHEDULE OF EASEMENTS

PAGE 4 OF 4 PAGES

Registered Number

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SUBDIVIDER: JAC MULTI ASSET PTY LTD FOLIO REFERENCE: 182990/1 & 182991/2

EXECUTED by JAC MULTI ASSET PTY LTD (ACN 636 512 082) pursuant to section 127 of the Corporations Act

2001 by:

Director Signature

Signature

Director/ Secretary

DEAN MURRAY COCKER PETR KMZ Director Full Name (print) Director/ Secretary Full

Name (print)

Sorell Council

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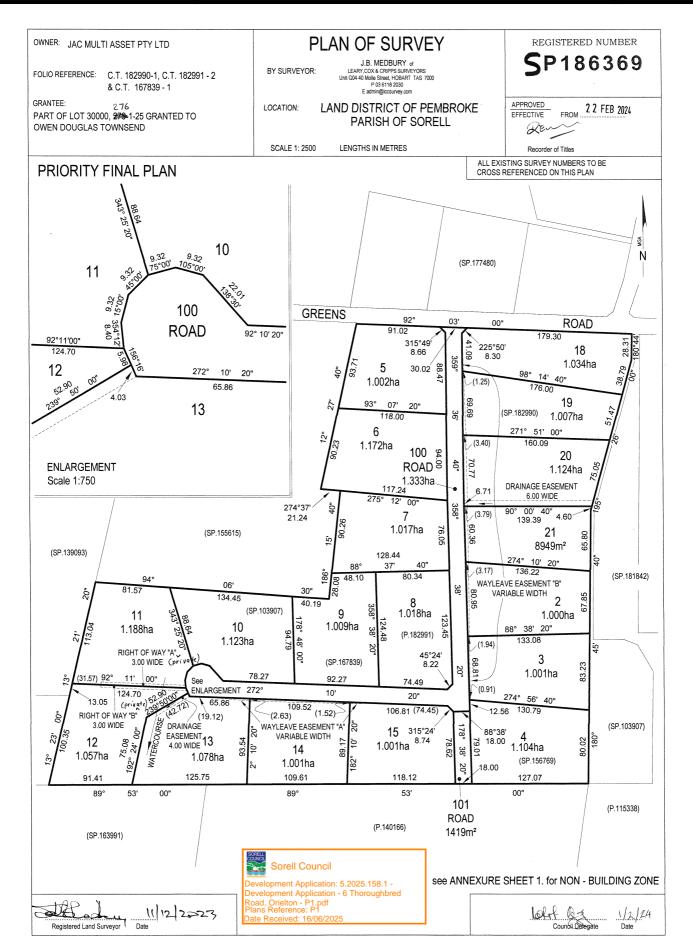


FOLIO PLAN

RECORDER OF TITLES



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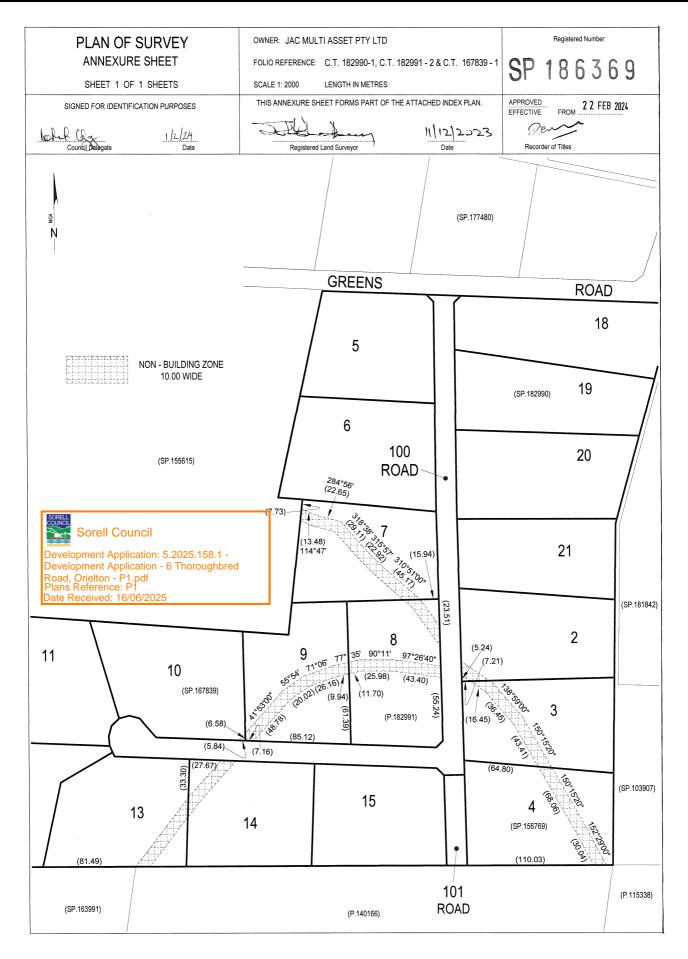


FOLIO PLAN

RECORDER OF TITLES



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AS2870:2011 SITE ASSESSMENT

6 Thoroughbred Road Orielton March 2025

Wilson Homes Reference: 714242





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Investigation Details

Client: Wilson Homes

Site Address: 6 Thoroughbred Road, Orielton

Date of Inspection: 12/03/2025

Proposed Works: New house

Investigation Method: Geoprobe 540UD - Direct Push

Inspected by: C. Cooper

Site Details

Certificate of Title (CT): 186369/7

Title Area: Approx. 1.021 ha

Applicable Planning Overlays: Bushfire-prone areas, Airport obstacle limitation area

Slope & Aspect: 2° W facing slope

Vegetation: Pasture

Ground Surface: Surface Cracks

Background Information

Geology Map: MRT

Geological Unit: Tertiary Sediments

Climate: Annual rainfall 550mm

Water Connection: Tank

Sewer Connection: Unserviced-On-site required

Testing and Classification: AS2870:2011, AS1726:2017 & AS4055:2021



Investigation

A number of bore holes were completed to identify the distribution and variation of the soil materials at the site, bore hole locations are indicated on the site plan. See soil profile conditions presented below. Tests were conducted across the site to obtain bearing capacities of the material at the time of this investigation.

Soil Profile Summary

BH 1 Depth (m)	BH 2 Depth (m)	USCS	Description
0.00-0.30	0.00-0.20	SM	Silty SAND: dark grey, brown, dry, dense
0.30-2.20	0.20-2.00+	СН	Silty CLAY: high plasticity, dark grey, brown, slightly moist, stiff,
2.20-3.00+		GC	Clayey GRAVELS:, grey, brown, slightly moist, dense, no refusal

Site Notes

Soils on the site are developing from Tertiary sediments, the clay fraction is likely to show significant ground surface movement with moisture fluctuations.

Site Classification

The site has been assessed and classified in accordance with AS2870:2011 "Residential Slabs and Footings".

The site has been classified as:

Class H-2

Y's range: **60-75mm**

Notes: that is a highly reactive clay.



Wind Loading Classification

According to "AS4055:2021 - Wind Loads for Housing" the house site is classified below:

Wind Classification:	N3
Region:	Α
Terrain Category:	2.0
Shielding Classification:	NS
Topographic Classification:	T1
Wind Classification:	N3
Design Wind Gust Speed – m/s (V _{h,u}):	50

Construction Notes & Recommendations

The site has been classified as **Class H-2** - Highly reactive clay site, which may experience significant ground movement from moisture changes.

It is recommended that all footings be founded in the natural material with bearing capacities >100kPa, and preferably into the weathered gravels below 2m depth.

All earthworks on site must comply with AS3798:2007, and I further recommend that consideration be given to drainage and sediment control on site during and after construction. Care should also be taken to ensure there is adequate drainage in the construction area to avoid the potential for weak bearing and foundation settlement associated with excessive soil moisture.

I also recommend that during construction that I and/or the design engineer be notified of any major variation to the foundation conditions as predicted in this report.

Dr John Paul Cumming B.Agr.Sc (hons) PhD CPSS GAICD

Director



Explanatory Notes

1 Scope of Works

The methods of description and classification of soils used in this report are based largely on Australian Standard 1726 – Geotechnical Site Investigations (AS1726:2017), with reference to Australian Standard 1289 – Methods for testing soils for engineering purposes (AS1289), for eventual Site Classification according to Australian Standard 2870 (AS2870:2011) – Residential Slabs and Footings and Australian Standard 1547 (AS1547:2012) On-site domestic wastewater management.

1.1 Site Classification AS2870:2011

Site classification with reference to the above Australian Standards are based on site reactivity.

Class	Foundation Conditions	Characteristic Surface Movement
Α	Most sand and rock sites with little or no ground movement from moisture changes.	0mm
S	Slightly reactive clay sites, which may experience only slight ground movement from moisture changes.	0 – 20mm
М	Moderately reactive clay or silt sites, which may experience moderate ground movement from moisture changes.	20 – 40mm
H-1	Highly reactive clay sites, which may experience high ground movement from moisture changes.	40 – 60mm
H-2	Highly reactive clay sites, which may experience very high ground movement from moisture changes.	60 – 75mm
E	Extremely reactive sites, which may experience extreme ground movement from moisture changes.	>75mm

Note: Soils where foundation performance may be significantly affected by factors other than reactive soil movement are classified as **Class P**.

A site is classified as Class P when:

- The bearing capacity of the soil profile in the foundation zone is generally less than 100kpa
- If excessive foundation settlement may occur due to loading on the foundation.
- The site contains uncontrolled fill greater than 0.8m in depth for sandy sites and 0.4m in depth for other soil materials.
- The site is subject to mine subsistence, landslip, collapse activity or coastal erosion.
- The site is underlain by highly dispersive soils with significant potential forerosion
- If the site is subject to abnormal moisture conditions which can affect foundation performance



1.2 Soil Characterisation

This information explains the terms of phrase used within the soil description area of the report.

It includes terminology for cohesive and non-cohesive soils and includes information on how the Unified Soil Classification Scheme (USCS) codes are determined.

NON COHSIVE – SAND & GRAVEL					
Consistency Description	Field Test	Dynamic Cone Penetrometer blows/100 mm			
Very loose (VL)	Easily penetrated with 13 mm reinforcing rod pushed by hand.	0 - 1			
Loose (L)	Easily penetrated with 13 mm reinforcing rod pushed by hand. Can be excavated with a spade; 50 mm wooden peg can be easily driven.	1 - 3			
Medium dense (MD)	Penetrated 300 mm with 13 mm reinforcing rod driven with 2 kg hammer, - hard shovelling.	3 - 8			
Dense (D)	Penetrated 300 mm with 13 mm reinforcing rod driven with 2 kg hammer, requires pick for excavation: 50 mm wooden peg hard to drive.	8 - 15			
Very dense (VD)	Penetrated only 25 - 50 mm with 13 mm reinforcing rod driven with 2 kg hammer.	>15			

COHESIVE - SILT & CLAY						
Consistency Description	Field Test	Indicative undrained shear strength kPa				
Very soft	Easily penetrated >40 mm by thumb. Exudes between thumb and fingers when squeezed in hand.	<12				
Soft	Easily penetrated 10 mm by thumb. Moulded by light finger pressure	>12 and <25				
Firm	Impression by thumb with moderate effort. Moulded by strong finger pressure	>25 and <50				
Stiff	Slight impression by thumb cannot be moulded with finger.	>50 and <100				
Very Stiff	Very tough. Readily indented by thumbnail.	>100 and <200				
Hard	Brittle. Indented with difficulty by thumbnail.	>200				



1.3 USCS Material Descriptions

Soils for engineering purposes are the unconsolidated materials above bedrock, they can be residual, alluvial, colluvial or aeolian in origin.

Major Divisions		Particle size mm	USCS Group Symbol	Typical Names	Laboratory Classifica		essification				
(wa	BOULDERS	200			100000	.075 mm (2)	Plasticity of fine fraction	$C_{ii} = \frac{D_{ab}}{D_{ai}}$	$C_i = \frac{(D_{so})^i}{(D_{so})(D_{so})}$	NOTES	
	COBBLES	200									
man 0,075 mm)	-	63	GW	Well graded gravels and gravel-sand mixtures, little or no fines		0-5	-	>4	Between 1 and 3	(1) Identify fines by the method given	
Sarger	GRAVELS (more than	coarse	GP	Poorly graded gravels and gravel-sand mixtures, little or no fines, uniform gravels	Divisions	0-5	in .	Fails to	comply with	for fine-grained	
NED SC 63 mm	half of coarse	medium	GM	Silty gravels, gravel-sand-silt mixtures (1)	Wajor	12-50	Below 'A' line or PI<4	i E	-		
COARSE GRAINED SOIL	fraction is larger than 2.36 mm)	6 fine 2.38	GC	Clayey gravels, gravel-sand- clay mixtures (1)	i given in	12-50	Above 'A' line and PI>7		-	(2) Borderline	
8	SANDS	NDS ore than ore than ore than one of the coarse	SW	Well graded sands and gravelly sands, little or no fines	the catteria	0-5	2 4 8	>6	Between 1 and 3	classifications occur when the percentage of fines (fraction smaller than 0.075 mm size) is greater than	
than half of	(more than half of coarse fraction is smaller than 2.36 mm)		SP	Poorly graded sands and gravelly sands, little or no fines	ording to	0-5	-		comply with		
(more \$1			SM	Silty sands, sand silt mixtures (1)	ins acc	12-50	Below 'A' line or PI<4	-	=	5% and less than 12%. Borderline	
•			SC	Clayey sands, sand-clay mixtures (1)	1 of fractic	12-50	Above 'A' line and PI>7	-	-	classifications require the use of SP-SM, GW- GC.	
man 0.075 mm	(Liquid Limit ≤50%) CL medium plasticity, gravelly Cl clays, sandy clays, slity 🖁		ML	sands, rock flour, silty or clayey fine sands or clayey	Plasticity Char For classification of fine gra			ined soils			
smaller			Low Medium High				rained soils.				
SOILS			OL	Organic silts and clays of low plasticity	passin	10				11/2	
E GRANED SOILS less than 63 mm &			МН	Inorganic silts, mic- aceous or diato-maceous fine sands or silts, elastic silts	gradation curve of material passing	Plastic Index (%)			4/	The rates	
Fibra: Fibra: Fibra: (more than half of matedal les	SILTS & CLA (Liquid Limit		СН	Inorganic clays of high plasticity, fat clays	curve	Plastin	5.00	San Contraction	MIRC	96	
			ОН	Organic silts and clays of high plasticity	adation	90	Zem	W.	404		
	HIGHLY ORGANIC SOILS		PT	Peat and other highly organic soils	Use the gr	0	10 20	50 40 Liqu	se eo uid Limit (%)	00 80 90 100	



Grain size analysis is performed by two processes depending on particle size. Sand silt and clay particles are assessed using a standardised hydrometer test, and coarse sand and larger is assessed through sieving by USCS certified sieves. For more detail see the following section.

Soil Classification	Particle Size	
Clay	Less than 0.002mm	
Silt	0.002 – 0.06mm	
Fine/Medium Sand	0.06 – 2.0mm	
Coarse Sand	2.0mm – 4.75mm	
Gravel	4.75mm – 60.00mm	

1.4 Bearing Capacities and DCP testing.


DCP and PSP weighted penetrometer tests – Dynamic Cone Penetrometer (DCP) and Perth Sand Penetrometer (PSP) tests are carried out by driving a rod into the ground with a falling weight hammer and measuring the blows for successive 100mm increments of penetration. Normally, there is a depth limitation of 1.2m but this may be extended in certain conditions by the use of extension rods. The methods for the two tests are guite similar.

- Dynamic Cone Penetrometer a 16mm rod with a 20mm diameter cone end is driven with a 9kg hammer dropping 510mm (AS 1289, Test 6.3.2).
- Perth Sand Penetrometer a 16mm diameter flat-ended rod is driven with a 9kg hammer, dropping 600mm (AS 1289 Test 6.3.3). This test was developed for testing the density of sands and is mainly used in granular soils and filling.

Site Anomalies – During construction GES will need to be notified of any major variation to the foundation conditions as predicted in this report.



1.5 Batter Angles for Embankments (Guide Only)

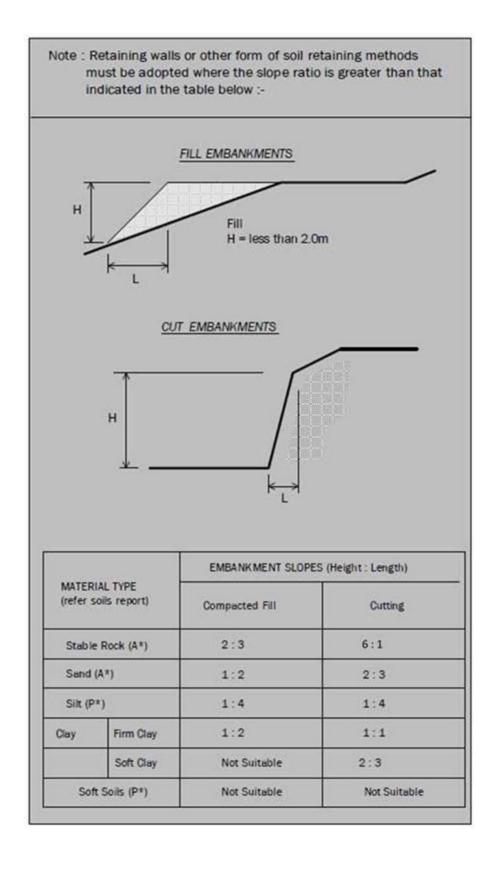



Glossary of Terms

Bearing Capacity – Maximum bearing pressure that can be sustained by the foundation from the proposed footing system under service loads which should avoid failure or excessive settlement.

Clay – (Mineral particles less than 0.002mm in diameter). Fine grained cohesive soil with plastic properties when wet. Also includes sandy clays, silty clays, and gravelly clays.

Dynamic Cone Penetrometer (DCP) – Field equipment used to determine underlying soil strength and therefore bearing capacity (kPa) by measuring the penetration of the device into the soil after each hammer blow.

Dispersive soil – A soil that has the ability to pass rapidly into suspension in water.

Footing – Construction which transfers the load from the building to the foundation.

Foundation – Ground which supports the building

Landslip – Foundation condition on a sloping site where downhill foundation movement or failure is a design consideration.

Qualified Engineer – A professional engineer with academic qualifications in geotechnical or structural engineering who also has extensive experience in the design of the footing systems for houses or similar structures.

Reactive Site – Site consisting of clay soil which swells on wetting and shrinks on drying by an amount that can damage buildings on light strip footings or unstiffened slabs. Includes sites classified as S, M, H-1, H-2 & E in accordance with AS2870-2011.

Sand – (Mineral particles greater than 0.02mm in diameter). Granular non-cohesive, non-plastic soil that may contain fines including silt or clay up to 15%.

Services – Means all underground services to the site including but not limited to power, telephone, sewerage, water & storm water.

Silt – (Mineral particles 0.002 – 0.02mm in diameter). Fine grained non-cohesive soil, non-plastic when wet. Often confers a silky smoothness of field texture, regularly includes clay and sand to form clayey silts, sandy silts and gravelly silts.

Site – The site title, as denoted by address, lot number, or Certificate of Title (CT) number, or Property Identification Number (PID).

Surface Movement (Ys) – Design movement (mm) at the surface of a reactive site caused by moisture changes.



Disclaimer

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The scope of this study does not allow for the review of every possible geotechnical parameter or the soil conditions over the whole area of the site. Soil and rock samples collected from the investigation area are assumed to be representative of the areas from where they were collected and not indicative of the entire site. The conclusions discussed within this report are based on observations and/or testing at these investigation points.


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Site Plan







APPENDIX 1 - DCP Results Table

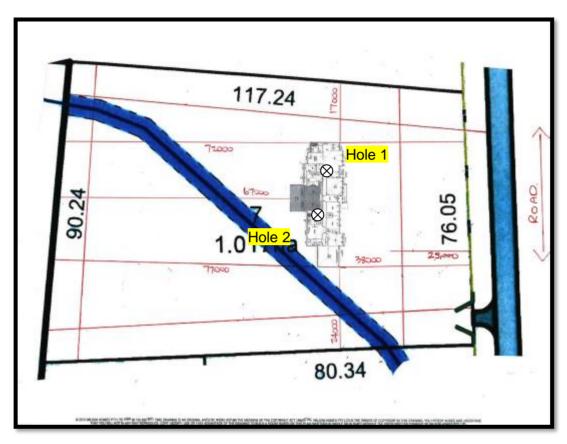Dynamic Cone Penetration (DCP) Conversion to Californian Bearing Ratio (ref: Australian Standard AS 1289.6.3.2 - 1997)

DCP Location BH1

Depth (mm)	DCP	DCP	DCP Resistance	Allowable Bearing Capacity	CBR (Rounded Up)
	(Blows/100mm)	(mm/Blow)	(mPa)	(kPa)	
0-100	5	20.0	1.6	174	10
100-200	15	6.7	4.7	521	35
200-300	12	8.3	3.8	417	27
300-400	4	25.0	1.3	139	8
400-500	10	10.0	3.1	347	22
500-600	10	10.0	3.1	347	22
600-700	9	11.1	2.8	313	20
700-800	6	16.7	1.9	208	13
800-900	5	20.0	1.6	174	10
900-1000	5	20.0	1.6	174	10
1000-1100	5	20.0	1.6	174	10
1100-1200	9	11.1	2.8	313	20
1200-1300	10	10.0	3.1	347	22
1300-1400	12	8.3	3.8	417	27
1400-1500	15	6.7	4.7	521	35
1500-1600	20	5.0	6.3	694	48



Appendix 2 – Site Photos









BH1 Core Tray

CERTIFICATE OF QUALIFIED PERSON – ASSESSABLE ITEM

Section 321

To:	Wilson Homes		Owner /Agent	EE	
	250 Murray Street		Address	Form 55	
	Hobart	7000	Suburb/postcode		
Qualified perso	on details:				
•					
Qualified person:	John-Paul Cumming				
Address:	29 Kirksway Place		Phone No:	03 6223 1839	
	Battery Point	7004	Fax No:		
Licence No:	AO999 Email address:	jcummin	g@geosolutio	ons.net.au	
Qualifications and Insurance details:	Certified Professional Soil Scientist (CPSS stage 2)	Direc	ription from Column tor's Determination ualified Persons for a	- Certificates	
Speciality area of expertise:	AS2870-2011 Foundation Classification	Direc	ription from Column 4 of the or's Determination - Certificates alified Persons for Assessable		
Details of work					
Address:	6 Thoroughbred Road			Lot No:	
	Orielton	7172	Certificate of	title No: 186369/7	
The assessable item related to this certificate:	Classification of foundation Colaccording to AS2870-2011	nditions	certified) Assessable item - a material; - a design - a form of co - a document - testing of a system or pi	nstruction	
Certificate deta	ils:				
Certificate type: F	Foundation Classification	So De Qu	escription from Colu hedule 1 of the Dire termination - Certifi valified Persons for sessable Items n)	ctor's	
This certificate is in	relation to the above assessable item	, at any stag	e, as part of - <i>(ti</i>	ck one)	
	building work, plumbing work or	r plumbing ir	nstallation or der	molition work	
	or a building, ten	nporary stru	cture or plumbin	g installation:	

In issuing this certificate the following matters are relevant –

Documents: The attached soil report for the address detailed above in 'details of

work'

Relevant

calculations: Reference the above report.

References: AS2870:2011 residential slabs and footings

AS1726:2017 Geotechnical site investigations

CSIRO Building technology file - 18.

Substance of Certificate: (what it is that is being certified)

Site Classification consistent with AS2870-2011.

Scope and/or Limitations

The classification applies to the site as inspected and does not account for future alteration to foundation conditions as a result of earth works, drainage condition changes or variations in site maintenance.

I, John-Paul Cumming certify the matters described in this certificate.

Qualified person:

Signed:

Certificate No:

J11483

14/03/2025

Date:

DISPERSIVE SOIL ASSESSMENT

6 Thoroughbred Road Orielton March 2025

Wilson Homes Reference: 714242





Development Application: 5.2025.158.1 -Development Application - 6 Thoroughbred Road, Orielton - P1.pdf Plans Reference: P1 Date Received: 16/06/2025

Disclaimer: The author does not warrant the information contained in this document is free from errors or omissions. The author shall not in any way be liable for any loss, damage or injury suffered by the User consequent upon, or incidental to, the existence of errors in the information.



Investigation Details

Client: Wilson Homes

Site Address: 6 Thoroughbred Road, Orielton

Date of Inspection: 12/03/2025

Proposed Works: New house

Investigation Method: Geoprobe 540UD - Direct Push

Inspected by: C. Cooper

Site Details

Certificate of Title (CT): 186369/7

Title Area: Approx. 1.021 ha

Applicable Planning Overlays: Bushfire-prone areas, Airport obstacle limitation area

Slope & Aspect: 2° W facing slope

Vegetation: Pasture

Ground Surface: Surface Cracks

Background Information

Geology Map: MRT

Geological Unit: Tertiary Sediments

Climate: Annual rainfall 550mm

Water Connection: Tank

Sewer Connection: Unserviced-On-site required

Testing and Classification: AS2870:2011, AS1726:2017 & AS4055:2021



Investigation

A number of bore holes were completed to identify the distribution and variation of the soil materials at the site, bore hole locations are indicated on the site plan. See soil profile conditions presented below. Tests were conducted across the site to obtain bearing capacities of the material at the time of this investigation.

Soil Profile Summary

BH 1 Depth (m)	BH 2 Depth (m)	uscs	Description
0.00-0.30	0.00-0.20	SM	Silty SAND: dark grey, brown, dry, dense
0.30-2.00	0.20-2.00+	СН	Silty CLAY : high plasticity, dark grey, brown, slightly moist, stiff,
2.00-3.00+		CI	Gravelly CLAY: medium plasticity, grey, brown, slightly moist, very stiff, no refusal

Site Notes

The soil on site has formed from Tertiary sediments. The subsoil was tested for dispersion using the Emerson Test and was found to be slightly dispersive Class 2(2) -obvious milkiness, <50% of the aggregate affected.

Dispersive Soil Assessment

The dispersive soil assessment of the property considers the proposed construction area.

Potential for dispersive soils

The site has been identified as an area subject to tunnel erosion hazard according to 'Dispersive Soils and Their Management: Technical Reference Manual'. This is due to the soils present on site that developed from Tertiary sediments that contain considerable fine sand/silt content and high plastic clays. Tertiary sediments in the local area is known to produce soils with an excess of sodium on the soil exchange complex, which can cause soil dispersion. Under some circumstances the presence of dispersive soils can also lead to significant erosion, and in particular tunnel erosion. Based upon field survey of the property, no visible tunnel or gully erosion was identified. However, a soil sampling program was undertaken to identify the presence of dispersive soils in the proposed development areas.

Soil sampling and testing

Samples were taken at the site for assessment of dispersion. An Emerson (1968) Dispersion test was conducted to determine if these samples were dispersive.

The soil samples taken from site were found to be Slightly dispersive Class 2(2) -obvious milkiness, <50% of the aggregate affected.



Management Recommendations

A number of site and soil management measures are recommended for development on the site.

The proposed site cut/fill and driveway areas must be managed by:

- Applying a geo-fabric, jute mesh or similar material to the exposed batters of any cutting on site and revegetating the slope
- Applying a surface layer of at least 50mm of suitable crushed rock/gravel to the driveway surface (and any proposed house pad), with adequate compaction to ensure a relatively impervious surface to maintain site surface stability
- Vegetation on any fill batters must be established and maintained, if any bare area of soil on the batter
 develops then it must be top-dressed with suitable topsoil and additional vegetation planted

The risk or erosion and tunnel erosion associated with construction must be minimized by:

- Any new water, power, or other service trenches within the property must ensure recommendations for dispersive soils are followed:
- o Where possible trenches to be placed shallow in topsoil and mounded over to achieve the required cover depth
- o If buried the trench must be backfilled in layers of no more than 200mm with clay with 5% by weight gypsum added (the clay must be sufficiently moist to allow good compaction).
- o The trench must be finished with at least 150mm depth of non-dispersive suitable topsoil and finished to a level at least 75mm above natural ground to allow for possible settlement
- Vegetation cover must be maintained wherever possible on the property
- Foundations may be placed into the natural soil; however, care must be taken to ensure all exposed soil in the foundation area is compacted and 1Kg/m2 of gypsum is applied. Excavated fill from the construction area is not recommended for reuse on site in landscaping unless it is appropriately treated with gypsum, compacted, and capped with topsoil with natural soil and gypsum
- All stormwater runoff from the dwelling to be directed to mains connection (all the drains are to be adequately treated with gypsum)
- Drainage of any site cut must not employ conventional rock drain construction; it must adhere to recommendations for dispersive soils (unless founded entirely in rock)
- All excavation works on site should be monitored for signs of soil dispersion and remedial action taken as required any excavated fill from the construction area is not recommended for reuse on site in landscaping unless it is appropriately treated with gypsum, compacted, and capped with topsoil



Conclusions

There is a low risk associated with dispersive soils and potential erosion on the site provided the recommendations in this report are adhered to. Efforts should be made to cover all exposed soils on cut/fill batters with topsoil and seeded with well suited pasture species to avoid rainwater, runoff, surface water flows from intercepting exposed subsoils.

A number of site management recommendations have been made in this report and further information can also be found in the publication "Dispersive soils and their management – Technical manual" (DPIWE Tas 2009)

It is recommended that during construction that GES be notified of any variation to the soil conditions as outlined in this report.

Dr John Paul Cumming B.Agr.Sc (hons) PhD CPSS GAICD

Environmental and Engineering Soil Scientist



Appendix 1- Soil test results

Laboratory Test Results

Sample Submitted By: C Cooper

Date Submitted: 12/03/2025

Sample Identification: 2 samples – 6 Thoroughbred Road, Orielton

Soil to be tested: Emerson soil dispersion test

Result:

Sample	Texture	Emerson class	Description
Sample 1	clay	Class 2 (2)	Some dispersion <50% affected
Sample 2	clay	Class 2 (2)	Some dispersion <50% affected

Notes: Some dispersion with obvious milkiness affecting <50% of the aggregate.

Sample Tested by: C Cooper

12/03/2025



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	<u> </u>
SHE	ET INDEX
1	COVER SHEET
2	SITE PLAN (1:200)
3	SITE PLAN(1:500)
4	SOIL & WATER MANAGEMENT PLAN
5	GROUND FLOOR PLAN (1:150)
6	GROUND FLOOR PLAN LHS (1:100)
7	GROUND FLOOR PLAN RHS (1:100)
8	ELEVATIONS / SECTION
9	ELEVATIONS
10	WINDOW & DOOR SCHEDULES
11	ROOF DRAINAGE PLAN
12	FLOOR COVERINGS
13	KITCHEN DETAILS
14	BUTLER'S PANTRY DETAILS
15	BATHROOM DETAILS
16	ENSUITE DETAILS
17	POWDER ROOM DETAILS
18	LAUNDRY DETAILS

PORCH 393.02 m HIGHLY REACTIVE / PROBLEMATIC SOIL TYPE. **REFER TO HYDRAULICS PLANS** AND DETAILS PREPARED BY

TOTAL FLOOR AREAS

ALFRESCO

GARAGE

LIVING

MAIN DWELLING, GROUND FLOOR

ON SITE WASTEWATER TREATMENT REQUIRED. REFER TO REPORT PREPARED BY **GES (TBC)**

GANDY AND ROBERTS

ON SITE STORMWATER MANAGEMENT. REFER TO REPORT PREPARED BY **GES/FLUSSIG (TBC)**

DISPERSIVE SOILS REFER TO DISPERSIVE SOIL **MANAGEMENT RECOMMENDATIONS AS PER REPORT PREPARED BY** GES (18.03.2025)

AS & NCC COMPLIANCE

HOUSING PROVISIONS PART 10.2.

ALL CONSTRUCTION TO BE IN ACCORDANCE WITH NCC 2022 AND APPLICABLE AUSTRALIAN STANDARDS AT TIME OF APPROVAL

- SLAB IN ACCORDANCE WITH AS 2870. REFER TO ENGINEERS DETAILS FOR ALL SLAB DETAILS
- BRICK CONTROL JOINTS PROVIDED IN ACCORDANCE WITH NCC 2022. ALL STEEL FRAMING TO BE DESIGNED TO AS 4100-2020 OR AS/NZS
- INSULATION TO BE INSTALLED IN ACCORDANCE WITH NCC 2022 AND ALL APPLICABLE AUSTRALIAN STANDARDS.
- TERMITE PROTECTION IN ACCORDANCE WITH AS 3660 AND NCC 2022. GLAZING IN ACCORDANCE WITH AS 1288 AND NCC 2022.
- SMOKE ALARMS IN ACCORDANCE WITH AS 3786 AND NCC 2022. INTERNAL WATERPROOFING IN ACCORDANCE WITH NCC 2022
- EXTERNAL WATERPROOFING IN ACCORDANCE WITH AS 3740 AND AS
- WET AREA FLOORS TO FALL TO FLOOR WASTES AT MIN. 1:80 AND MAX 1:50 GRADE (IF APPLICABLE). CONDENSATION MANAGEMENT IN ACCORDANCE WITH NCC 2019
- BUILDING SEALING IN ACCORDANCE WITH NCC 2022. SERVICES IN ACCORDANCE WITH NCC 2022.

SITE SPECIFIC CONTROLS

30.57

40.37

312.92

9 16

- EARTHWORKS IN ACCORDANCE WITH AS 3798-2007. EXTERNAL WALL WRAP (SARKING) IN ACCORDANCE WITH NCC 2022 (IF
- APPLICABLE).
 EXHAUST FANS DUCTED TO OUTSIDE AIR (IF APPLICABLE).

CONTROL	DETAILS
ACID SULPHATE SOIL	NO
BIODIVERSITY	NO
BUILDING ENVELOPE	NO
BUSHFIRE	BAL-12.5
CLIMATE ZONE (NCC)	ZONE 7 - COOL TEMPERATE
DESIGN WIND CLASSIFICATION	N3 (EXPOSED TBC)
ESTATE/DEVELOPER GUIDELINES	NO
FLOOD OVERLAY	NO
HERITAGE	NO
LANDSLIP HAZARD	NO
MINIMUM FLOOR LEVEL	NO
NATURAL ASSET CODE	NO
NOISE ATTENUATION	NO
SALINE SOIL	NO
SHIELDING FACTOR	NS - NO SHIELDING
SITE CLASSIFICATION	H2
SPECIFIC AREA PLAN OVERLAY	YES
DISPERSIVE SOILS	
TERRAIN CATEGORY	TC2
TOPOGRAPHIC CLASSIFICATION	T1
WATERWAY & COASTAL OVERLAY	NO
WIND REGION	A - NORMAL
WITHIN 1km CALM SALT WATER	NO
WITHIN 50km BREAKING SURF	12.70km
ZONING	RURAL LIVING
AIRPORT OBSTACLE LIMITATION	YES

BUILDING CONTROLS & COMPLIANCE					
CONTROL	REQUIRED	PROPOSED			
SETBACKS					
FRONT	MIN. 20,000mm	32,901mm			
SIDE A	MIN. 10,000mm	23,028mm			
SIDE B	MIN. 10,000mm	20,180mm			
REAR	MIN. 10,000mm	74,062mm			
BULK & SCALE					
SITE AREA	10,170m²				
LANDSCAPE	·				
NO APPLICABLE CONTROLS					
EARTHWORKS					
CUT DEPTH	MAX. 2,000mm	383mm			
FILL DEPTH	MAX. 1,000mm	331mm			
ACCESS & AMENITY					
PARKING SPACES	MIN. 2 SPACES	2 SPACES			


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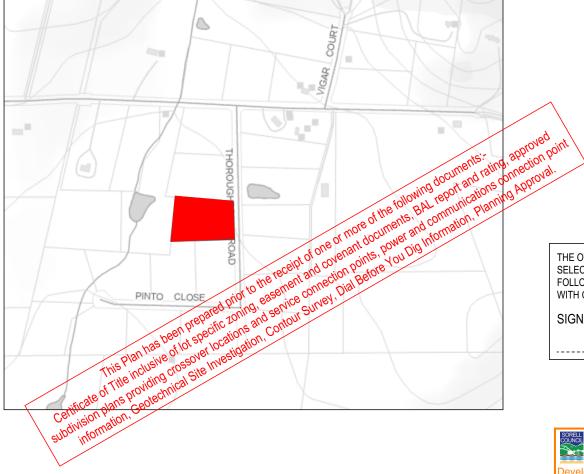
3D PERSPECTIVE



NOTE TO OWNER

THESE PLANS MAY FEATURE WORKS THAT ARE EXCLUDED FROM THE SCOPE OF WORKS WITH THE BUILDER, BUT THEY HAVE BEEN INCLUDED IN THESE DRAWINGS TO ASSIST IN THE OVERALL PLANNING AND ASSESSMENT OF THE BUILDING PROJECT. EXAMPLES OF SOME REGULARLY EXCLUDED WORKS INCLUDE DRIVEWAYS, RETAINING WALLS, SOLAR PANEL SPACING AND SITE DRAINAGE, PLEASE REFER TO YOUR SCOPE OF WORKS AND COLOUR SELECTIONS DOCUMENTATION FOR DETAILS OF INCLUDED WORKS. SOME DETAILS ARE INDICATIVE ONLY FOR EXAMPLE FLOORING, TILING, BRICKWORK AND CLADDING (EXPANSION JOINTS, ORIENTATION AND LAYOUT) AND ARE SUBJECT TO CHANGE.

LOCATION MAP

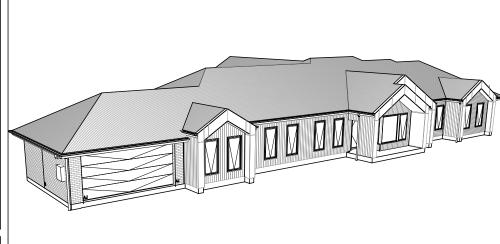

COUNCIL

SORELL

BUILDING INFORMATION

	GROUND FLOOR TOP OF WALL HEIGHT(S)	2595mm				
	NOTE: CEILING HEIGHT 45mm LOWER THA	NOTE: CEILING HEIGHT 45mm LOWER THAN TOP OF WALL				
	ROOF PITCH (U.N.O.)	30.0°				
	ELECTRICITY SUPPLY	SINGLE PHASE				
	GAS SUPPLY	NONE				
	ROOF MATERIAL	SHEET METAL				
	ROOF COLOUR	N/A				
	WALL MATERIAL	BRICK VENEER				
		CLADDING				
7	SLAB CLASSIFICATION	TBC				

INSULATION

ROOF	MIN. 60mm FOIL FACED BLANKET UNDER ROOFING
CEILING	R4.1 BATTS (EXCL. GARAGE, ALFRESCO)
EXT. WALLS	R2.0 BATTS (EXCL. GARAGE)
	WALL WRAP TO ENTIRE HOUSE
INT. WALLS	R2.0 BATTS ADJACENT TO GARAGE AND AS PER PLAN
FLOOR	BIAX SLAB R0.60

NCC 2022 LIVABLE HOUSING COMPLIANCE

ACCESSIBLE SANITARY COMPARTMENT: TBA ACCESSIBLE SHOWER LOCATION: TBA

GENERAL NOTES:

THRESHOLD OF ACCESSIBLE SHOWER ENTRY TO BE MAX 5MM

1 EXTERIOR DOOR NOMINATED AS 870 OR GREATER TO ACHIEVE MIN 820MM CLEAR OPENING REFER TO APPLICABLE WET AREA PLANS AND INTERIOR ELEVATIONS OR LOCATIONS OF REQUIRED WALL REINFORCEMENT FOR FUTURE GRAB RAIL INSTALLATION.

BUSHFIRE REQUIREMENTS - BAL-12.5

THE BUILDER USES MATERIALS THAT COMPLY WITH AS 3959-2018, NASH STANDARD STEEL FRAMED CONSTRUCTION IN BUSHFIRE AREAS 2014 OR HAVE BEEN TESTED TO AS 1530.8.1 IN ACCORDANCE WITH AS 3959-2018 (CLAUSE 3.8).

- PROVIDE FOIL FACED BLANKET INSULATION TO ALL COLORBOND SHEET ROOFING.
 PROVIDE SARKING TO ALL TILED ROOFING INCLUDING PRESSTITE TO
- VALLEYS. PROVIDE BAL-12.5 RATED DEKTITE TO ALL AIR VENTS ON ROOF PROVIDE BAL-12.5 RATED ALUMINIUM MESH TO ALL SOFFIT AND EAVE
- PROVIDE BAL-12.5 RATED ALUMINIUM MESH TO ALL EXHAUST VENTS.

WALLS, POSTS AND BEAMS: - PROVIDE SPARK ARRESTORS TO ALL EXTERNAL BRICKWORK.

EXTERNAL TIMBER POSTS WITHIN 400mm OF ADJACENT FINISHED FLOOR LEVEL TO BE BUSHFIRE-RESISTING TIMBER UNLESS MOUNTED ON STIRRUPS TO PROVIDE MIN. 75mm CLEARANCE ABOVE ADJACENT FINISHED FLOOR LEVEL.

/INDOWS AND DOORS

PROVIDE FLYSCREENS WITH CORROSION RESISTANT MESH TO ALL OPERABLE WINDOW SASHES (NO REQUIREMENT TO SCREEN BI-FOLD FRENCH / SLIDING / STACKER DOORS).
PROVIDE BAL-12.5 RATED ALUMINIUM WINDOWS AND EXTERNAL GLASS

- SLIDING / STACKER DOORS.
 SPECIFIED ALUMINIUM FRENCH DOORS HAVE BEEN TESTED TO AS
- 1530.8.1 WITHOUT SCREENS. SPECIFIED ALUMINIUM WINDOWS HAVE BEEN TESTED TO AS 1530.8.1
- WITHOUT SCREENS TO FIXED PANELS.
 PROVIDE ALUMINIUM DOOR JAMBS TO ALL EXTERNAL TIMBER DOORS. PROVIDE SAFETY SCREENS WITH CORROSION RESISTANT MESH TO
- EXTERNAL TIMBER HUNG DOORS (IF REQUIRED)
- PROVIDE SEAL TO ALL GARAGE PANELIFT / ROLLER DOORS.

PROVIDE COPPER WATER PIPES FROM WATER TANK TO HOUSE.

THE OWNERS ACKNOWLEDGE THAT THESE CONTRACT PLANS MAY NOT REFLECT ALL THE SELECTIONS THAT HAVE BEEN MADE OR CHANGES REQUESTED. THE OWNERS AGREE THAT FOLLOWING THE COLOUR SELECTIONS VARIATION OR UPDATING OF PLANS, THEY WILL BE PROVIDED WITH CONSTRUCTION PLANS FOR SIGNATURE PRIOR TO COMMENCEMENT OF CONSTRUCTION.

SHEET No :

1 / 18

SCALES:

1:100

SIGNATURE:

DATE:

Sorell Council

SANFORD 39

COVER SHEET

FACADE DESIGN:

OSLO

SHEET TITLE:

opment Application: 5.2025.158.1 evelopment Application - 6 Thoroughbred Road, Orielton - P1.pdf Plans Reference: P1

SUBJECT TO NCC 2022 (1 MAY 2023) WATERPROOFING & PLUMBING

PLAN ACCEPTANCE BY OWNER SIGNATURE: DATE:

SIGNATURE: DATE:

PLEASE NOTE THAT VARIATIONS WILL NOT BE ACCEPTED AFTER THIS PLAN ACCEPTANCE HAS BEEN SIGNED.

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CLG

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PRELIMINARY PLAN SET

PRELIMINARY PLAN SET - INITIAL ISSUE

AMENDMENT

No.

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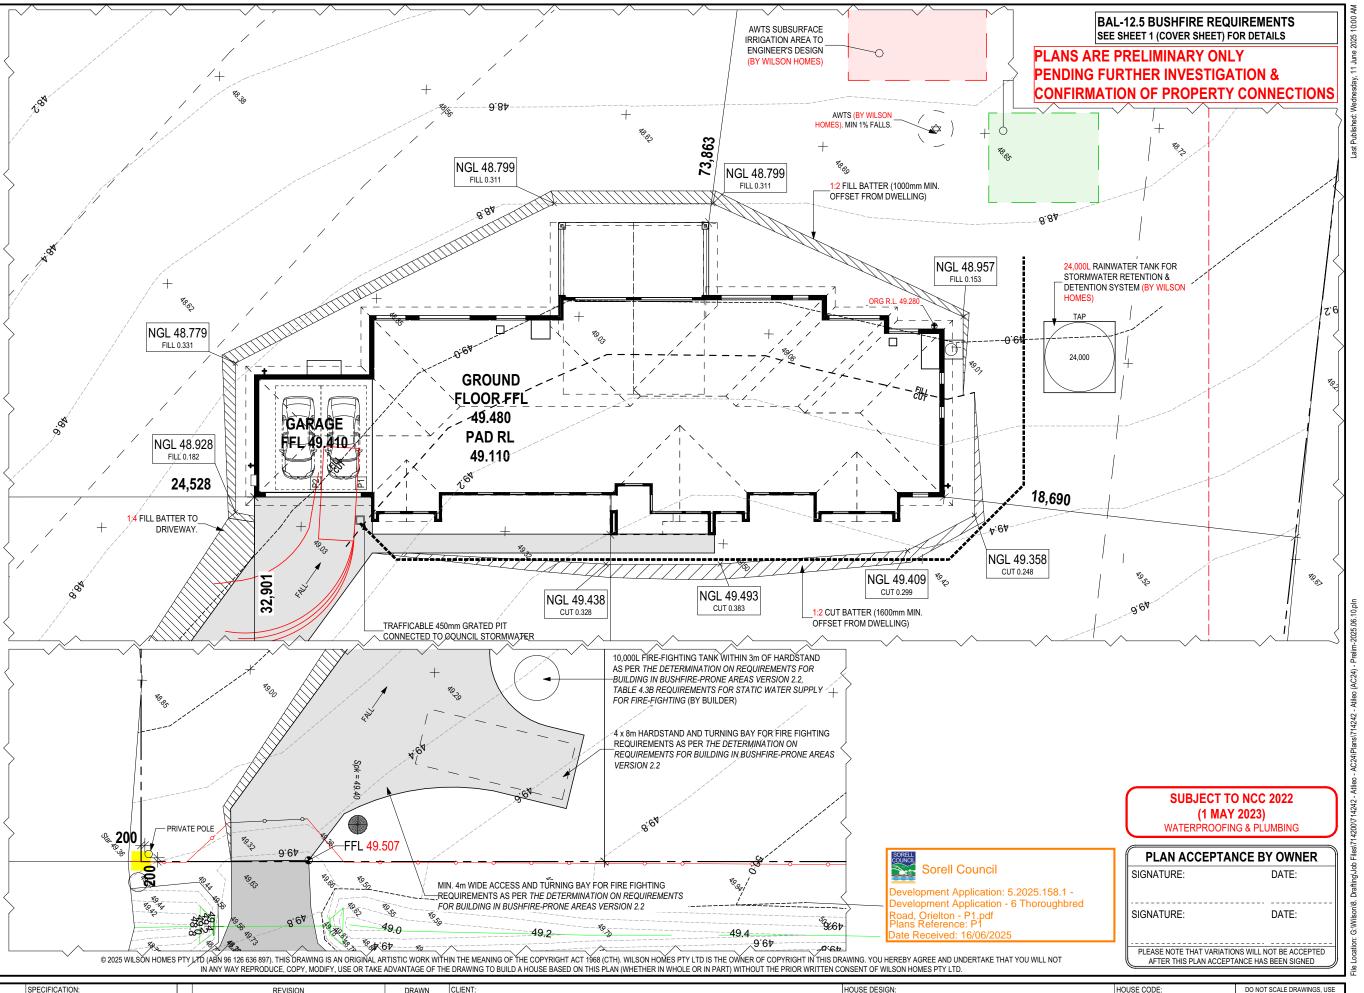
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714242

REFER TO SHEET 1 (COVER SHEET) FOR ALL BUILDING INFORMATION REGARDING: SUSTAINABILITY REQUIREMENTS SITE CLASSIFICATION GENERAL BUILDING INFORMATION APPROX. CUT/FILL 48.72m³ 109.62t 49.94m³ 112.37t DIFFERENCE 1.22m³ 2.75t **EVEN CUT & FILL** LOT SIZE: 10,170m² HOUSE (COVERED AREA) 394.12m² SITE COVERAGE: 3.88%



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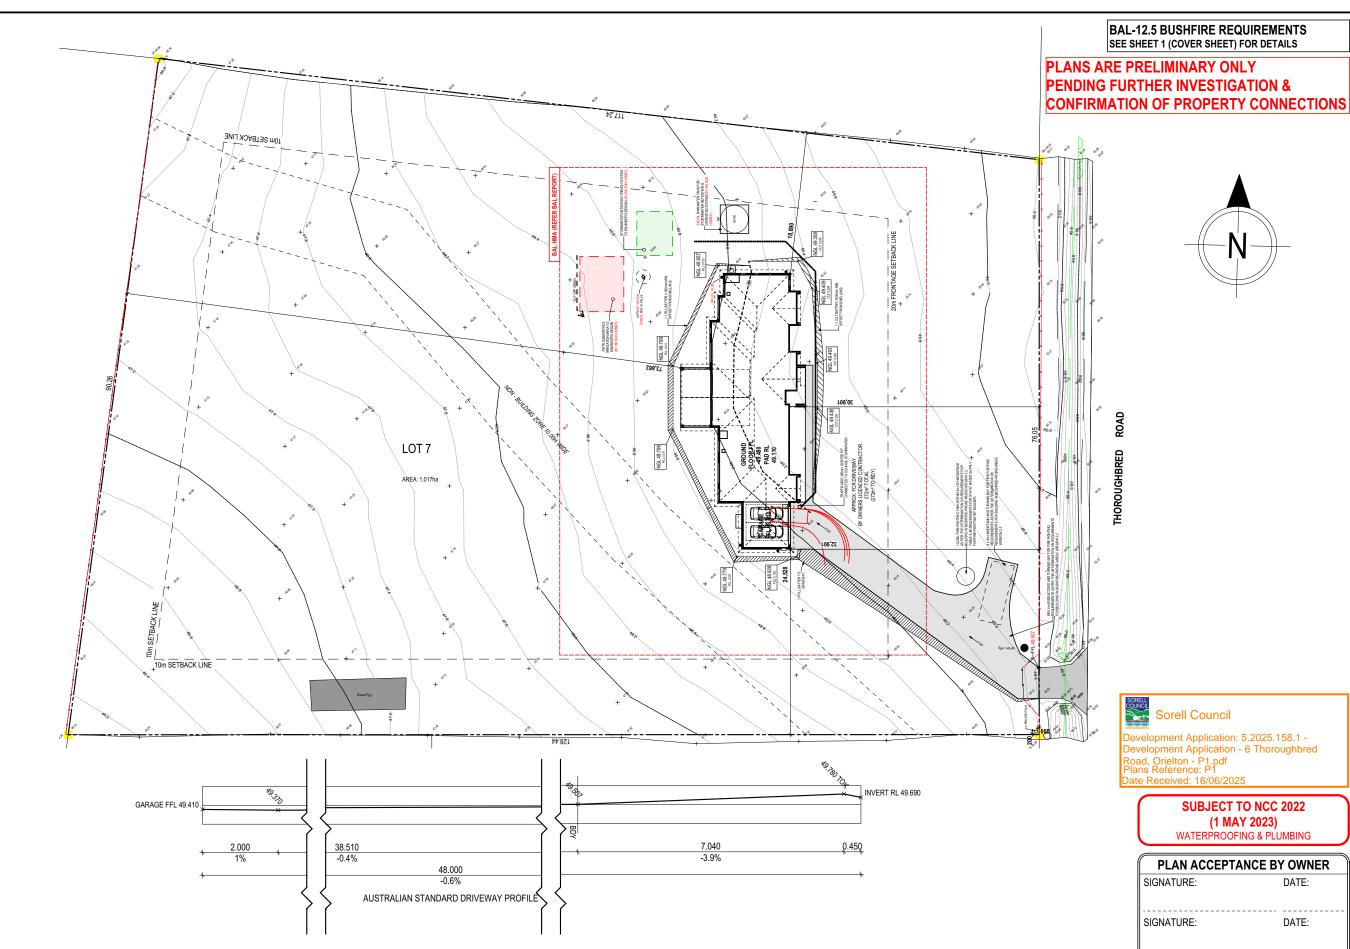
	SPECIFICATION:	REVISION	DRAWN CLIENT:	HOUSE DESIGN:	HOUSE CODE:	DO NOT SCALE DRAWINGS, USE FIGURED DIMENSIONS ONLY, CHECK
\mathbf{n}	NEXTGEN	1 DRAFT SALE PLAN - CT1	HMI 09/05/2025 CASSANDRA LEE & FALEUPOLO ATILEO	SANFORD 39	H-WATSFD30SA	AND VERIFY DIMENSIONS AND EVEL S PRIOR TO THE
UII	COPYRIGHT:	2 DRAFT SALE PLAN - CT1 - AMENMENT	HMI 15/05/2025 ADDRESS:	FACADE DESIGN:	FACADE CODE:	COMMENCEMENT OF ANY WORK. ALL
\bigcirc	© 2025	3 PRELIM PLANS - INITIAL ISSUE	TNG 11/06/2025 6 THOROUGHBRED ROAD, ORIELTON TAS 7172	OSLO	F-WATSFD30OSLOA	DISCREPANCIES TO BE REPORTED TO THE DRAFTING OFFICE.
.)			LOT / SECTION / CT: COUNCIL:		EET No.: SCALES:	714242
			7 / - / 186369 SORELL	SITE PLAN (1:200) 2	/ 18 1:200	

REFER TO SHEET 1 (COVER SHEET) FOR ALL BUILDING INFORMATION REGARDING: SUSTAINABILITY REQUIREMENTS SITE CLASSIFICATION GENERAL BUILDING INFORMATION

APPROX. CUT/FILL

EVEN CUT & FILL					
DIFFERENCE	1.22m³	2.75t			
FILL	49.94m³	112.37t			
CUT	48.72m³	109.62t			

LOT SIZE: 10,170m² HOUSE (COVERED AREA): 394.12m² SITE COVERAGE: 3.88%



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10	NEXTGEN	1 DRAFT SALE PLAN - CT1	нмі о	9/05/2025	CASSANDRA LEE & FA	LEUPOLO ATILEO	SANFORD 39		H-WATSFD30SA	FIGURED DIMENSIONS ONLY. CHECK AND VERIFY DIMENSIONS AND LEVELS PRIOR TO THE
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\cap	© 2025	3 PRELIM PLANS - INITIAL ISSUE	TNG 1	1/06/2025	6 THOROUGHBRED RO	AD, ORIELTON TAS 7172	OSLO		F-WATSFD30OSLOA	DISCREPANCIES TO BE REPORTED TO THE DRAFTING OFFICE.
\mathcal{E}					LOT / SECTION / CT:	COUNCIL:	SHEET TITLE:	SHEET No.:		714242
					7 / - / 186369	SORELL	SITE PLAN(1:500)	3 / 18	1:500	/ 4 /4/4 j

PLEASE NOTE THAT VARIATIONS WILL NOT BE ACCEPTED

AFTER THIS PLAN ACCEPTANCE HAS BEEN SIGNED

ALL VEGETATION OUTSIDE THE BUILDING ZONE WILL BE MAINTAINED.

OWNER TO STABILISE THE SITE ON COMPLETION OF THE BUILD WITH TURF LAWNS, GRASS SEEDS, NATIVE GROUND COVERS AND/ OR MULCH SPREAD TO A DEPTH OF 75-100mm

THE FOLLOWING IS A STANDARD
APPROACH. SEDIMENT AND EROSION
CONTROL MEASURES WILL BE REVIEWED
PRIOR TO COMMENCING WORK AND
INSTALLED BASED ON THE OUTCOME OF
THAT REVIEW.


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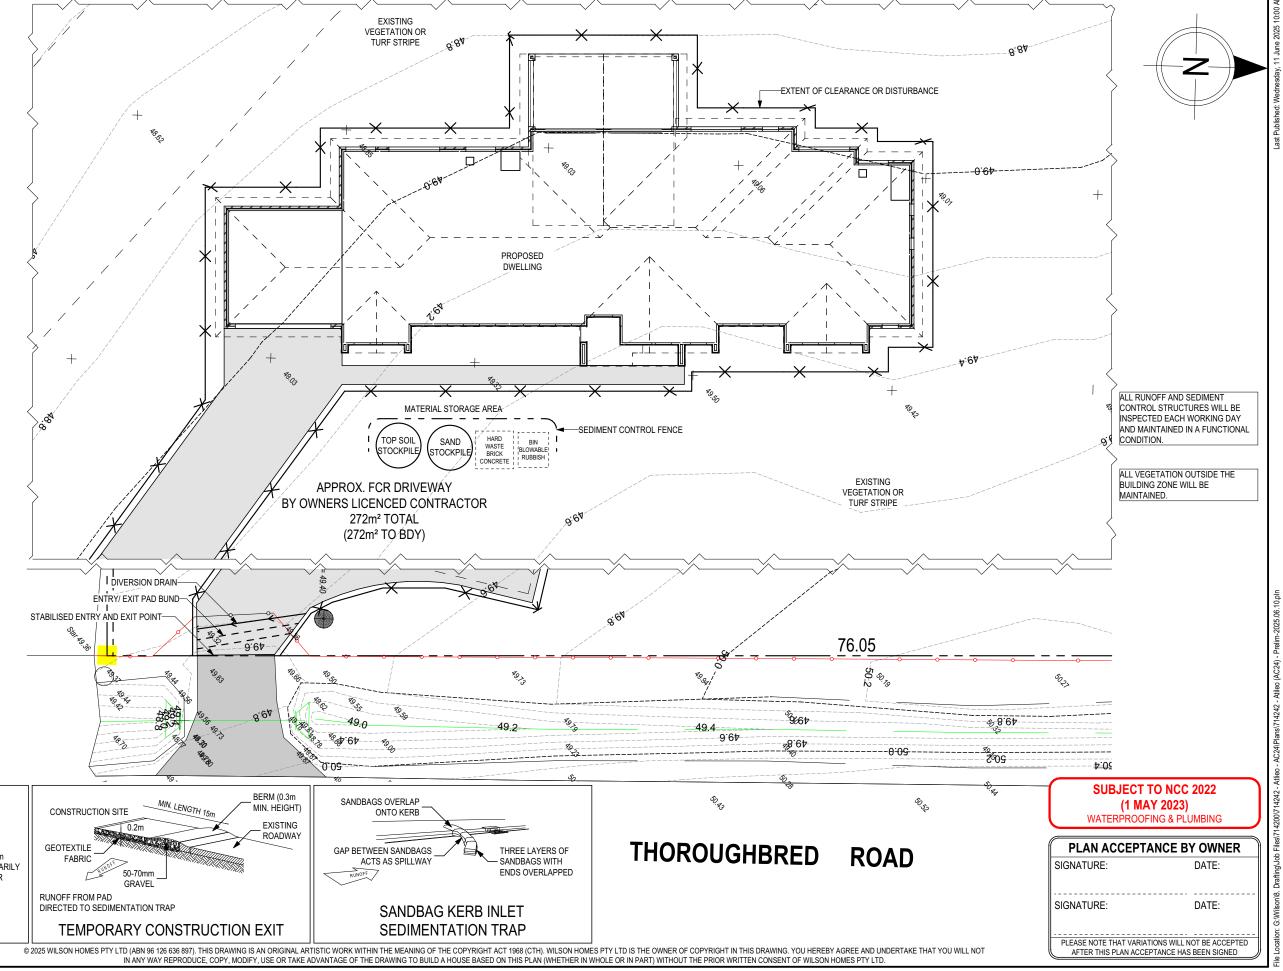
1. ALL EROSION AND SEDIMENT CONTROL STRUCTURES TO BE INSPECTED EACH WORKING DAY AND MAINTAINED IN GOOD WORKING ORDER.

- 2. ALL GROUND COVER VEGETATION
 OUTSIDE THE IMMEDIATE BUILDING AREA
 TO BE PRESERVED DURING THE BUILDING
 PHASE
- 3. ALL EROSION AND SEDIMENT CONROL MEASURES TO BE INSTALLED PRIOR TO COMMENCEMENT OF MAJOR EARTHWORKS.
- 4. STOCKPILES OF CLAYEY MATERIAL TO BE COVERED WITH AN IMPERVIOUS SHEET. 5. ROOF WATER DOWNPIPES TO BE CONNECTED TO THE PERMAMENT UNDERGROUND STORMWATER DRAINAGE SYSTEM AS SOON AS PRACTICAL AFTER THE ROOF IS LAID.
- 6. DIVERSION DRAINS ARE TO BE CONNECTED TO A LEAGAL DISCHARGE POINT (COUNCIL STORMWATER SYSTEM, WATERCOURSE OR ROAD DRAIN).
 7. SEDIMENT RETENTION TRAPS INSTALLED AROUND THE INLETS TO THE STORMWATER SYSTEM TO PREVENT SEDIMENT & OTHER DEBRIS BLOCKING THE DRAINS.



Development Application: 5.2025.158.1 Development Application - 6 Thoroughbred
Road, Orielton - P1.pdf
Plans Reference: P1
Date Received: 16/06/2025



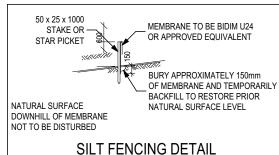



HOUSE CODE DO NOT SCALE DRAWINGS, US REVISION FIGURED DIMENSIONS ONLY, CHEC **NEXTGEN** HMI 09/05/2025 CASSANDRA LEE & FALEUPOLO ATILEO SANFORD 39 H-WATSFD30SA DRAFT SALE PLAN - CT1 AND VERIFY DIMENSIONS AND I EVELS PRIOR TO THE HMI 15/05/2025 ADDRESS: FACADE DESIGN: FACADE CODE: 2 DRAFT SALE PLAN - CT1 - AMENMENT DISCREPANCIES TO BE REPORTED TO THE DRAFTING OFFICE. TNG 11/06/2025 6 THOROUGHBRED ROAD, ORIELTON TAS 7172 F-WATSFD30OSLOA OSLO 3 PRELIM PLANS - INITIAL ISSUE LOT / SECTION / CT: SHEET TITLE: SHEET No.: SCALES COUNCIL 714242 SORELL 1:200 7 / - / 186369 SOIL & WATER MANAGEMENT PLAN 4 / 18

REFER TO SHEET 1 (COVER SHEET) FOR ALL BUILDING INFORMATION REGARDING: SUSTAINABILITY REQUIREMENTS

SITE CLASSIFICATION GENERAL BUILDING INFORMATION

ALL MECHANICAL VENTILATION TO BE DISCHARGED TO OUTDOOR AIR AS PER NCC 2022 REQUIREMENTS

FIRE RESISTANT PLASTERBOARD TO BE INSTALLED BEHIND COOKTOP

ALL GROUND FLOOR BULKHEAD AND SQUARE SET OPENING FRAMES TO BE 2155 ABOVE FFL UNLESS NOTED OTHERWISE

REFER TO WINDOW AND DOOR SCHEDULES FOR FULL DETAILS OF ALL WINDOWS AND DOORS. PLEASE NOTE WINDOW AND DOOR SIZES ARE BASED ON DEPOSIT STAGE AND MAY DIFFER SLIGHTLY TO THE SIZES NOMINATED IN THE SCOPE OF WORKS DUE TO MANUFACTURING CHANGES AT THE TIME OF CONSTRUCTION

FINAL WINDOW AND EXTERIOR DOOR LOCATIONS MAY BE ADJUSTED ON SITE TO SUIT BRICKWORK GAUGE

LINI ESS NOTED OTHERWISE ALL ROOMS ARE REFERENCED AS FOLLOWS:



LEGEND

HS / WS HOB SPOUT / WALL SPOUT

RENDER

SOUND INSULATION BRICK ARTICULATION JOINT A.I SDP

STANDARD DOWNPIPE

CDP CHARGED DOWNPIPE

DENOTES DRAWER SIDE 3D M MECHANICAL VENTILATION

L.B.W LOAD BEARING WALL

PLASTERBOARD PB FC FIBRE CEMENT

I),

THIS DOOR OPENS FIRST

LIFT OFF HINGE +

WATER POINT

SMOKE ALARM

GAS BAYONET


30.57 40.37 312.92 9 16

MAIN DWELLING, GROUND FLOOR ALFRESCO GARAGE LIVING PORCH 393.02 m² PROVIDE AND INSTALL SINGLE PHASE REVERSE CYCLE AIR CONDITIONING SYSTEM. NUMBER AND POSITIONING OF OUTLETS AND THE FINAL LOCATION OF THE RETURN AIR GRILLE WILL BE DETERMINED ON SITE BY THE AIR CONDITIONING CONTRACTOR AND IS SUBJECT TO TRUSS LAYOUT AND ANY OTHER CONSTRUCTION CONSTRAINTS.

FRAME MANUFACTURER TO PROVIDE CLEARANCE FOR PASSAGE OF FAN COIL UNIT FROM RETURN AIR OPENING TO FINAL FAN COIL LOCATION.

ANY PART OF THE FASCIA, GUTTERING OR DOWNPIPE THAT IS WITHIN 450mm OF ANY BOUNDARY IS TO BE NON-COMBUSTIBLE IN ACCORDANCE WITH NCC 2022

ALL EXTERIOR SLABS TO BE GRADED BY CONCRETER TO ACHIEVE APPROX. 1:100 FALL TO OUTSIDE EDGE WITH MAXIMUM CROSSFALL OF 30mm OVER ENTIRE SLAB.

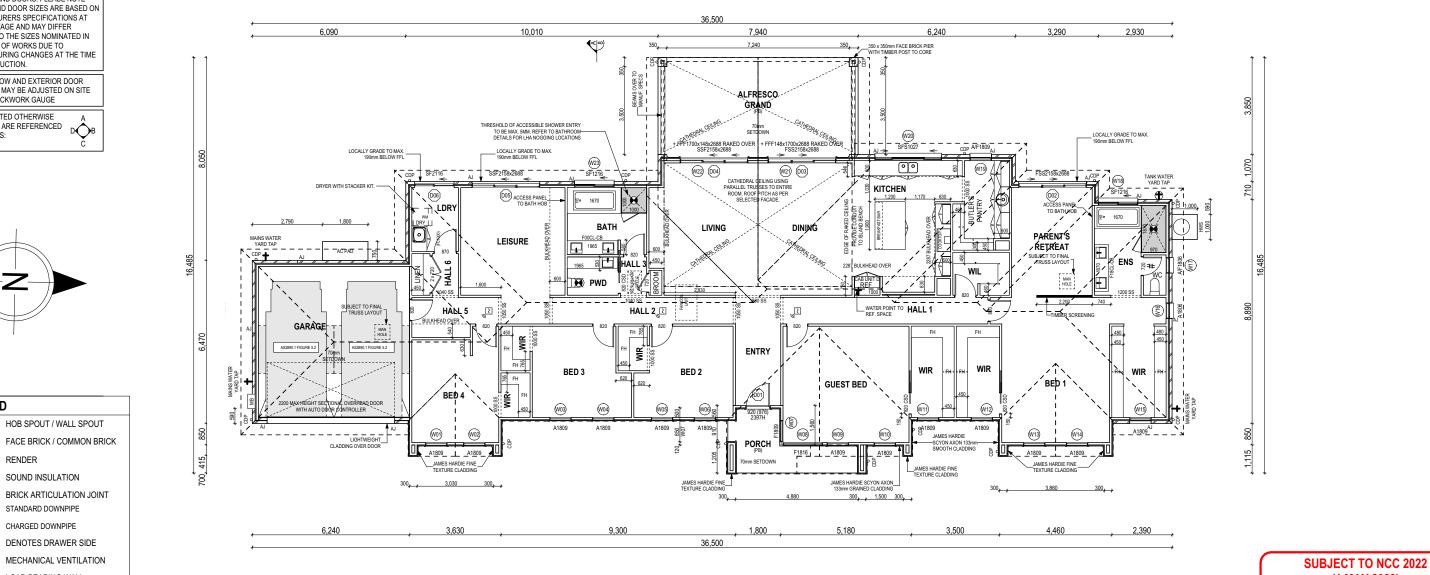

Sorell Council

evelopment Application: 5.2025.158.1 -Development Application - 6 Thoroughbred Road, Orielton - P1.pdf Plans Reference: P1 Date Received: 16/06/2025

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ì	NEXTGEN	1 DRAFT SALE PLAN - CT1	HMI 09/05/2025	CASSANDRA LEE & FALEUPOLO ATILEO	SANFORD 39	H-WATSFD30SA	FIGURED DIMENSIONS ONLY. CHECK AND VERIFY DIMENSIONS AND
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	© 2025	3 PRELIM PLANS - INITIAL ISSUE	TNG 11/06/2025	6 THOROUGHBRED ROAD, ORIELTON TAS 7172	OSLO	F-WATSFD30OSLOA	DISCREPANCIES TO BE REPORTED TO THE DRAFTING OFFICE.
				LOT / SECTION / CT: COUNCIL:	SHEET TITLE: SHEET	No.: SCALES:	744949
	,		1	7 / - / 186369 SORELL	GROUND FLOOR PLAN (1:150) 5 / 1	8 1:150	714242

(1 MAY 2023) WATERPROOFING & PLUMBING

PLAN ACCEPTANCE BY OWNER

PLEASE NOTE THAT VARIATIONS WILL NOT BE ACCEPTED


AFTER THIS PLAN ACCEPTANCE HAS BEEN SIGNED

DATE:

DATE:

SIGNATURE:

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GROUND FLOOR PLAN LHS (1:100)

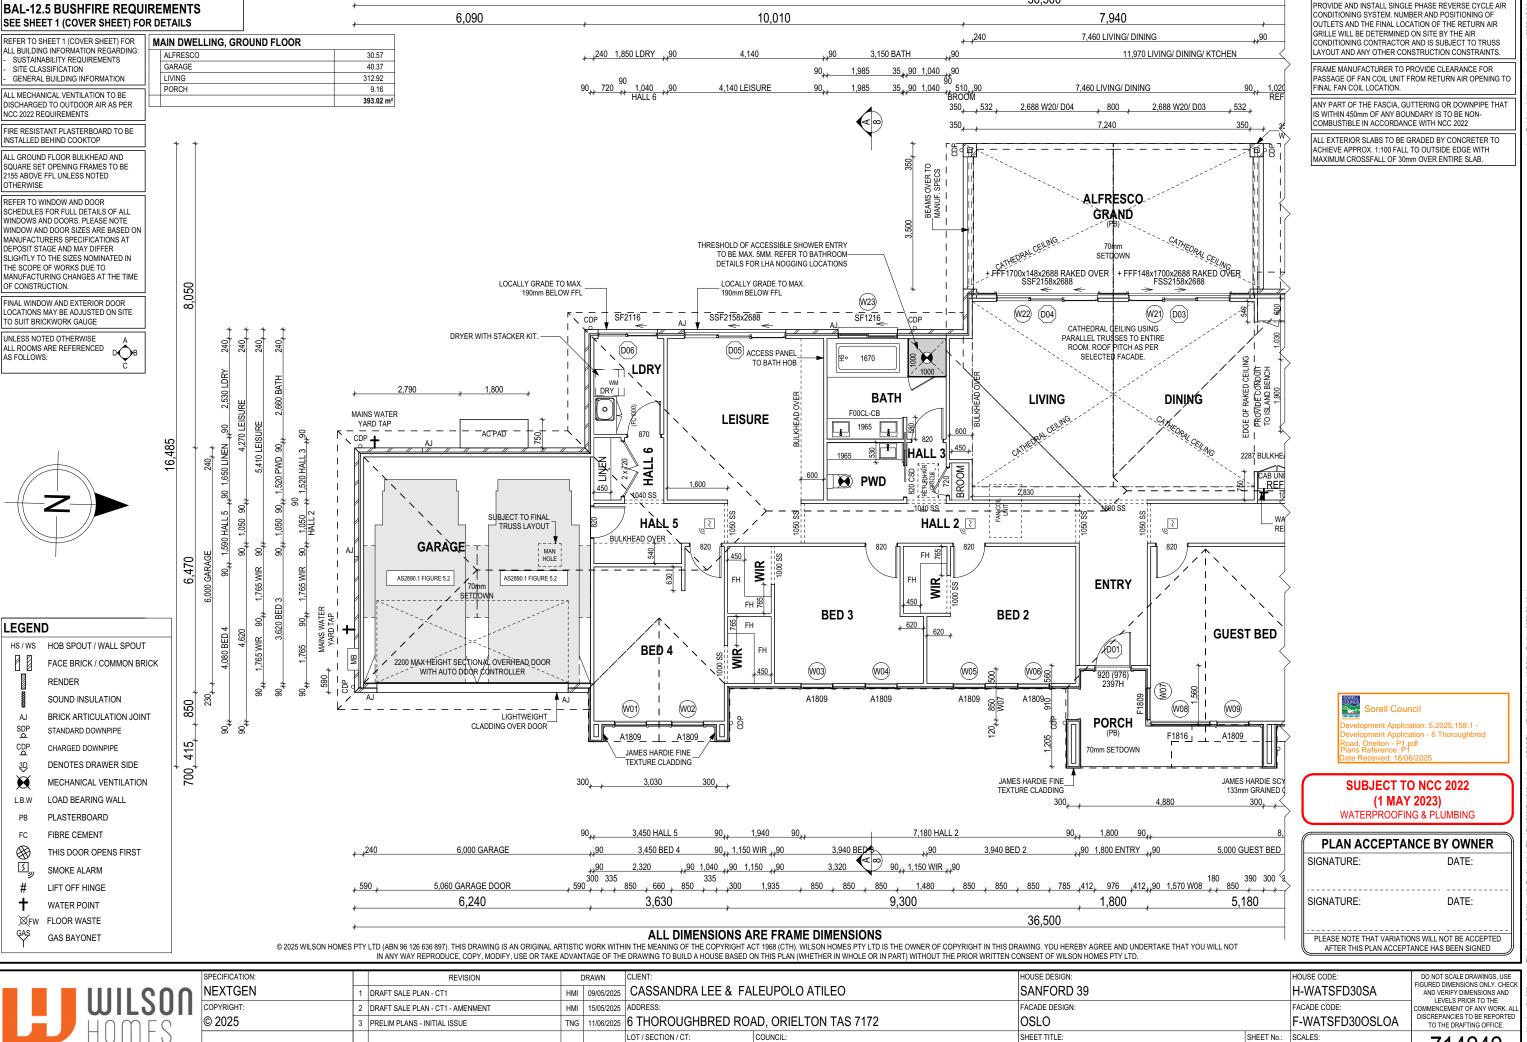6 / 18

1:100

7 / - / 186369

Template Version: 24.038

MAIN DWELLING, GROUND FLOOR

ALFRESCO

GARAGE

LIVING

PORCH

REFER TO SHEET 1 (COVER SHEET) FOR ALL BUILDING INFORMATION REGARDING SUSTAINABILITY REQUIREMENTS

GENERAL BUILDING INFORMATION ALL MECHANICAL VENTILATION TO BE DISCHARGED TO OUTDOOR AIR AS PER NCC 2022 REQUIREMENTS


FIRE RESISTANT PLASTERBOARD TO BE INSTALLED BEHIND COOKTOP


ALL GROUND FLOOR BULKHEAD AND SQUARE SET OPENING FRAMES TO BE 2155 ABOVE FFL UNLESS NOTED


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FINAL WINDOW AND EXTERIOR DOOR LOCATIONS MAY BE ADJUSTED ON SITE TO SUIT BRICKWORK GAUGE

LINI ESS NOTED OTHERWISE ALL ROOMS ARE REFERENCED AS FOLLOWS:



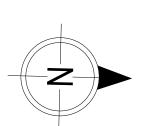

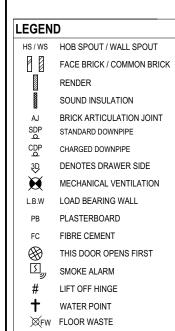

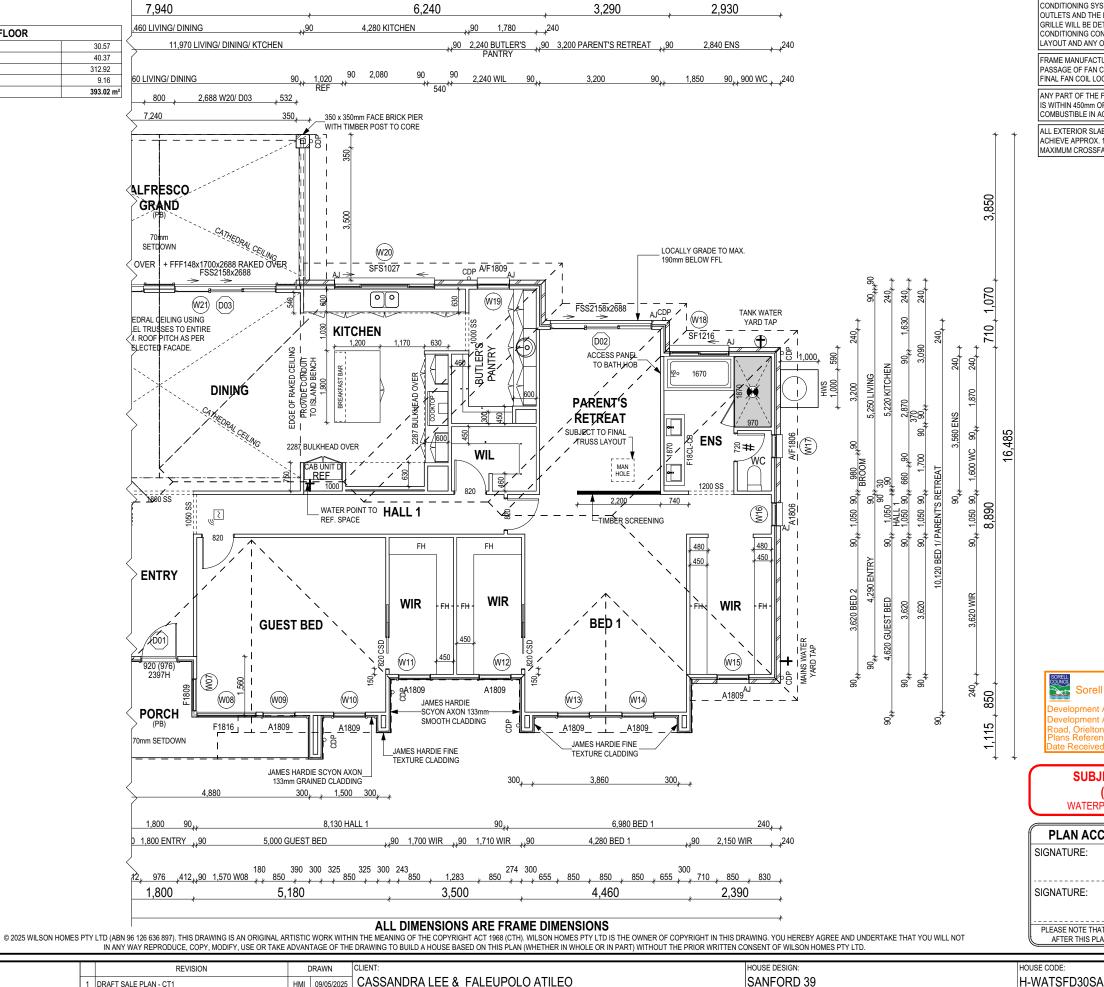CONDITIONING SYSTEM, NUMBER AND POSITIONING OF OUTLETS AND THE FINAL LOCATION OF THE RETURN AIR GRILLE WILL BE DETERMINED ON SITE BY THE AIR CONDITIONING CONTRACTOR AND IS SUBJECT TO TRUSS LAYOUT AND ANY OTHER CONSTRUCTION CONSTRAINTS.

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Sorell Council

nent Application: 5.2025.158.1 ment Application - 6 Thoroughbred rielton - P1.pdf eference: P1

SUBJECT TO NCC 2022 (1 MAY 2023)

WATERPROOFING & PLUMBING

PLAN ACCEPTANO	CE BY OWNER	i
SIGNATURE:	DATE:	
SIGNATURE:	DATE:	

PLEASE NOTE THAT VARIATIONS WILL NOT BE ACCEPTED AFTER THIS PLAN ACCEPTANCE HAS BEEN SIGNED

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	SPECIFICATION:		REVISION		DRAWN	C
1	NEXTGEN	1	DRAFT SALE PLAN - CT1	НМІ	09/05/2025	
	COPYRIGHT:	2	DRAFT SALE PLAN - CT1 - AMENMENT	НМІ	15/05/2025	Α
	© 2025	3	PRELIM PLANS - INITIAL ISSUE	TNG	11/06/2025	6
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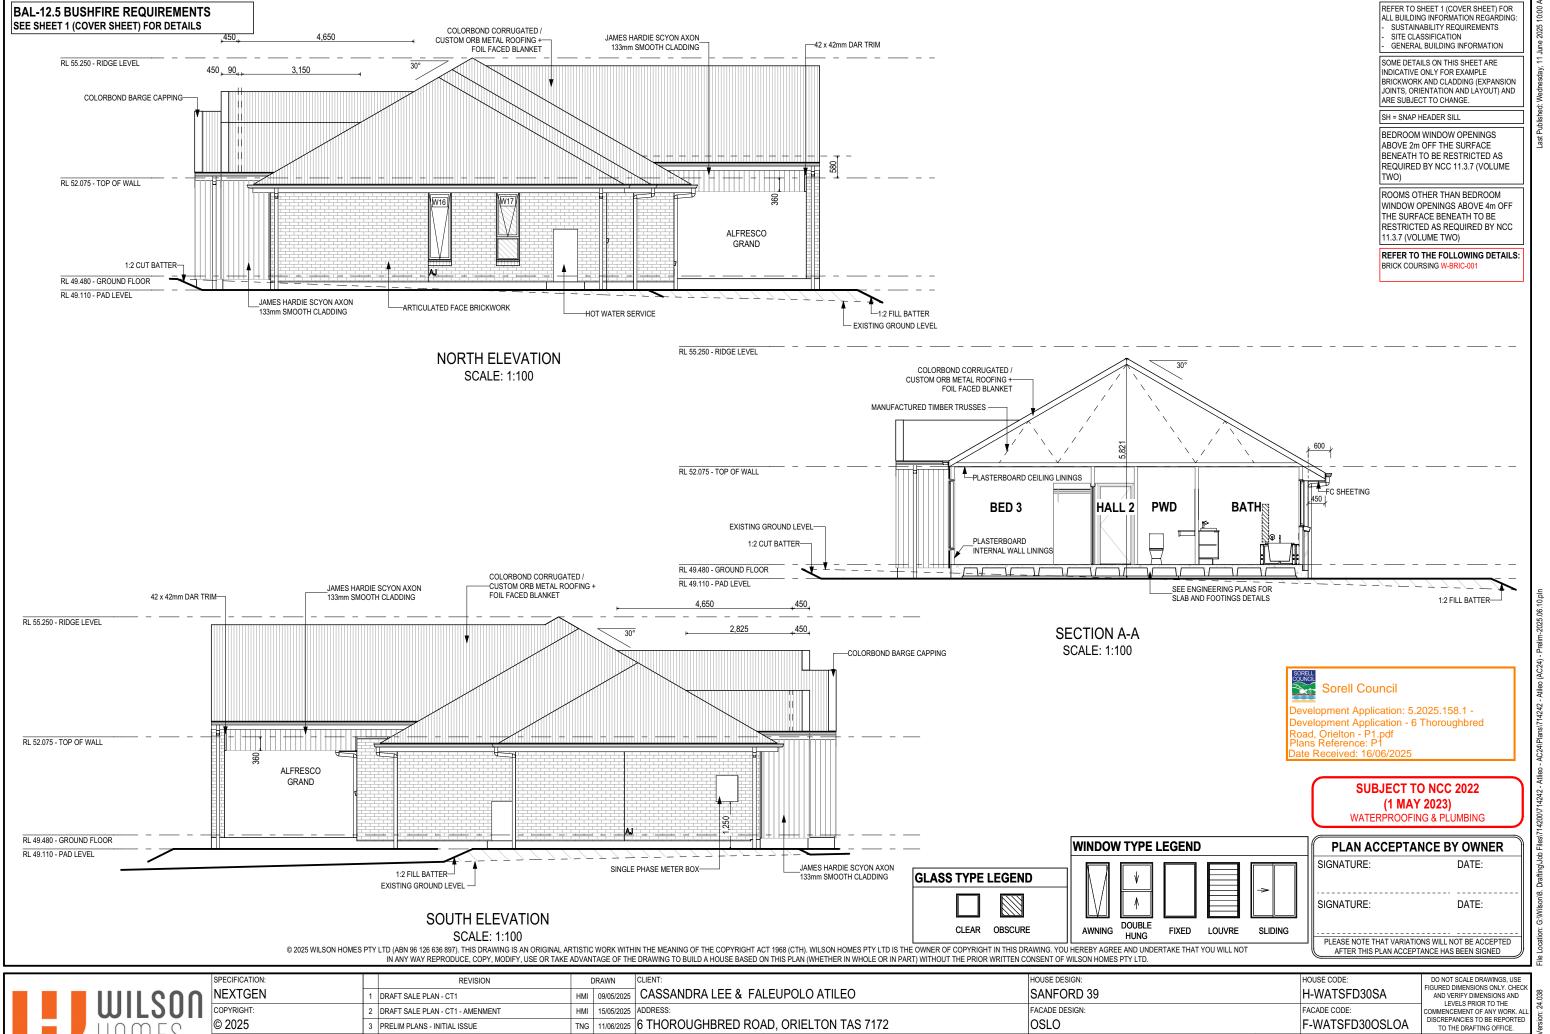
CASSANDRA LEE & FALEUPOLO ATILEO ADDRESS: 6 THOROUGHBRED ROAD, ORIELTON TAS 7172 LOT / SECTION / CT: COUNCIL

7 / - / 186369

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FACADE DESIGN: FACADE CODE: OSLO SHEET TITLE: SHEET No.: SCALES: GROUND FLOOR PLAN RHS (1:100) 7 / 18 1:100

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COUNCIL:

SORELL

LOT / SECTION / CT:

7 / - / 186369

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SHEET No.: SCALES:

1:100

8 / 18

WEST ELEVATION SCALE: 1:125


SUBJECT TO NCC 2022 (1 MAY 2023) WATERPROOFING & PLUMBING

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CLEAR



WINDOW TYPE LEGEND

HUNG

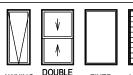SLIDING LOUVRE

SIGNATURE: DATE: SIGNATURE: DATE:

PLAN ACCEPTANCE BY OWNER

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REVISION NEXTGEN HMI 09/05/2025 CASSANDRA LEE & FALEUPOLO ATILEO DRAFT SALE PLAN - CT1 HMI 15/05/2025 ADDRESS: 2 DRAFT SALE PLAN - CT1 - AMENMENT TNG 11/06/2025 6 THOROUGHBRED ROAD, ORIELTON TAS 7172 3 PRELIM PLANS - INITIAL ISSUE LOT / SECTION / CT: COUNCIL: SORELL 7 / - / 186369

GLASS TYPE LEGEND

OUSE DESIGN HOUSE CODE SANFORD 39 H-WATSFD30SA FACADE DESIGN: FACADE CODE: F-WATSFD30OSLOA OSLO SHEET TITLE: SHEET No.: SCALES: **ELEVATIONS** 9 / 18 1:125

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File Location: G:Wilson/8. Drafting/Job Files/714200/714242 - Attieo - AC24/Plans/714242 -
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E)	
E)	
Manufacturer	- Clark Wi
Window Type	
Awning	рс
Awiiiig	
Fixed	
Sliding	
Fixed Pane)
Fixed Glass P	s Panel Hing
	or
Sliding Door	
Sliding Door	
Sliding Door Stacking Door	oor
Stacking Door	

Provide BAL-12.5 rated aluminium windows and external glass sliding doors in lieu

Provide flyscreens with corrosion resistant mesh to all opening window sashes only

INTERIOR WINDOW & DOOR SCHEDULE STOREY QTY CODE TYPE HEIGHT WIDTH GLAZING TYPE ADDITIONAL INFORMATION DOOR GROUND FLOOR 4 1000 SS SQUARE SET OPENING 2,155 1,000 N/A GROUND FLOOR 1040 SS SQUARE SET OPENING 2,155 1,040 N/A GROUND FLOOR 1050 SS SQUARE SET OPENING 2,155 1,050 N/A GROUND FLOOR 1200 SS SQUARE SET OPENING 2,155 1,200 N/A GROUND FLOOR 1800 SS SQUARE SET OPENING 1,800 N/A 2,155 GROUND FLOOR SWINGING 2,040 1,440 N/A 2 x 720 GROUND FLOOR 2,040 720 N/A LIFT-OFF HINGES 720 SWINGING SWINGING 2,040 GROUND FLOOR 720 720 N/A GROUND FLOOR 820 **SWINGING** 2.040 820 N/A GROUND FLOOR 3 820 CSD **CAVITY SLIDING** 2,040 820 N/A GROUND FLOOR 1 870 **SWINGING** 2,040 870 N/A

2 DRAFT SALE PLAN - CT1 - AMENMENT

3 PRELIM PLANS - INITIAL ISSUE

Sorell Council

Development Application: 5.2025.158.1 -

Development Application - 6 Thoroughbred Road, Orielton - P1.pdf Plans Reference: P1 Date Received: 16/06/2025

PICTURE, TV RECESS AND SS WINDOW OPENINGS QTY TYPE | HEIGHT | WIDTH | AREA (m²)

NOTE: INTERNAL DOORS TO WET AREAS WITH MECHANICAL VENTILATION TO BE UNDERCUT 20mm

HMI 15/05/2025 ADDRESS:

LOT / SECTION / CT:

7 / - / 186369

BAL-12.5 BUSHFIRE REQUIREMENTS SEE SHEET 1 (COVER SHEET) FOR DETAILS

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> > COUNCIL:

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IINMEC	© 2025
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REFER TO SHEET 1 (COVER SHEET) FOR

ALL BUILDING INFORMATION REGARDING:

SUSTAINABILITY REQUIREMENTS

GENERAL BUILDING INFORMATION

SPECIFICATION DRAWN REVISION HMI 09/05/2025 CASSANDRA LEE & FALEUPOLO ATILEO NEXTGEN DRAFT SALE PLAN - CT1

TNG 11/06/2025 6 THOROUGHBRED ROAD, ORIELTON TAS 7172

HOUSE DESIGN:		HOUSE CODE:	DO NOT SCALE DRAWINGS, USE
SANFORD 39		H-WATSFD30SA	FIGURED DIMENSIONS ONLY. CHECK AND VERIFY DIMENSIONS AND LEVELS PRIOR TO THE
FACADE DESIGN:		FACADE CODE:	COMMENCEMENT OF ANY WORK. ALL
OSLO		F-WATSFD30OSLOA	DISCREPANCIES TO BE REPORTED TO THE DRAFTING OFFICE.
SHEET TITLE:	SHEET No.:	SCALES:	744040
WINDOW & DOOR SCHEDULES	10 / 18		/14242

3.2 0.67 Double Sliding 6.4 0.76 Single Double 4.2 0.59 **Fixed Pane** Single 5.9 0.75 Double 3.2 0.67 **Fixed Glass Panel Hinged Door** Single 6.0 0.62 0.55 Double 4.3 Sliding Door 6.1 0.74 Single **Double** 3.6 0.66 Stacking Door 6.3 0.74 Single **Double** 3.8 0.66 135 deg. Awning Bay Window Single 6.5 0.67 4.1 0.57 Double 135 deg. Sliding Bay Window Single 6.5 0.76 4.2 0.59 **Double** 90 deg. Awning Bay Window 6.5 0.67 Single 0.57 Double 4.1 90 deg. Sliding Bay Window 6.5 0.76 Single Double 4.2 0.59 Bifold Doors Single 6.1 0.61 Double 4.4 0.5

Glazing U-Value SHGC

6.5

4.1

5.9

0.67 0.57

0.75

Single

Single


Double

Windows supplied MUST HAVE Uw better and or equal to stated figures and SHGC within +/- 5% of stated figures. Restricted windows to have their openability restricte as per N.C.C 11.3.6.

> **SUBJECT TO NCC 2022** (1 MAY 2023) WATERPROOFING & PLUMBING

PLAN ACCEPTANCE BY OWNER SIGNATURE: DATE: SIGNATURE: DATE:

PLEASE NOTE THAT VARIATIONS WILL NOT BE ACCEPTED AFTER THIS PLAN ACCEPTANCE HAS BEEN SIGNED

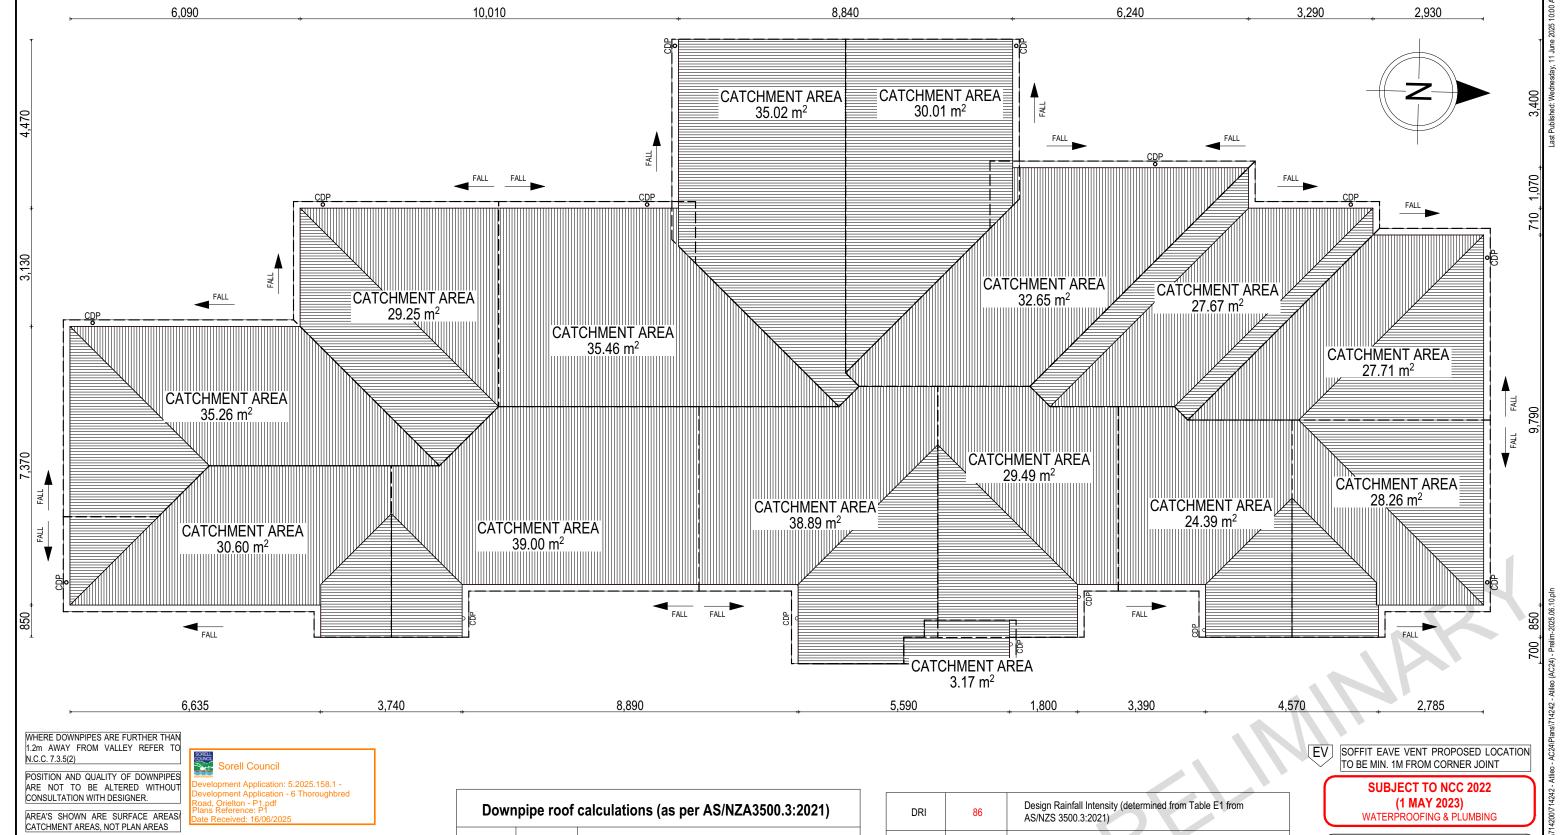

Roofi	ng Data	
	428.32	Flat Roof Area (excluding gutter and slope factor) (m²)
	574.02	Roof Surface Area (includes slope factor, excludes gutter) (m²)

446.83 Area of roof catchment (including 115mm Slotted Quad Gutter) (m²) Ah Ah x Catchment Area Multiplier for slope (Table 3.4.3.2 from AS/NZS 3500.3:2021) (1.29 for 30° pitch) (m²) 576.41 Ac

Cross sectional area of 57 x 115 Slotted Quad Gutter (mm²)


DRI	86	Design Rainfall Intensity (determined from Table E1 from AS/NZS 3500.3:2021)
Acdp	64	Catchment area per Downpipe (determined from Figure 3.5(A) from AS/NZS 3500.3:2021) (m²)
Required Downpipes	9	Ac / Acdp
Downpipes Provided	15	

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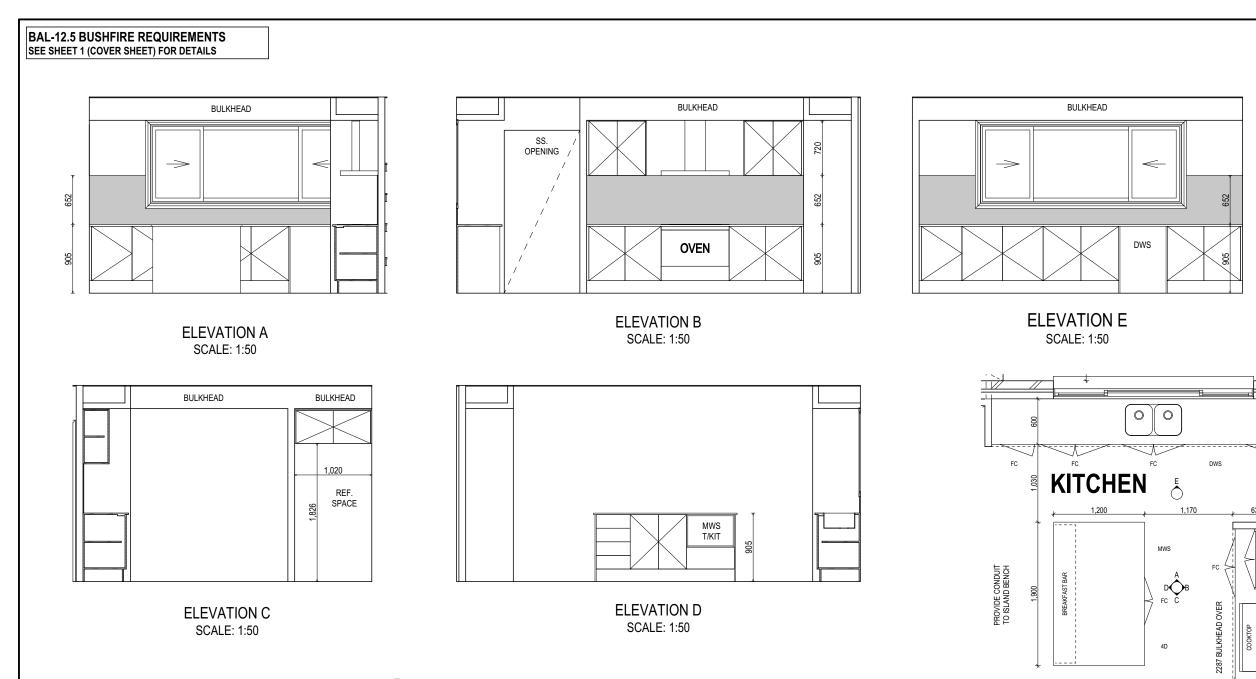
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	SPECIFICATION:	REVISION	DRAWN CLIENT:		HOUSE DESIGN:	HOUSE CODE:	DO NOT SCALE DRAWINGS, USE
n	NEXTGEN	1 DRAFT SALE PLAN - CT1	HMI 09/05/2025 CASSANDRA LEE & FA	LEUPOLO ATILEO	SANFORD 39	H-WATSFD30SA	FIGURED DIMENSIONS ONLY. CHECK AND VERIFY DIMENSIONS AND LEVELS PRIOR TO THE 15:
JII	COPYRIGHT:	2 DRAFT SALE PLAN - CT1 - AMENMENT	HMI 15/05/2025 ADDRESS:		FACADE DESIGN:	FACADE CODE:	COMMENCEMENT OF ANY WORK. ALL
$\overline{}$	© 2025	3 PRELIM PLANS - INITIAL ISSUE	TNG 11/06/2025 6 THOROUGHBRED ROA	AD, ORIELTON TAS 7172	OSLO	F-WATSFD30OSLOA	DISCREPANCIES TO BE REPORTED TO THE DRAFTING OFFICE.
)				COUNCIL:	SHEET TITLE:	SHEET No.: SCALES:	711010
			7 / - / 186369	SORELL	ROOF DRAINAGE PLAN	11 / 18 1:100	714242



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10	NEXTGEN	1	DRAFT SALE PLAN - CT1	НМІ	09/05/2025	CASSANDRA LEE & FALEUPOLO ATILEO	SANFORD 39		H-WATSFD30SA	FIGURED DIMENSIONS ONLY. CHECK AND VERIFY DIMENSIONS AND LEVELS PRIOR TO THE	.038
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SUBJECT TO NCC 2022 (1 MAY 2023) WATERPROOFING & PLUMBING

PLAN ACCEPTANCE BY OWNER					
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KITCHEN PLAN

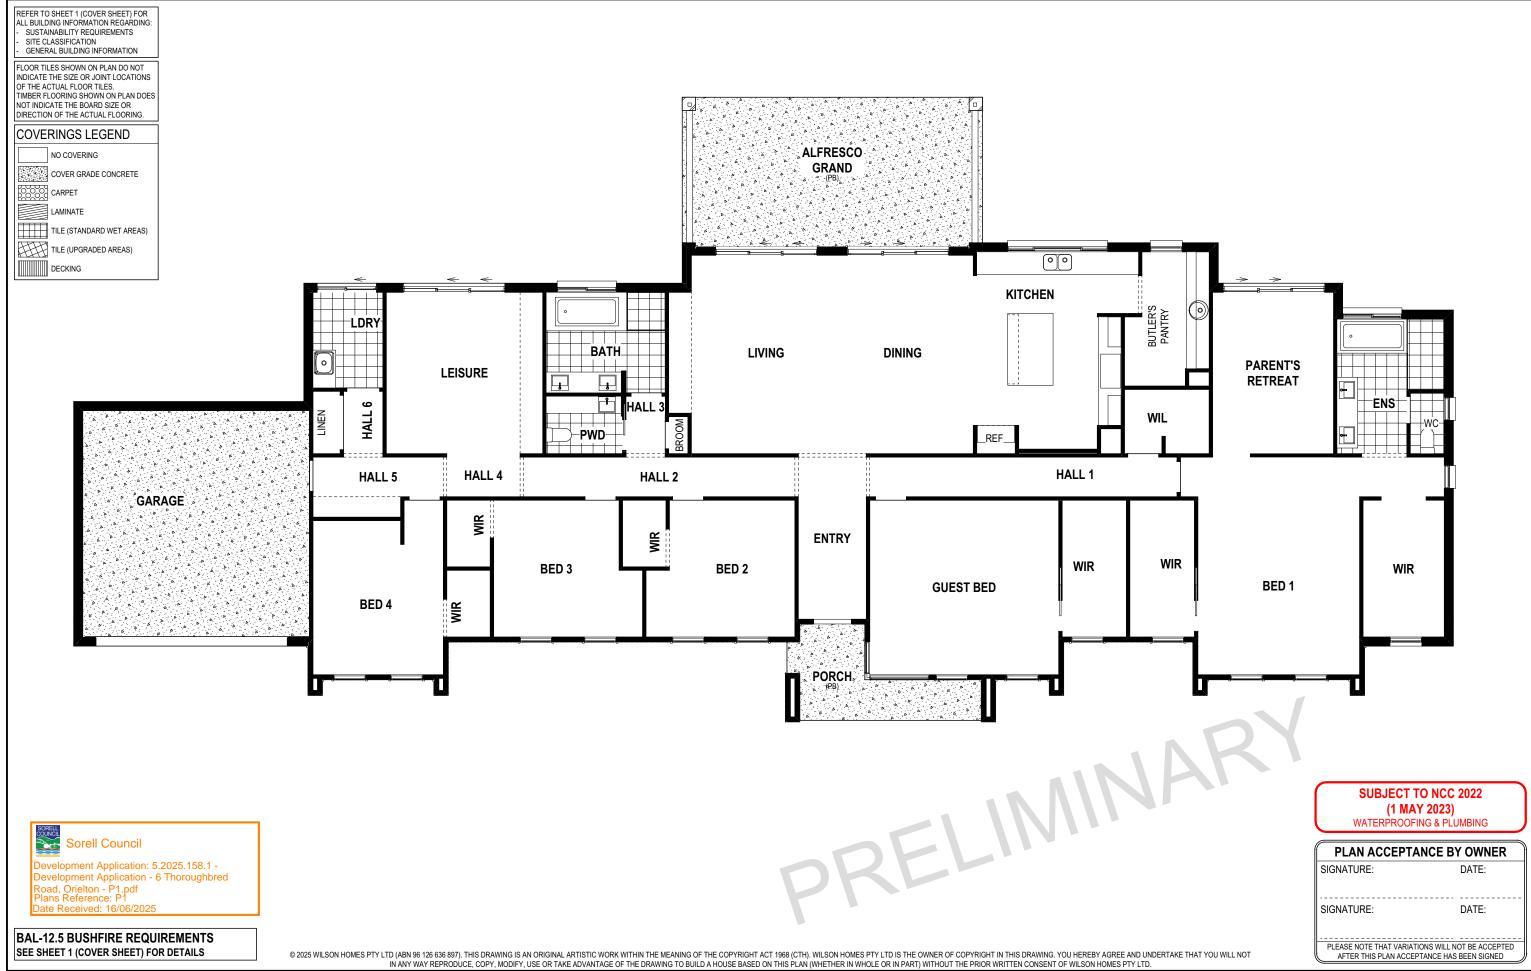SCALE: 1:50

REFER TO SHEET 1 (COVER SHEET) FOR ALL BUILDING INFORMATION REGARDING:

SUSTAINABILITY REQUIREMENTS
SITE CLASSIFICATION
GENERAL BUILDING INFORMATION


DETAILS DEPICTED ON THIS SHEET ARE A REPRESENTATION ONLY. JOINER MAY ADJUST CABINETRY AS REQUIRED.

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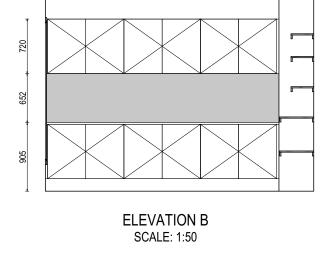
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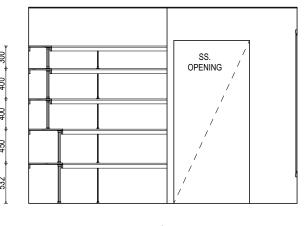
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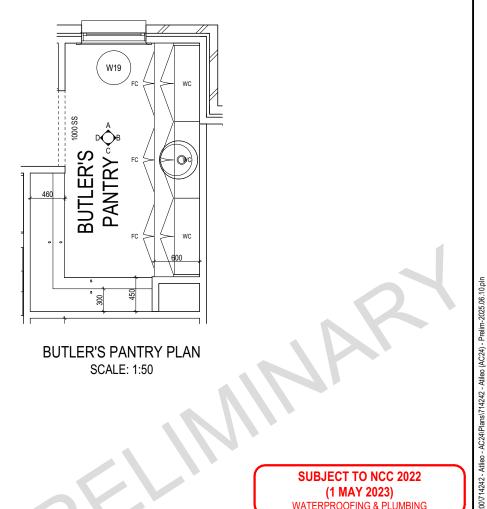
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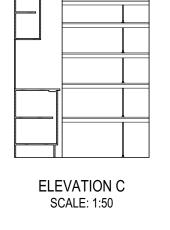


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WATERPROOFING & PLUMBING

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600 x 150 NOGGINGS CENTRED

TO BATH. OFFSET 175mm FROM— TOP OF BATH

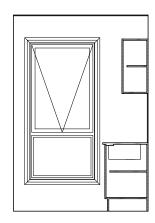evelopment Application: 5.2025.158.1 evelopment Application - 6 Thoroughbred Road, Orielton - P1.pdf Plans Reference: P1 Date Received: 16/06/202

REFER TO THE FOLLOWING DETAILS: VANITY DETAILS G-VANI-001 WINDOW OVER BATH HOB D-WIND-ALU001 STANDARD BATH HOB D-WETA-BATH003
WET AREA TILING LAYOUTS D-WETA-TILE002

SQUARE SET WINDOWS G-WIND-SSET02 FULL HEIGHT TILING D-LINI-WETA

REFER TO SHEET 1 (COVER SHEET) FOR ALL BUILDING INFORMATION REGARDING: SUSTAINABILITY REQUIREMENTS SITE CLASSIFICATION GENERAL BUILDING INFORMATION

LEGEND

DETAILS DEPICTED ON THIS SHEET ARE A REPRESENTATION ONLY



RH ROBE HOOK SHLF SHELF SR SHAMPOO RECESS SOAP SOAP HOLDER

THRESHOLD OF ACCESSIBLE SHOWER ENTRY TO BE MAX. 5MM, REFER TO BATHROOM W23 SF1216 1000 Doc BATH BATH

> **BATHROOM PLAN** SCALE: 1:50

	RECESS SIZE	SIKUCIUN	RAL DIMENSIONS
		WIDTH	HEIGHT
"SMALL"	470 x 380mm	548mm	446mm
"MEDIUM"	800 x 380mm	878mm	446mm
"LARGE"	1500 x 380mm	1578mm	446mm

SUBJECT TO NCC 2022 (1 MAY 2023)

WATERPROOFING & PLUMBING


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	IONS WILL NOT BE ACCEPTED

600 x 150 NOGGINGS . 800-810 HIGHT (CTR LINE).-CENTRED TO ROSE 7-7-MX

600 x 150 NOGGINGS . 800-810

—HIGHT (CTR LINE). OFFSET 250mm FROM WALL

ELEVATION B SCALE: 1:50

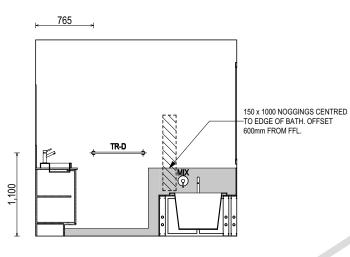

ELEVATION D SCALE: 1:50

ELEVATION C SCALE: 1:50

ELEVATION A

SCALE: 1:50

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SQUARE SET WINDOWS G-WIND-SSET02 FULL HEIGHT TILING D-LINI-WETA

REFER TO SHEET 1 (COVER SHEET) FOR ALL BUILDING INFORMATION REGARDING: SUSTAINABILITY REQUIREMENTS SITE CLASSIFICATION GENERAL BUILDING INFORMATION

LEGEND

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SHLF SHELF SR SHAMPOO RECESS SOAP SOAP HOLDER

DETAILS DEPICTED ON THIS SHEET ARE A

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CONNECTION MIX MIXER TAP HT

HOT TAP

COLD TAP HOB SPOUT


WALL SPOUT

STOP COCK


TOWEL HOLDER TR TOWEL RACK TMB TUMBLER HOLDER RNG TOWEL RING

ROBE HOOK


TOILET ROLL HOLDER TR-S TOWEL RAIL - SINGLE TR-D TOWEL RAIL - DOUBLE TL TOWEL LADDER

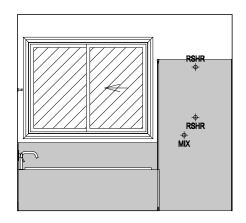

ELEVATION A SCALE: 1:50

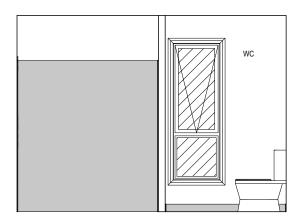

ELEVATION B SCALE: 1:50

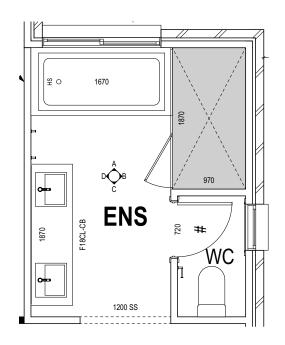


ENSUITE PLAN SCALE: 1:50


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evelopment Application: 5.2025.158.1 - evelopment Application - 6 Thoroughbred



ELEVATION C SCALE: 1:50

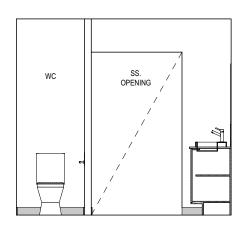

ELEVATION D SCALE: 1:50

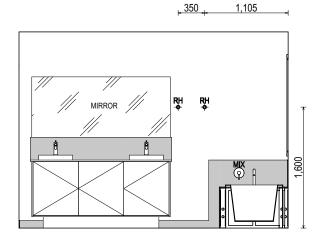

FURTHER DETAIL PRIOR TO INSTALLATION.

SUBJECT TO NCC 2022 (1 MAY 2023)

WATERPROOFING & PLUMBING

PLAN ACCEPTANCE BY OWNER							
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WINDOW OVER BATH HOB D-WIND-ALU001 STANDARD BATH HOB D-WETA-BATH003
WET AREA TILING LAYOUTS D-WETA-TILE002 SQUARE SET WINDOWS G-WIND-SSET02 FULL HEIGHT TILING D-LINI-WETA

REFER TO SHEET 1 (COVER SHEET) FOR ALL BUILDING INFORMATION REGARDING: SUSTAINABILITY REQUIREMENTS SITE CLASSIFICATION GENERAL BUILDING INFORMATION

DETAILS DEPICTED ON THIS SHEET ARE A



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evelopment Application: 5.2025.158.1 evelopment Application - 6 Thoroughbred Road, Orielton - P1.pdf Plans Reference: P1



ROSE SHOWER ROSE SHOWER ELBOW ELBW CONNECTION MIX MIXER TAP HT HOT TAP CT COLD TAP HS HOB SPOUT WS WALL SPOUT SC STOP COCK TRH TOILET ROLL HOLDER TR-S TOWEL RAIL - SINGLE TR-D TOWEL RAIL - DOUBLE TL TOWEL LADDER TH TOWEL HOLDER TR TOWEL RACK TMB TUMBLER HOLDER

RNG TOWEL RING


SHLF SHELF

ROBE HOOK


SR SHAMPOO RECESS SOAP SOAP HOLDER



ELEVATION A SCALE: 1:50

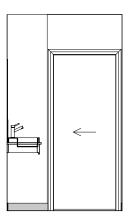

ELEVATION B SCALE: 1:50

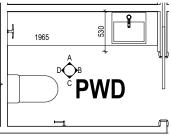

VDER ROOM PLAN SCALE: 1:50

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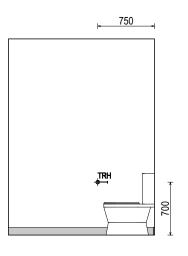
SHAMPOO	RECESS SIZE	STRUCTURAL	DIMENSIONS					
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'SMALL"	470 x 380mm	548mm	446mm					
'MEDIUM"	800 x 380mm	878mm	446mm					
'LARGE"	1500 x 380mm	1578mm	446mm					
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FURTHER DETAIL PRIOR TO INSTALLATION.


SUBJECT TO NCC 2022 (1 MAY 2023)

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PLAN ACCEPTANCE BY OWNER							
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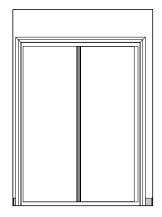
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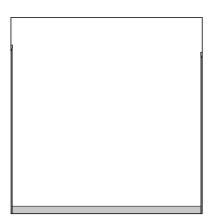
Development Application: 5.2025.158.1 Development Application - 6 Thoroughbred
Road, Orielton - P1.pdf
Plans Reference: P1
Date Received: 16/06/2025

REFER TO SHEET 1 (COVER SHEET) FOR ALL BUILDING INFORMATION REGARDING: - SUSTAINABILITY REQUIREMENTS - SITE CLASSIFICATION - GENERAL BUILDING INFORMATION


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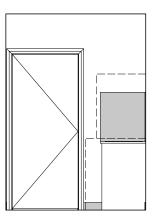
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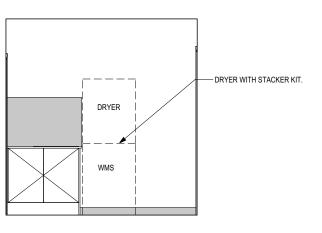
ELEVATION B SCALE: 1:50

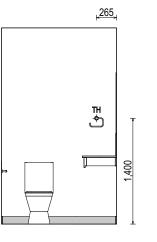

LAUNDRY PLAN SCALE: 1:50



ELEVATION C SCALE: 1:50

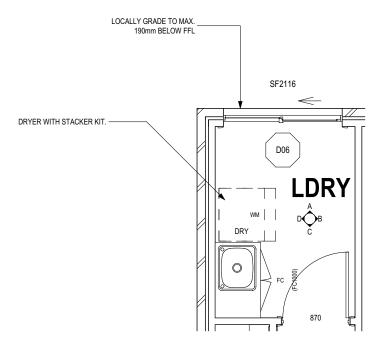

ELEVATION D SCALE: 1:50

SUBJECT TO NCC 2022 (1 MAY 2023) WATERPROOFING & PLUMBING

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	IONS WILL NOT BE ACCEPTED	
AFTER THIS PLAN ACCEP	PTANCE HAS BEEN SIGNED	,

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