

# NOTICE OF PROPOSED DEVELOPMENT

Notice is hereby given that an application has been made for planning approval for the following development:

# SITE: 9 Miena Drive, Sorell

# PROPOSED DEVELOPMENT: THREE MULTIPLE DWELLINGS

The relevant plans and documents can be inspected at the Council Offices at 47 Cole Street, Sorell during normal office hours, or the plans may be viewed on Council's website at <u>www.sorell.tas.gov.au</u> until **Monday 7<sup>th</sup> July 2025.** 

Any person may make representation in relation to the proposal by letter or electronic mail (<u>sorell.council@sorell.tas.gov.au</u>) addressed to the General Manager. Representations must be received no later than **Monday 7<sup>th</sup> July 2025**.

APPLICANT: CONSTRUCT CREATIVE

APPLICATION NO: DA 2024 / 00325 1 DATE: 19 June 2025

## Part B: Please note that Part B of this form is publicly exhibited.

Full description of Proposal:	<sup>Use:</sup> Dwellings x 3	
	Development: Construction of three dwellings	
	Large or complex proposals should be described in a letter or planning report.	
Design and const	truction cost of proposal: \$ 1,056,000.00	

Is all, or some the work already constructed:

No: 🗹 Yes: 🗖

Location of	Street address: 9 Miena Drive	
		82322 Folio: 20

Current Use of	Vacant Land
Site	

Current	Miena Park Pty Ltd
Owner/s:	Name(s)

Is the Property on the Tasmanian Heritage Register?	No: 🗹	Yes: 🗖	lf yes, please provide written advice from Heritage Tasmania	
Is the proposal to be carried out in more than one stage?	No: 🗹	Yes: 🗖	If yes, please clearly describe in plans	
Have any potentially contaminating uses been undertaken on the site?	No: 🗹	Yes: 🗖	If yes, please complete the Additional Information for Non-Residential Use	
Is any vegetation proposed to be removed?	No: 🗹	Yes: 🗖	If yes, please ensure plans clearly show area to be impacted	
Does the proposal involve land administered or owned by either the Crown or Council?	No: 🗹	Yes: 🗖	If yes, please complete the Council or Crown land section on page 3	
If a new or upgraded vehicular crossing is requi				
complete the Vehicular Crossing (and Associated Works) application form				
https://www.sorell.tas.gov.au/services/engir	ieering/			
			Development Application: 5.2024.325.1 - Development Application - 9 Miena Drive, Sorell - P1.pdf Plans Reference:P1 Date Received: 2/12/2024	

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(Scan with Folio Plan of the Plan below)

# **NOTICE TO SEARCHERS**

## **AMENDMENT No. E311342**

## AFFECTING

## SEALED PLAN No:- 109062

## THE ABOVE AMENDMENT HAS BEEN LODGED WITH THE RECORDER OF TITLES

## 25 July 2022

Robert Manning Recorder of Titles

NOTE: This notice should be removed once the amendment has been registered and the amended sheet/s have been scanned with the plan



Development Application: 5.2024.325.1 -Development Application - 9 Miena Drive, Sorell -P1.pdf Plans Reference:P1

Date Received: 2/12/2024

Search Date: 02 Dec 2024 Search Time: 10:08 AM

Department of Natural Resources and Environment Tasmania

Volume Number: 182322

Revision Number: 02

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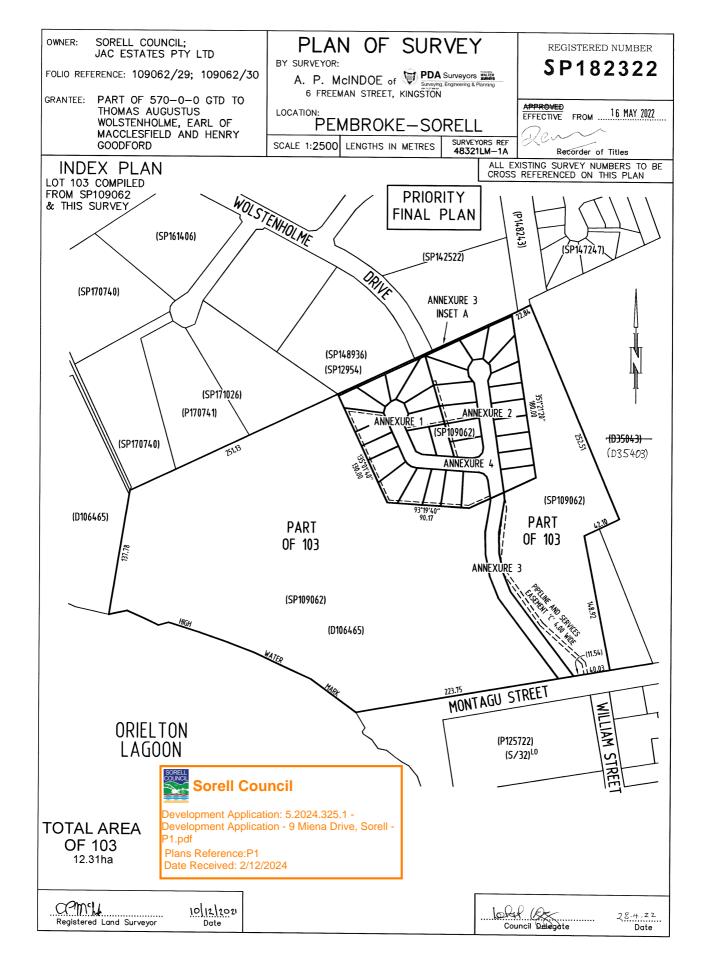
FOLIO PLAN

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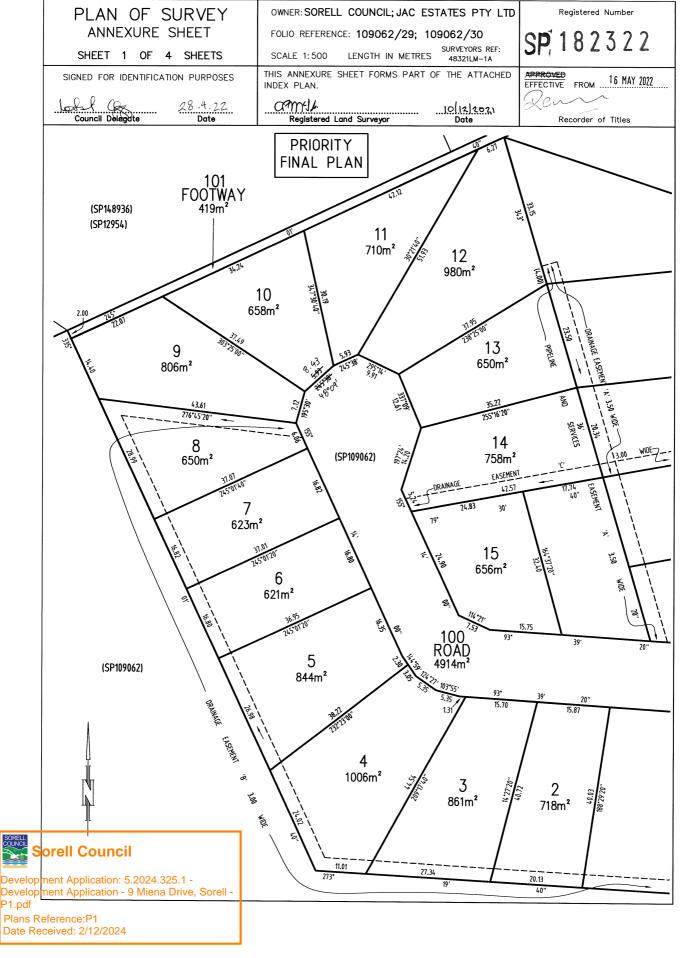


## FOLIO PLAN

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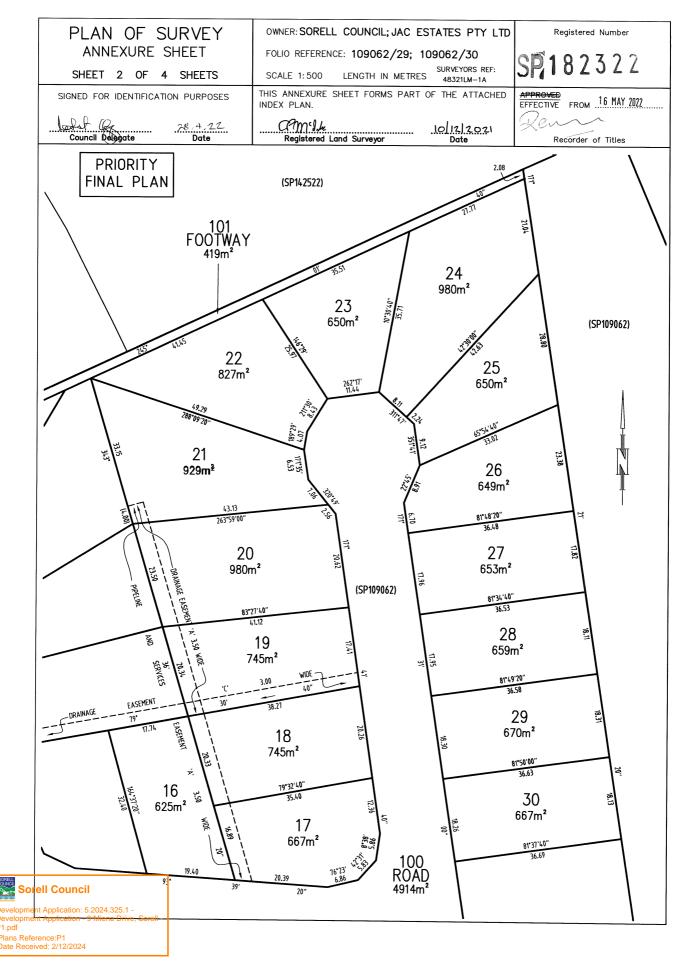


# FOLIO PLAN

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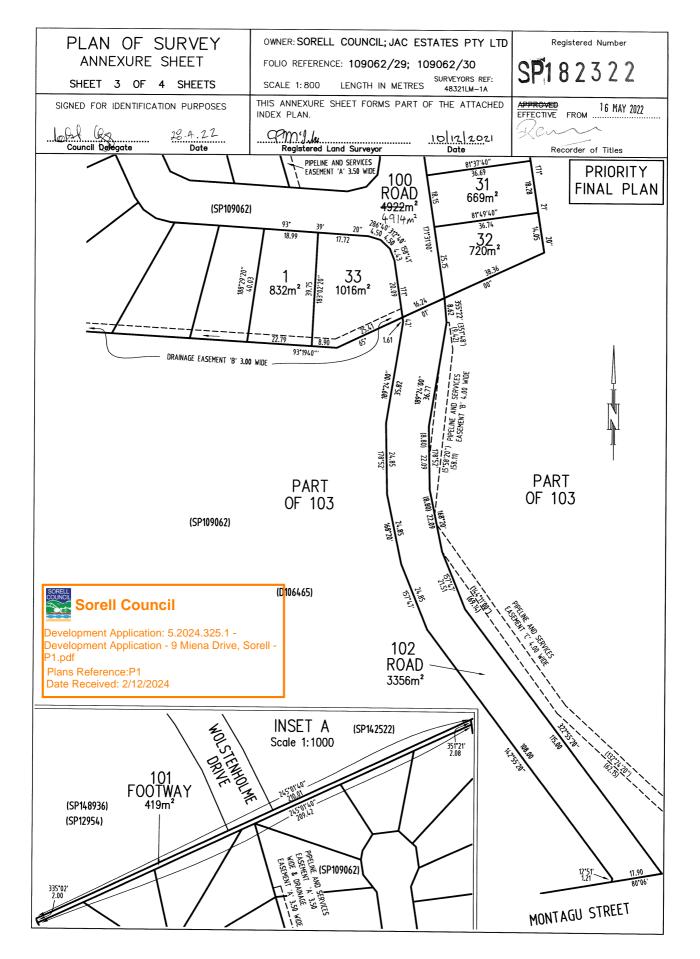




## FOLIO PLAN RECORDER OF TITLES

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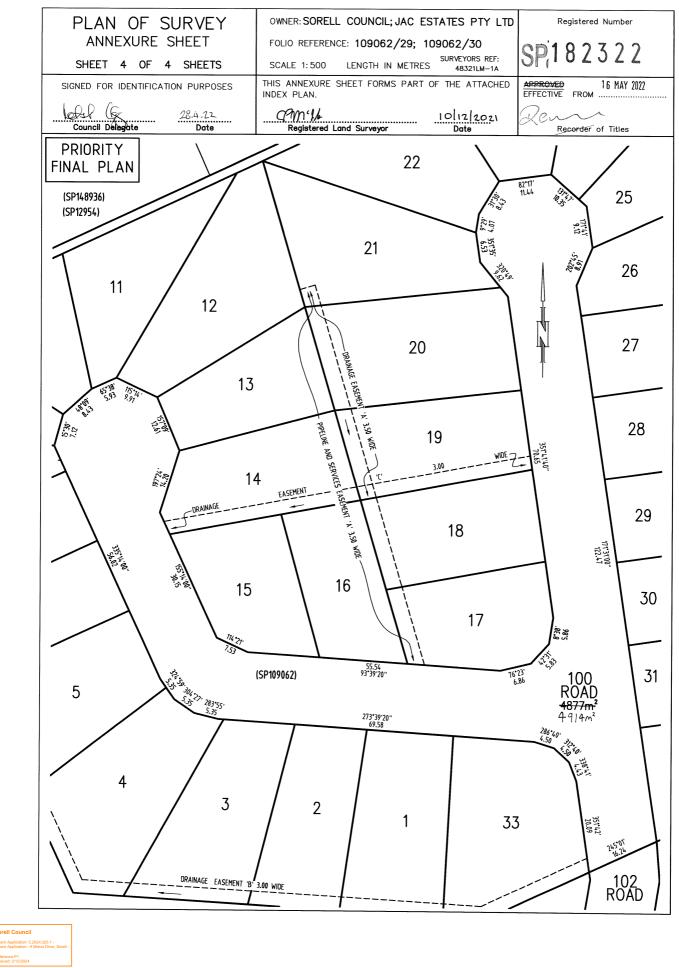




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SEARCH OF TORRENS TITLE

VOLUME	FOLIO
182322	20
EDITION	DATE OF ISSUE
3	26-Sep-2022

SEARCH DATE : 02-Dec-2024 SEARCH TIME : 10.08 AM

### DESCRIPTION OF LAND

Parish of SORELL Land District of PEMBROKE Lot 20 on Sealed Plan 182322 Derivation : Part of 570 Acres Gtd. to Thomas Augustus Wolstenholme, Earl of Macclesfield and Henry Goodford Prior CT 109062/30

#### SCHEDULE 1

M986096 TRANSFER to MIENA PARK PTY LTD Registered 26-Sep-2022 at noon

#### SCHEDULE 2

Reservations and conditions in the Crown Grant if any SP182322 EASEMENTS in Schedule of Easements SP182322 COVENANTS in Schedule of Easements SP182322 FENCING PROVISION in Schedule of Easements SP109062 COVENANTS in Schedule of Easements SP109062 FENCING COVENANT in Schedule of Easements SP109062 SEWERAGE AND/OR DRAINAGE RESTRICTION E315464 INSTRUMENT Creating Restrictive Covenants Registered 26-Sep-2022 at 12.01 PM

### UNREGISTERED DEALINGS AND NOTATIONS

NOTICE: This folio is affected as to amended covenants pursuant to Request to Amend No. E311342 made under Section 103 of the Local Government (Building and Miscellaneous Provisions) Act 1993. Search Sealed Plan No. 109062 Lodged by BUTLER MCINTYRE & B on 25-Jul-2022 BP: E311342





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## SCHEDULE OF EASEMENTS

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### SCHEDULE OF EASEMENTS

NOTE: THE SCHEDULE MUST BE SIGNED BY THE OWNERS & MORTGAGEES OF THE LAND AFFECTED. SIGNATURES MUST BE ATTESTED.

PAGE 1 OF 5 PAGES

**Registered Number** 

SP, 182322

#### EASEMENTS AND PROFITS

Each lot on the plan is together with:-

such rights of drainage over the drainage easements shown on the plan (if any) as may be necessary to drain (1)the stormwater and other surplus water from such lot; and

(2) any easements or profits a prendre described hereunder.

Each lot on the plan is subject to:-

(1) such rights of drainage over the drainage easements shown on the plan (if any) as passing through such lot as may be necessary to drain the stormwater and other surplus water from any other lot on the plan; and

(2) any easements or profits a prendre described hereunder.

The direction of the flow of water through the drainage easements shown on the plan is indicated by arrows.

#### EASEMENTS

Lot 103 is subject to a Pipeline & Services Easement in gross in favour of the Tasmanian Water and Sewerage Corporation Pty Ltd, its successors and assigns ("TasWater") over the land marked "PIPELINE AND SERVICES EASEMENT 'B' 4.00 WIDE" as shown on the plan ("the Easement Land").

Lot 103 is subject to a Pipeline & Services Easement in gross in favour of the Tasmanian Water and Sewerage Corporation Pty Ltd, its successors and assigns ("TasWater") over the land marked "PIPELINE AND SERVICES EASEMENT 'C' 4.00 WIDE" as shown on the plan ("the Easement Land").

Lots 17-21 (inclusive) is subject to a Pipeline & Services Easement in gross in favour of the Tasmanian Water and Sewerage Corporation Pty Ltd, its successors and assigns ("TasWater") over the land marked "PIPELINE AND SERVICES EASEMENT 'A' 3.50 WIDE" as shown on the plan ("the Easement Land").

Lots 1 to 8 & 33 (inclusive) are subject to a Right of Drainage in gross in favour of the Sorell Council over the land marked "DRAINAGE EASEMENT 'B' 3.00 WIDE" as shown on the plan.

Lots 14 & 19 are subject to a Right of Drainage in gross in favour of the Sorell Council over the land marked "DRAINAGE EASEMENT 'C' 3.00 WIDE" as shown on the plan.

Lots 19-21 (inclusive) are subject to a Right of Drainage in gross in favour of the Sorell Council over the land marked "DRAINAGE EASEMENT 'A' 3.50 WIDE" as shown on the plan.

Director - JAC Estates Pty Ltd

Director - JAC Estates Pty Ltd

(USE ANNEXURE PAGES FOR CONTINUATION)

SUBDIVIDER: SORELL COUNCIL & JAC ESTATES PTY LTD

FOLIO REF: 109062/29 & 109062/30

SOLICITOR & REFERENCE: Butler McIntyre & Butler (Jason Samec)

DATE: 28.4.22 SA 2016/00011

REF NO. NOTE: The Council Delegate must sign the Certificate for the purposes of identification.

PLAN SEALED BY: SORELL COUNCIL

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## **ANNEXURE TO** SCHEDULE OF EASEMENTS

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SP,182322

**Registered Number** 

SUBDIVIDER: SORELL COUNCIL & JAC ESTATES PTY LTD FOLIO REFERENCE: 109062/29 & 109062/30

### **Definitions:**

The Pipeline and Services Easement is defined as follows:-

FIRSTLY, THE FULL AND FREE RIGHT AND LIBERTY for TasWater and its employees, contractors, agents and all other persons duly authorised by it, at all times to:

- enter and remain upon the Easement Land with or without machinery, vehicles, plant and (1) equipment;
- (2) investigate, take soil, rock and other samples, survey, open and break up and excavate the Easement Land for any purpose or activity that TasWater is authorised to do or undertake;
- (3) install, retain, operate, modify, relocate, maintain, inspect, cleanse, repair, remove and replace the Infrastructure;
- (4) run and pass sewage, water and electricity through and along the Infrastructure;
- (5) do all works reasonably required in connection with such activities or as may be authorised or required by any law:
  - (a) without doing unnecessary damage to the Easement Land; and
  - (b) leaving the Easement Land in a clean and tidy condition;
- (6)if the Easement Land is not directly accessible from a highway, then for the purpose of undertaking any of the preceding activities TasWater may with or without employees, contractors, agents and any other persons authorised by it, and with or without machinery, vehicles, plant and equipment enter the Lot from the highway at any vehicle entry and cross the Lot to the Easement Land; and
- (7) use the Easement Land as a right of carriageway for the purpose of undertaking any of the preceding purposes on other land, TasWater reinstating any damage that it causes in doing so to any boundary fence of the Lot.

SECONDLY, the benefit of a covenant in gross for TasWater with the registered proprietor/s of the Easement Land and their successors and assigns not to erect any building, or place any structures, objects, vegetation, or remove any thing that supports, protects or covers any Infrastructure on or in the Easement Land, without the prior written consent of TasWater to the intent that the burden of the covenant may run with and bind the servient land and every part thereof and that the benefit

thereof may be annexed to the easement herein described. Meth MG

Director - JAC Estates Pty Ltd

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NOTE: Every annexed page must be signed by the parties to the dealing or where the party is a corporate body be signed by the persons who have attested the affixing of the seal of that body to the dealing.

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## ANNEXURE TO SCHEDULE OF EASEMENTS

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**Registered Number** 

SUBDIVIDER: SORELL COUNCIL & JAC ESTATES PTY LTD FOLIO REFERENCE: 109062/29 & 109062/30

Interpretation:

"Infrastructure" means infrastructure owned or for which TasWater is responsible and includes but is not limited to:

- (a) sewer pipes and water pipes and associated valves;
- (b) telemetry and monitoring devices;
- (c) inspection and access pits;
- (d) electricity assets and other conducting media (excluding telemetry and monitoring devices);
- (e) markers or signs indicating the location of the Easement Land or any other Infrastructure or any warnings or restrictions with respect to the Easement Land or any other Infrastructure;
- (f) anything reasonably required to support, protect or cover any other Infrastructure;
- (g) any other infrastructure whether of a similar nature or not to the preceding which is reasonably required for the piping of sewage or water, or the running of electricity, through the Easement Land or monitoring or managing that activity; and
- (h) where the context permits, any part of the Infrastructure.

"TasWater" means Tasmanian Water & Sewerage Corporation Pty Ltd (ACN 162 220 653), its successors and assigns.

"Owner" means the registered proprietors of the Lot from time to time.

"Right of Drainage" means a right of drainage as defined within Schedule 8 of the Conveyancing and Law of Property Act 1884 (Tas).

"Right of Carriageway" means a right of carriage way as defined within Schedule 8 of the Conveyancing and Law of Property Act 1884 (Tas).

Director - JAC Estates Pty Ltd

Director - JAC Estates Pty Ltd



Development Application: 5.2024.325.1 -Development Application - 9 Miena Drive, Sorell -21.pdf Plans Reference:P1 Date Received: 2/12/2024

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## **ANNEXURE TO** SCHEDULE OF EASEMENTS

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SUBDIVIDER: SORELL COUNCIL & JAC ESTATES PTY LTD FOLIO REFERENCE: 109062/29 & 109062/30

### **COVENANTS**

Lots on the Plan are subject to the covenants in SP 109062.


The owners of lots 1-33 (inclusive) on the Plan covenants with the Sorell Council to the intent that the burden of these covenants may run with and bind the covenantor's lot and each and every part of it and that the benefit of these covenants shall be annexed to and devolve with Sorell Council to observe the following stipulation that: NOT TO CONSTRUCT & NEW DWELLING WITHOUT W ITHOUT

- a 5000 litre (minimum) water tank is to be fitted to all new dwollings to collect all roof runoff; and tanks will be installed with a minimum retention storage of 1000 litres and be plumbed into toilets so \_
- that re-use of the tank water occurs with top up from reticulated water supply,

#### FENCING PROVISION

In respect to the lots on the plan the vendor (SORELL COUNCIL AND JAC ESTATES PTY LTD) shall not be required to fence.

In witness whereof the common seal of SORELL COUNCIL has been affixed, pursuant to a resolution of the Council of the said municipality passed the Z8 day of KPRIL 2027, in the presence of us:

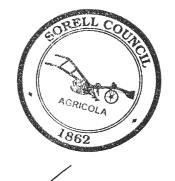

Member: .....

**Registered Number** 

SP182322

Member: .....

Council Delegate: ....

Sorell Council t Application: 5.2024.325.1 -t Application - 9 Miena Drive, Sorell

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Pole la Director - JAC Estates fty Ltd

JAC Estates fly Ltd

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**Registered Number** 

SP182322

## ANNEXURE TO SCHEDULE OF EASEMENTS

PAGE 5 OF 5 PAGES

SUBDIVIDER: SORELL COUNCIL & JAC ESTATES PTY LTD FOLIO REFERENCE: 109062/29 & 109062/30

**EXECUTED** by **JAC ESTATES PTY LTD (ACN 638 495 182)** pursuant to section 127 of the Corporations Act 2001 by:

NN/IN

<u>UOM</u> Director/ Secretary

Director Signature Signature

PETR KR12

Director Full Name (print) Name (print)

DEAN MURRAY COCKER Director/ Secretary Full





Development Application: 5.2024.325.1 -Development Application - 9 Miena Drive, Sorell -P1.pdf Plans Reference:P1 Date Received: 2/12/2024

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# SITE AND SOIL EVALUATION REPORT FOUNDATION AND WINDLOADING ASSESSMENT

## Lot 20 Milena Drive

Sorell

Sorell Council Development Application: 5.2024.325.1 -Development Application - 9 Miena Drive, Sorell -P1.pdf Plans Reference:P1 Date Received: 2/12/2024

July 2022

Doyle Soil Consulting: 150 Nelson Rd Mt Nelson 7007 – 0488 080 455 – robyn@doylesoilconsulting.com.au

## SITE INFORMATION

**Client:** Creative Homes Hobart

Address: Lot 20 Milena Drive, Sorell (CT 182322/20)

Site Area: Approximately 980 m<sup>2</sup>

Date of inspection: 22/07/2022

Building type: New house

Services: Mains water and sewer

Planning Overlays: Bushfire prone area

Mapped Geology - Mineral Resources Tasmania 1:250 000 Southeast Tasmania sheet: Qh = Quaternary alluvial sand, gravel, and mud.

Soil Depth: >2.0 m (core) to >3.3 m (DCP)

Subsoil Drainage: Moderately-well drained

Drainage lines / water courses: None

Vegetation: Grass

Rainfall in previous 7 days: Approximately 4 mm

## Site Assessment and Sample Testing

Site investigation and soil classification in accordance with AS 2870-2011 *Residential slabs and footings* and in accordance with AS 4055-2021 *Wind load for Housing.* 

Two drill cores with no refusal @ 2.0 m at TH1 and at TH2.

Dynamic Cone Penetrometer (DCP) test between TH1 and TH2 with no refusal @ 3.3 m.

Emerson Dispersion test on subsoils and linear shrinkage tests on all likely founding layers.

Test holes were dug using a Christie Post Driver Soil Sampling Kit, comprising CHPD78 Christie Post Driver with Soil Sampling Tube (50 mm OD x 1600/2100 mm).

TH1 Depth (m)	TH2 Depth (m)	Horizon	Description and field texture grade	Soil Classifn.
0.0 - 0.5	0.0 - 0.7	FILL	Mostly local clay fill with rubble	N/A
0.5 – 1.5	0.7 – 1.5	B2	Black (10YR 2/1), <b>Medium Clay</b> , massive (angular blocky in top $0.5 - 0.6$ m), slightly moist stiff consistency.	СН
Note: Both cores were drilled to 2.0 m but lower section of the soil was lost on retrieval				

SOIL PROFILES – Test Hole 1 & 2



## SITE AND SOIL COMMENTS

The natural soil profiles are formed from deep reactive clays derived from alluvial fan deposits. The profiles are deep with no refusal occurring with the DCP at approximately 3.3 m. The field textures of the soil profile are dominated by clay, which is highly reactive, weakly to poorly structured with low bearing capacity to at least 0.9 m.

## LINEAR SHRINKAGE AND SOIL REACTIVITY

Samples of the clayey subsoils were tested for reactivity using the linear shrinkage test. Linear shrinkage provides an approximate guide to aid soil classification of reactivity of clays for foundations. The tests suggest the clays are highly reactive.

Sample	Depth (m)	Length of mould (L)	Longitudinal Shrinkage (LS) in mm	LS (%)	Soil Class
TH 1	0.7 – 1.5	125	22.0	17.6	H — 1

## DCP TESTS AND ESTIMATED BEARING CAPACITY

Dynamic Cone Penetrometer (DCP) testing is a method of estimating likely soil bearing capacity. However, surface layers (approx. upper 0.7 m) are subject to significant soil moisture variations with the season, affecting DCP values, especially in clays, e.g. in summer or drought. Dry clays may be very stiff – hard but only soft – firm in winter. Thus, DCP values below approximately 0.7 m are likely to be more typical of year–to–year soil bearing conditions in clayey and silty soils. We provide estimated soil bearing strengths along with a variance range (+/-) based on a review of published literature relating field DCP readings to triaxial soil strength tests.

A minimum bearing capacity of 100 kPa is required for strip and pad footings and under the edge footings and associated slab foundations. The Dynamic Cone Penetrometer (DCP) test was carried out between TH1 and TH2. The subsoils were slightly moist when tested and so the field DCP values are likely to be higher than in very moist to saturated soil conditions (winter/spring).

The field DCP1 data indicates that the bearing capacity of the soil is at a suitable strength below approx. 0.9 m. However, we recommend founding in the firmer clays at and below approx. 1.3 m.

The clay horizons are highly reactive/plastic and thus require foundation design suitable for high shrinking and swelling induced movement (refer to tables below and AS2870-2011 clause 2.4.5).

DCP 1				
Depth (mm)	DCP n-number (Blows/100 mm)	DCP Penetration Index (mm/Blow)	Estimated bearing capabity (kPa = n x 30)	(+/-)
0 - 100	2	50.0	60	20
100 - 200	1	100.0	30	10
200 - 300	3	33.3	90	30
300 - 400	3	33.3	90	30
400 - 500	2	50.0	60	20
500 - 600	2	50.0	60	20
600 - 700	3	33.3	90	30
700 - 800	3	33.3	90	30
800 - 900	5	20.0	150	50
900 - 1000	6	16.7	180	60
1000 - 1100	6	16.7	180	60
1100 - 1200	7	14.3	210	70
1200 - 1300	8	12.5	240	80
1300 - 1400	10	10.0	300	100
1400 - 1500	11	9.1	330	110
1500 - 1600	10	10.0	300	100
1600 - 1700	10	10.0	300	100
1700 - 1800	13	7.7	390	130
1800 - 1900	12	8.3	360	120
1900 - 2000	10	10.0	300	100
2000 - 2100	10	10.0	300	100
2100 - 2200	10	10.0	300	100
2200 - 2300	10	10.0	300	100
2300 - 2400	12	8.3	360	120
2400 - 2500	11	9.1	330	110
2500 - 2600	10	10.0	300	100
2600 - 2700	11	9.1	330	110
2700 - 2800	12	8.3	360	120
2800 - 2900	13	7.7	390	130
2900 - 3000	14	7.1	420	140
3000 - 3100	20	5.0	600	200
3100 - 3200	26	3.8	780	260
3200 - 3300	26	3.8	780	260

## EMERSON AGGREGATE DISPERSION TEST

Soils with an excess of exchangeable sodium ions on the cation exchange complex (clays), can cause clay dispersion. Under some circumstances the presence of dispersive soils can also lead to significant erosion, and in particular tunnels leading to eventual gully erosion. Based upon field survey of the property and the surrounding area, no erosion was identified at the site.

The subsoil was tested for dispersion using the Emerson Aggregate Test (EAT). Photos are available on request. The class 2(2) indicates a mild dispersive characteristic. The subsoils are therefore mildly spontaneously dispersive and so exposure to rainfall may lead to minor clay dispersion and potentially rill and tunnel erosion, although this is more common in sandy lighter clays, sandy clay loams and silt loams. Dispersive clay subsoil materials can also cause sealing of the soil surface – if left out in wet weather, they then dry and set very hard in dry weather. To minimise this, we recommend coverage of exposed subsoil with topsoil or regular treatment with gypsum at 0.5 Kg/m<sup>2</sup> along with minimising subsoil disturbance whenever possible. Photo available on request.

Sample	Depth (m)	Visual sign	Class
TH 1	0.7 – 1.5	Some dispersion (obvious milkiness < 50% of aggregate affected)	2(2)

## WIND CLASSIFICATION

The AS 4055-2021 Wind load for Housing classification of the site is:

Region:	Α
Terrain Category:	тсз
Shielding Classification:	NS
Topographic Classification:	Т2
Wind Classification:	N2
Design Wind Gust Speed (V <sub>h,u</sub> ):	40 m/sec

## SITE CLASSIFICATION AND RECOMMENDATIONS

According to AS2870-2011 (construction) the site is classified as **Class P** due to the presence of soft/low bearing materials to depths of approximately 0.9 m. Founding is recommended at below 1.3 m in the higher bearing capacity materials below this depth.

**Note 1** – The subsoil clay rich layers, in addition to being of low and variable bearing capacity (hence **Class P**), also meet the reactivity levels of **Class H-2** or highly reactive, with 60 – 75 mm the dominant reactivity of expected surface movement under normal soil moisture ranges for the location.

**Note 2** – All foundations require ongoing adequate drainage and vegetation management – please refer to CSIRO foundation management BTF 18 sheet attached.

**Note 3** – If any foundations are <u>placed</u> on FILL that is > 0.5 m in depth then **Class P** is applicable.

## General Notes - Important points pertinent to maintenance of foundation soil conditions

This report relates to the soil and site conditions on the property at the time of the site assessment. The satisfactory long-term performance of footings is dependent upon the ongoing site maintenance by the owner.

Examples of abnormal moisture conditions developing after construction include the following:

- A) The effect of trees too close to the footings
- B) Excessive or irregular watering of gardens adjacent to the footings
- C) Failure to maintain site drainage affecting footings
- D) Failure to repair plumbing leaks affecting footings
- E) Loss of vegetation from near the building.

All earthworks on site must comply with AS3798-2007 Guidelines on Earthworks for commercial and residential developments.

## **REPORT LIMITATIONS**

Whilst every attempt is made to describe sub-surface conditions, natural variation will occur that cannot be determined by limited investigative soil testing. Therefore, discrepancies are possible between test results and observations during construction. It is our intention to accurately indicate the most probable soil type(s) and conditions for the area assessed. However due to the nature of sampling an area, variations in soil type, soil depth and site conditions may occur.

We accept no responsibility for any differences between what we have reported and actual site and soil conditions for the particular regions we could not directly assess at the time of inspection.

It is recommended that during construction, Doyle Soil Consulting and/or the design engineer be notified of any major variation to the foundation conditions as predicted in this report. Any changes to the site through excavations may alter the site classification. In these cases, it is expected the owner consult the author for a reclassification. This report requires certification via a form 55 certificate from Doyle Soil Consulting to validate its contents.

Because site discrepancies may occur between this report and actual site conditions, it is a condition of certification of this report that the builder be provided with a copy of this report.

Evan Langridge B.Agr.Sc.(Hons). Soil Scientist





Dr Richard Doyle B.Sc.(Hons), M.Sc.(Geol), Ph.D. (Soil Sci.), CPSS (Certified Prof Soil Scientist)

**Geologist and Soil Scientist** 

APPENDIX 1 – Approximate test hole locations





## APPENDIX 2 – Definitions of Soil Horizons

Horizon name	Meaning	
A1	Dark topsoils, zone of maximum organic activity	
A2 or E	Leached, light/pale washed-out sandy layer	
A3 or AB	Transition from A to B, more like A	
B1 or BA	Transition from A to B, more like B	
	Main subsoils layer with brown coluration,	
B2	accumulations of clay, humus, iorn oxide, etc	
B3	Transitional from B2 to C	
С	Weakly weathered soil parent materials	

Subscript	Meaning
r	Reducing conditions (anaerobic)
t	Enriched in translocated clay
S	Iron/aluminium oxide accumulations
g	Mottled, suggesting periodic/seasonal wetness
m	Cemmented layer (oxides, cabonates, humus, silica etc)
k	Calcium carbonate (lime) accumulation
h	Humus accumulation a subsoil

## 5.2024.325.1 AT 9 Miena Drive, Sorell FOR - Construct Creative Pty Ltd

2. items a – p have been included on the drawings for the proposal.

3. all relevant items a – h have been included on the drawings.

4. Landscaping layout has been provided on the site plan and is to be read in conjunction with the landscaping schedule for the proposal. No large trees are proposed, and the easement area has been amended to only include low growing species and grasses.

5. The front fence detail has been noted on the site plan and an elevation provided alongside the front elevation for unit 2.

6. The current design is considered overdevelopment given:

• Site Coverage is significant, resulting in large hardstand coverage and limited appropriate landscaping (note large tree planting should not be confined to or be present within an easement area with vulnerable infrastructure that is likely to be damaged due to tree roots.

The hardstand at the front of the property has been reduced in size and a landscape feature has been added to minimise and break up the visual appearance of the concrete and make it appear less dominant. No large trees have been proposed – in accordance with the legend on the site plan – the "trees" are noted as screening plants, in addition to the other low growing species and grasses. This has been amended on the site plan for clarity and should also be read in conjunction with the landscaping schedule. The easement area has been amended to only include low growing species and grasses which will reduce the likelihood of roots impacting drainage infrastructure within the easement.

• Private Open Space (POS) is inadequate and inappropriately located. Specifically, Unit 2's proposed POS is unsatisfactorily located within the front setback, does not have a northern orientation, and requires an unacceptable solid front to provide any form of privacy.

All units meet the requirements for a minimum of  $24m^2$  of primary private open space (with min 4m dimension) and also a minimum of  $60m^2$  of total private open space in accordance with the planning scheme. The private open space for unit 2 is within the front setback which has a proposed screen fence and landscaping in order to provide privacy while also eliminating the need for a solid/high fence to achieve this. This is consistent with other unit developments in the area where the private open space is unable to be located behind the building line – such as the adjoining property at 10-12 Parkside Place, Sorell (below)



Development Application: 5.2024.325.1 -Response to Request For Information - 9 Miena Drive, Sorell - P2.pdf Plans Reference: P2 Date received: 13/06/2025



• The secluded private open space area for all dwellings is minimal and considered insufficient to meet the likely recreational needs of future occupants. Furthermore, the minimal dimensions limit the usability of this space and opportunities for canopy tree planting.

As previously mentioned – the private open space size and dimensions all exceed the minimum requirements of the planning scheme which indicates that the proposal will sufficiently meet the likely recreational needs of future occupants. The usability of this space for potential canopy tree planting is unfortunately constrained by the presence of the drainage easement across the length of the rear boundary which is a typical place for recreation and planting of trees, however larger trees could be planted in the space in front of unit 1 subject to services design and engineer's recommendations.

• The turning area for Dwelling appears tight, requiring a number of vehicle turning movements to enable vehicles to exit the site in a forward direction, therefore failing to meet the relevant design standards.

Dimensions for the driveway and turning areas have been added. Also 3 sheets of turning paths have been provided in order to demonstrate that there is sufficient turning space for vehicle access without excessive vehicle manoeuvres in accordance with AS2890.1.

• The location of the proposed car parking results in a significant hardstand area within the front setback, negatively fracturing the streetscape and providing poor amenity outcomes.

As previously mentioned, the hardstand at the front of the property has been reduced in size and a landscape feature has been added to minimise and break up the visual appearance of a large expanse of concrete.

7. The carparking has been amended to reduce the size of the driveway and also to include a landscaped division between the parking spaces in order to reduce the visual appearance of the concrete and make it appear less dominant. Unfortunately an alternative carparking arrangement is not possible without further detriment to the amenity of dwelling occupants. As previously mentioned, it can be demonstrated that the turning area is of sufficient size to allow vehicle entry and exit in accordance with AS2890.1 as shown on the additional pages of turning paths included on the drawings.

Sorell Council Development Application: 5.2024.325.1 -Response to Request For Information - 9 Miena Drive, Sorell - P2.pdf Plans Reference: P2 Date received: 13/08/2025 8. Swept path diagrams have been added to the drawings. As shown, it can be demonstrated that vehicles parked in all parking spaces are able to exit the site in a forwards direction.

9. Flood hazard report – provided by consultant – note that in accordance with the report, no changes to the floor levels are required as the whole subdivision has been raised above the flood level.

10. A stormwater drainage plan had been added to the drawings including provision for rainwater tanks as specified.

#### 

Development Application: 5.2024.325.1 -Response to Request For Information - 9 Miena Drive, Sorell - P2.pdf Plans Reference: P2 Date received: 13/06/2025



CREATIVE HOMES HOBART, CNR OF ELWICK ROAD & BROOKER HIGHWAY, GLENORCHY 7010 PH: 03 6272 3000

**PROJECT ADDRESS:** 9 MIENA DRIVE, SORELL

TITLE REFERENCE: VOLUME: 182322 FOLIO: 20

**CLIENTS:** MATTHEW CHAMBERLAIN

**DESIGNER:** Inge Brown, CC 6652

FLOOR AREAS: UNIT 1

DRAWINGS: 01 COVER PAGE 02 PROPOSED SITE PLAN 03 PROPOSED FLOOR PLAN UNIT 1 04 PROPOSED FLOOR PLAN UNIT 2 05 PROPOSED FLOOR PLAN UNIT 3 06 PROPOSED ROOF PLAN UNIT 1 07 PROPOSED ROOF PLAN UNIT 2 & 3 **08 PROPOSED ELEVATIONS UNIT 1** 09 PROPOSED ELEVATIONS UNIT 1 **10 PROPOSED ELEVATIONS UNIT 2** 11 PROPOSED ELEVATIONS UNIT 2 12 PROPOSED ELEVATIONS UNIT 3 **13 PROPOSED ELEVATIONS UNIT 3** 14 SECTION A-A **15 SECTION B-B** 16 SECTION C-C 17 SECTION D-D **18 TYPICAL SECTION DETAILS 19 WINDOW SCHEDULE UNIT 1** 20 WINDOW SCHEDULE UNIT 2 21 WINDOW SCHEDULE UNIT 3 22 TURNING PATHS 1 23 TURNING PATHS 2 24 TURNING PATHS 3 25 STORMWATER CONCEPT LAYOUT

FLOOR AREA:

TOTAL AREA:

GARAGE:



UNIT 2

GARAGE:

106.1 m<sup>2</sup> FLOOR AREA:

130.3 m<sup>2</sup> TOTAL AREA:

24.1 m<sup>2</sup> PORCH:

Development Application: 5.2024.325.1 -Response to Request For Information - 9 Miena Drive, Sorell - P2.pdf Plans Reference: P2 Date received: 13/06/2025

UNIT 3

102.7 m<sup>2</sup> FLOOR AREA:

1.0 m<sup>2</sup> PORCH:

23.7 m<sup>2</sup> GARAGE:

127.4 m<sup>2</sup> TOTAL AREA:

## **DOCUMENTATION INDEX**

102.7 m<sup>2</sup>

1.0 m<sup>2</sup>

23.7 m<sup>2</sup>

127.4 m<sup>2</sup>

The documentation listed below should be read in conjunction with these drawings and form the basis of construction documentation for the project

Document	I
Working drawings planning issue (these drawings)	E
Survey plan SP22314-01	/
Soil assessment	1

SOIL	. CLASS	IFICATIO

WIND CLASSIFICATION: N2

CLIMATE ZONE: 7


BUSHFIRE ATTACK LEVEL: N/A - NOT WITHIN OVERLAY

ALPINE AREA: N/A

Revision	Ву
В	Creative Homes Hobart
A	Survey Plus
14/7/2022	Doyle Soil Consulting

ON: P

CORROSION ENVIRONMENT: N/A

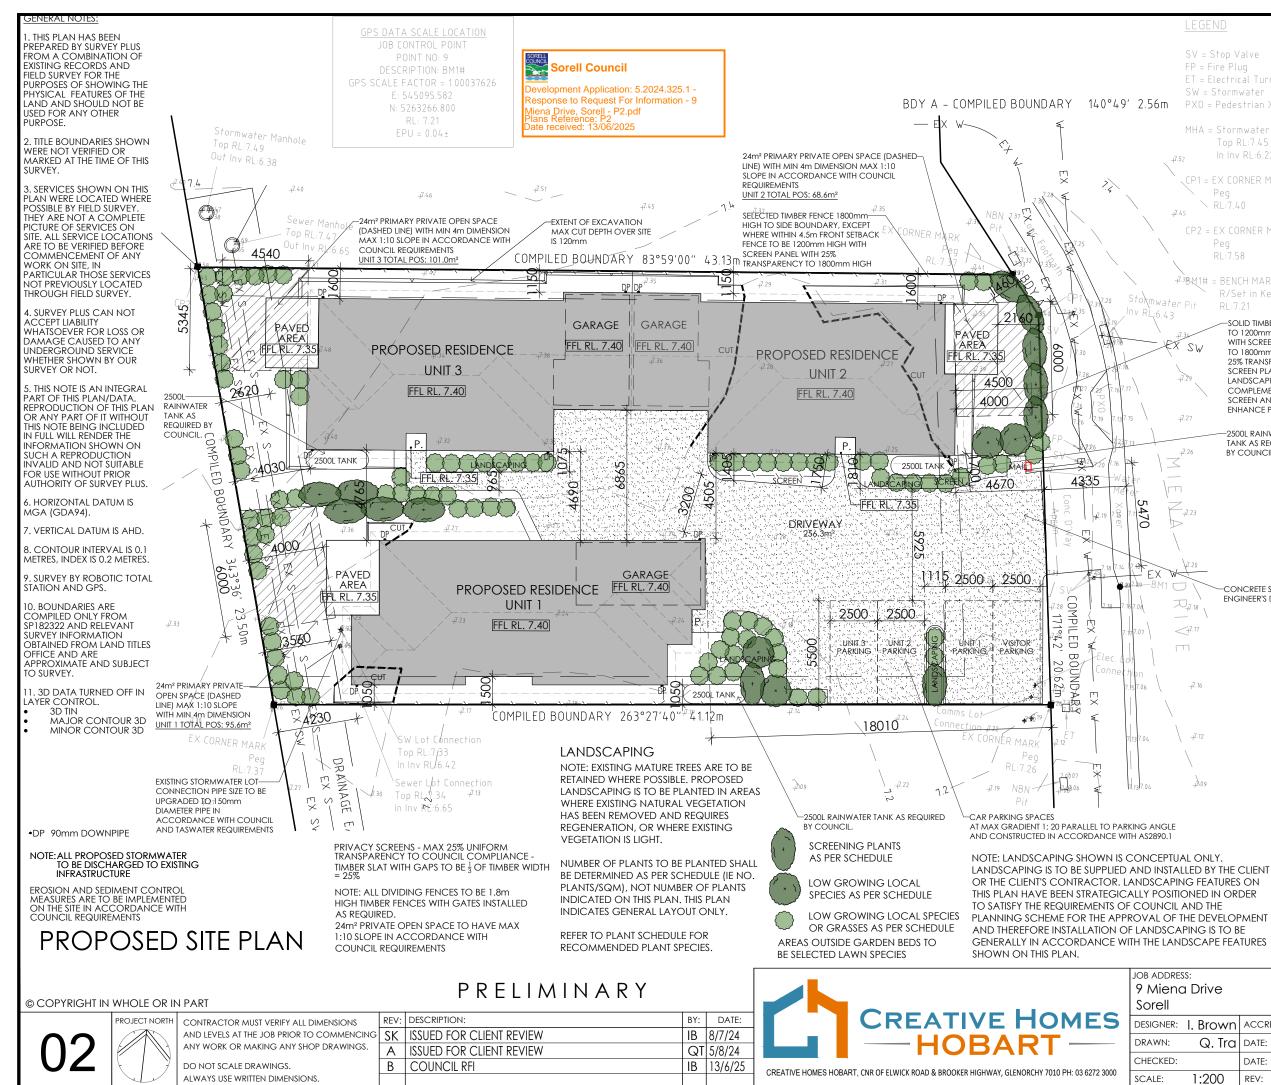

- SV = Stop Valve
- FP = Fire Plug
- ET = Electrical Turret
- SW = Stormwater
- PXO = Pedestrian Xover
- MHA = Stormwater Manhol
- RL:7.58
- R/Set in Kerb RI -7 21

SOLID TIMBER FENCE TO 1200mm HIGH WITH SCREEN PANEL TO 1800mm WITH 25% TRANSPARENCY. SCREEN PLANTING LANDSCAPING TO COMPLEMENT SCREEN AND ENHANCE PRIVACY 25001 RAINWATER

TANK AS REQUIRED BY COUNCIL.

CONCRETE SLAB TO ENGINEER'S DETAILS

SITE PREPARATION

THE SITE IS TO BE DISTURBED AS MINIMALLY AS POSSIBLE TO THE EXTENT REQUIRED TO CARRY OUT THE BUILDING WORKS. EARTHWORKS SHALL BE CARRIED OUT IN

ACCORDANCE WITH NCC PART 3.2 UN-RETAINED EMBANKMENT GRADIENTS SHALL BE IN ACCORDANCE WITH NCC TABLE 3.2. DRAINAGE SHALL BE IN ACCORDANCE WITH NCC PART 3.3.2

THE BUILDER AND SUBCONTRACTOR SHALL ENSURE THAT ALL STORMWATER DRAINS, SEWER PIPES AND THE LIKE ARE LOCATED AT A SUFFICIENT DISTANCE FROM ANY BUILDINGS FOOTING AND/OR SLAB EDGE BEAMS SO AS TO PREVENT GENERAL MOISTURE PENETRATION, DAMPNESS, WEAKENING & UNDERMINING OF ANY BUILDING AND IT'S FOOTING SYSTEM.

LOCATION OF ALL EXISTING SERVICES TO BE CONFIRMED ON SITE PRIOR TO CONSTRUCTION. ATTENTION OF OWNER

THE OWNERS ATTENTION IS DRAWN TO THE FACT THAT FOUNDATIONS AND ASSOCIATED DRAINAGE FOR ALL SITES REQUIRES CONTINUING MAINTENANCE TO ASSIST FOOTING PERFORMANCE. ADVICE FOR FOUNDATION MAINTENANCE IS CONTAINED IN THE CSIRO BUILDING TECHNOLOGY FILE 18 AND IT IS THE OWNERS RESPONSIBILITY TO MAINTAIN THE SITE IN ACCORDANCE WITH THIS DOCUMENT

SOIL AND WATER MANAGEMENT NOTES DRAINAGE LINES ARE TO BE INSTALLED PRIOR TO THE PLACEMENT OF ROOF AND GUTTERING. ONCE DWELLING IS ROOFED. CONNECT IMMEDIATELY APPLY TEMPORARY COVERING TO DISTURBED AREAS THAT WILL REMAIN EXPOSED FOR 14 DAYS OR MORE DURING CONSTRUCTION (EG. WATERPROOF BLANKET, VEGETATION OR MULCH)

PROTECT ANY NEARBY OR ON-SITE DRAINAGE PITS FROM SEDIMENT BY INSTALLING SEDIMENT TRAPS AROUND THEM

LIMIT ENTRY/EXIT TO ONE POINT AND STABILISE. INSTALL FACILITIES TO REMOVE DIRT/ MUD FROM VEHICLE WHEELS BEFORE THEY LEAVE THE SITE.

SITE TO BE VEGETATED AND PLANTED ACCORDING TO THE HOBART REGIONAL SOIL AND WATER MANAGEMENT CODE OF PRACTICE.

BUILDER AND SUBCONTRACTORS TO VERIFY ALL DIMENSIONS AND LEVELS PRIOR TO THE COMMENCEMENT OF ANY WORK GIVE 24 HOURS MINIMUM NOTICE WHERE AMENDMENTS ARE REQUIRED TO DRAWINGS. THESE DRAWINGS ARE TO BE READ IN CONJUNCTION WITH DOCUMENTATION LISTED ON THE COVER PAGE. DO NOT SCALE DRAWINGS

DIMENSIONS ARE TO TAKE PREFERENCE OVER SCALE. BUILDING SPECIFICATION AND ENGINEERS DRAWINGS SHALL OVERRIDE ARCHITECTURAL DRAWINGS

-THIS DRAWING IS TO BE READ IN CONJUNCTION WITH ALL OTHER DRAWING SHEETS, CONSULTANTS DRAWINGS, DOCUMENTS, SCHEDULES AND SPECIFICATIONS (AS APPLICABLE).

-THE BUILDER AND SUBCONTRACTOR SHALL ENSURE THAT ALL STORMWATER DRAINS, SEWER PIPES AND THE LIKE ARE LOCATED AT A SUFFICIENT DISTANCE FROM ANY BUILDINGS FOOTING AND/OR SLAB EDGE BEAMS SO AS TO PREVENT GENERAL MOISTURE PENETRATION, DAMPNESS, WEAKENING & UNDERMINING OF ANY BUILDING AND ITS FOOTING SYSTEM

- LOCATION OF ALL EXISTING ONSITE SERVICES TO BE CONFIRMED ONSITE PRIOR TO CONSTRUCTION

#### IMPORTANT!

SITE INFORMATION AS DRAWN IS APPROXIMATE ONLY. FINAL SITE INFORMATION IS SUBJECT TO A DETAILED CONTOUR SURVEY BY LICENSED SURVEYOR.

SOIL CLASSIFICATION:


Ρ

WIND CLASSIFICATION

N2

SITE COVERAGE SITE AREA 979.99 m<sup>2</sup> PROPOSED BUILDING FOOTPRINT 385.1 m<sup>2</sup> PROPOSED SITE COVERAGE 39.29 % SITE DENSITY / AREA PER UNIT 326.66 m<sup>2</sup>

Drive		CLIENT: Matthew Chamberlain		
. Brown	ACCRED.	NO.: CC6652	SHEET:	2 of 25
Q. Tra	DATE:	August 2024	DESIGN TYPE:	Custom
	DATE:		DRAWING NO:	198076
1:200	REV:	В		190010

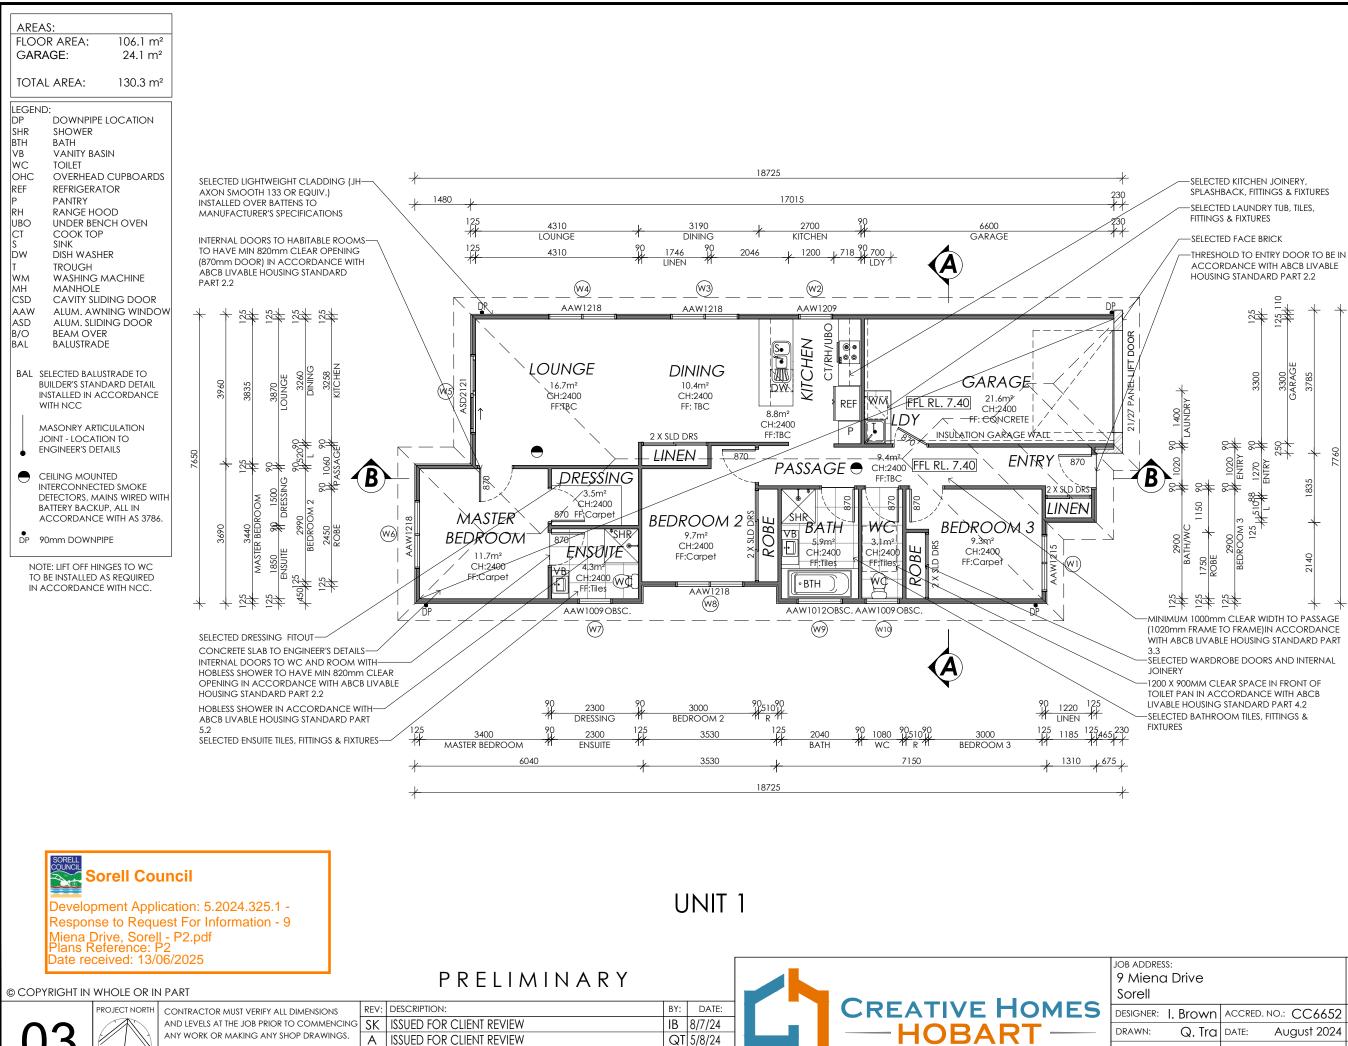

IB 13/6/25

DO NOT SCALE DRAWINGS. ALWAYS USE WRITTEN DIMENSIONS

B COUNCIL RFI

CREATIVE HOMES HOBART, CNR OF ELWICK ROAD & BROOKER HIGHWAY, GLENORCHY 7010 PH: 03 6272 3000

CHECKED:

SCALE:

#### Framing NCC H1D6

All timber framing, fixing and bracing shall comply with AS 1684 and the requirements of NCC H1D6. Manufactured sizes must not be undersized to those specified, for all timber sizes, stress grades, spacing and wall bracing refer to Engineer's details. Tie-down details shall be in accordance With Engineer's details and comply with NCC H1D6 (4). Structural steel members shall comply with the requirements of clauses in NCC H1D6 (3). Refer to Engineer's details where provided.

#### Glazina NCC H1D8

Glazing NCC H1D8 All windows to be aluminium awning style, double glazed (obscured safety glass to bathrooms as shown on drawings) All glazing shall comply with the requirements of AS 2047 & AS 1288 and NCC H1D8.

Human impact safety requirements shall comply with NCC H1D8 (3) and Part 8.4 of the ABCB Housing provisions.

Builder and subcontractors to verify all dimension and levels prior to the commencement of any work. Give 24hrs minimum notice where amendments are Thinnium noice where amendments an required to design of working drawings. These drawings are to be read in conjunction with Engineer's and Surveyor's drawings and notes. Do not scale drawings, Dimensions are to take scale drawings. Dimensions are to take preference over scale, Building specification and Engineer's drawings shall override architectural drawings. All construction work shall be carried out in accordance with the state building regulations, local council by-laws and relevant NCC and AS codes.

Important notice for attention of Owner the Owners attention is drawn to the fact that foundations and associated drainage in all sites requires continuing maintenance to assist footing maintenance. Advice for foundation maintenance is contained in the CSIRO building technology file 18 and it is the Owners responsibility to maintain the site in accordance with this document.


Energy efficiency: Insulation must comply with AS/NZS4859.1 and be installed in accordance with ABCB housing provisions Part 13.2.2 and comply with minimum R values for climate zone 7. Bulk insulation between climate Zone 7. built insulated with min external studs to be insulated with min R2.0. (Ensure batts fit within cavity without compression, making sure that there is at least 25mm gap from the reflective surface). External walls are to be bedref with user are area walls reflective surface). External walls are to be clad with vapour permeable reflective foil over the outside of the timber frame. Ceiling to be insulated with R4.0 and vapour permeable sarking. Floor to be insulated with Min R1.7 batts where applicable. Seal exhaust fans to Ensuite, Bathroom, Laundry and Kitchen. All downlights to be IC rated. Construction of the external walls, floor and roof for complance with building sealing requirements shall comply with BCA 2019 Part 3.12

General: All flashings, weep holes and damp proof coursing to be in accordance with NCC Housing provisions Part 5.7. Fibre cement sheet in accordance with NCC Housing provisions Part 7.5. Block construction in accordance NCC Housing provisions Part 5.2. Plasterboard linings to internal walls and ceilings with selected cornice. (see below for wet areas) areas)

Wet areas: All wet areas shall comply with the requirements of ABCB Housing provisions Part 10.2, Provide waterproof plasterboard sheeting to all walls and ceilings. Provide ceramic tiles or other approved water resistant lining in accordance with Part 10.2.9 to a minimum height of 1800mm to shower walls and to a height of min 150mm behind baths, basins, sinks, troughs, waching machings and wall liftures washing machines and wall fixtures

For construction of floor wastes refer to NCC ABCB Housing provisions part 10.2.12. For typical installation requirements for substrate preparation penetrations, flashings/ junctions, membranes, screeds, hobs, baths, showers, door jambs and screens refer to ABCB Housing provisions part 10.2.14-32.

1:100	DATE: REV:	В	DRAWING NO: 🆌	98076
Q. Tra	DATE:	August 2024		Custom
. Brown	ACCRED.	NO.: CC6652	SHEET:	3 of 25
Drive			CLIENT: Matthew Ch	amberlain

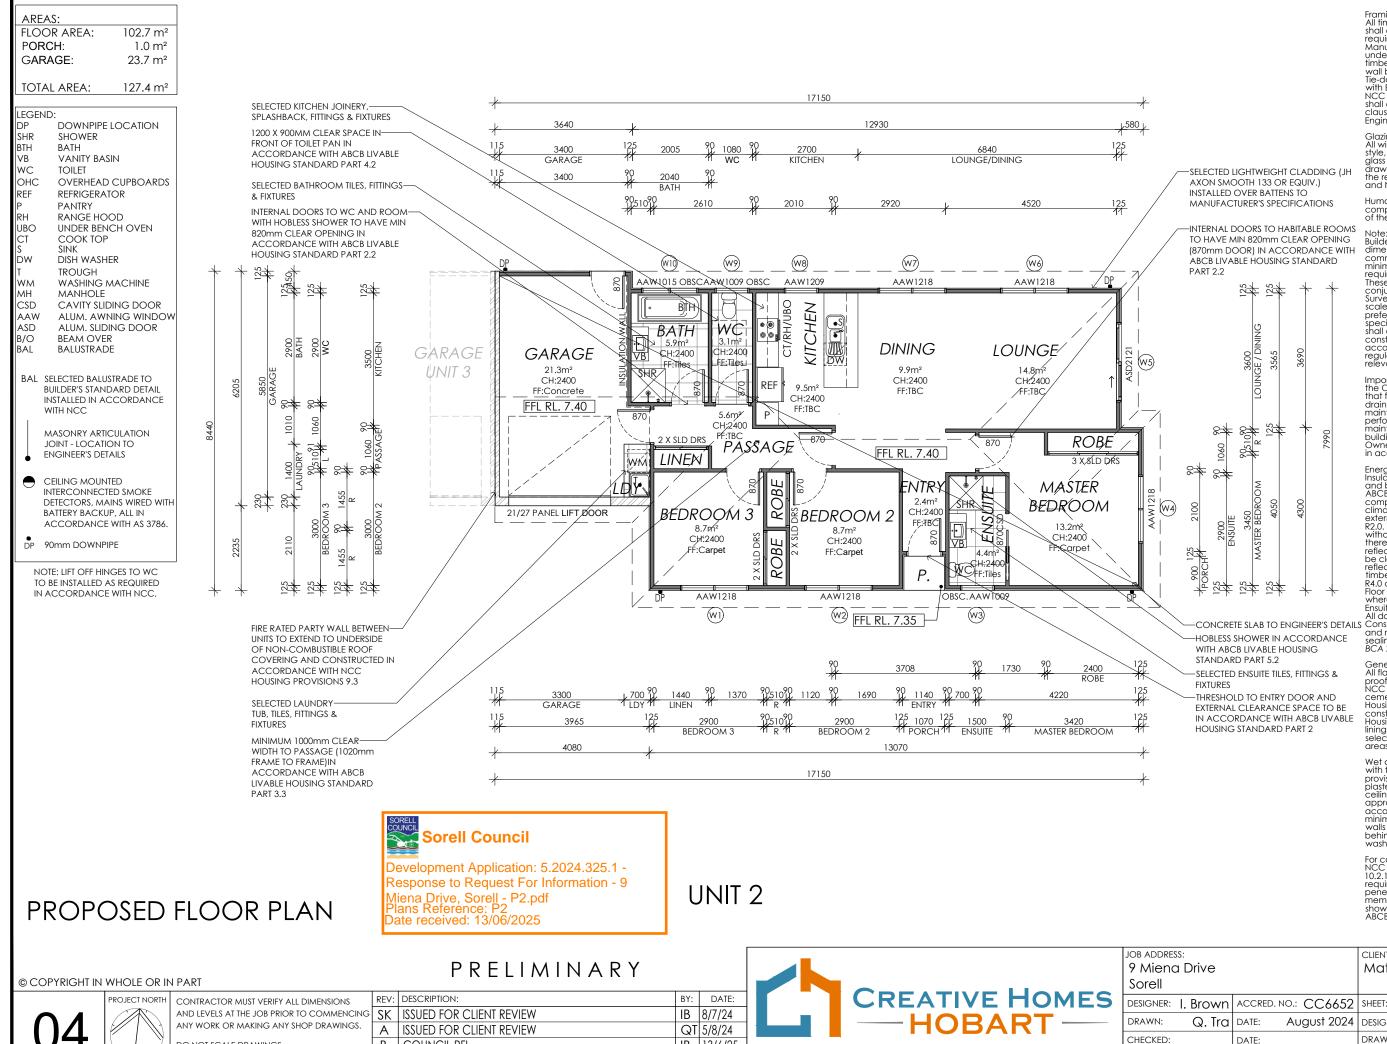


CREATIVE HOMES HOBART, CNR OF ELWICK ROAD & BROOKER HIGHWAY, GLENORCHY 7010 PH: 03 6272 3000

B COUNCIL RFI IB 13/6/25 DO NOT SCALE DRAWINGS. ALWAYS USE WRITTEN DIMENSIONS

SELECTED LIGHTWEIGHT CLADDING (JH AXON SMOOTH 133 OR EQUIV.) INSTALLED OVER BATTENS TO MANUFACTURER'S SPECIFICATIONS

-INTERNAL DOORS TO HABITABLE ROOMS TO HAVE MIN 820mm CLEAR OPENING (870mm DOOR) IN ACCORDANCE WITH ABCB LIVABLE HOUSING STANDARD PART 2.2

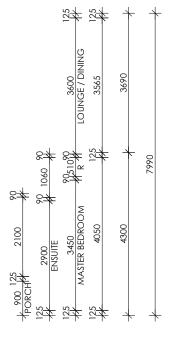

-HOBLESS SHOWER IN ACCORDANCE

WITH ABCB LIVABLE HOUSING STANDARD PART 5.2

Q. Tra DATE:

1:100

SCALE:

DATE

REV:

-SELECTED ENSUITE THES FITTINGS & FIXTURES

-THRESHOLD TO ENTRY DOOR AND EXTERNAL CLEARANCE SPACE TO BE IN ACCORDANCE WITH ABCB LIVABLE

HOUSING STANDARD PART 2

and roof for compliance with building sealing requirements shall comply with BCA 2019 Part 3.12 General: All flashings, weep holes and damp All itashings, weep noies and damp proof coursing to be in accordance with NCC Housing provisions Part 5.7. Fibre cement sheet in accordance with NCC Housing provisions Part 7.5. Block construction in accordance NCC Housing provisions Part 5. Plasterboard linings to internal walls and ceilings with selected comice (see below for wet

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showers, door jambs and screens refer to ABCB Housing provisions part 10.2.14-32.

4 of 25

Custom

76

Matthew Chamberlain

DRAWING NO: 1980

CLIENT

August 2024 DESIGN TYPE:

В

Energy efficiency: Insulation must comply with AS/NZS4859.1 and be installed in accordance with ABCB housing provisions Part 13.2.2 and comply with minimum R values for climate zone 7. Bulk insulation between external studs to be insulated with min R2.0. (Ensure batts fit within cavity without compression making sure that R2.0. (Ensure batts iff within cavity without compression, making sure that there is at least 25mm gap from the reflective surface). External walls are to be clad with vapour permeable reflective foil over the outside of the timber frame. Ceiling to be insulated with R4.0 and vapour permeable sarking. R4.0 and vapour permeable sarking. Floor to be insulated with Min R1.7 batts -CONCRETE SLAB TO ENGINEER'S DETAILS Construction of the external walls, floor


Important notice for attention of Owners: the Owners attention is drawn to the fact that foundations and associated drainage in all sites requires continuing maintenance to assist footing performance. Advice for foundation maintenance is contained in the CSIRO building technology file 18 and it is the Owners responsibility to maintain the site in accordance with this document in accordance with this document

Note: Builder and subcontractors to verify all dimension and levels prior to the commencement of any work. Give 24hrs minimum notice where amendments are required to design of working drawings. These drawings are to be read in conjunction with Engineer's and Surveyor's drawings and notes. Do not scale drawings. Dimensions are to take preference over scale. Building specification and Engineer's drawings shall override architectural drawings. All construction work shall be carried out in accordance with the state building regulations. local council by-laws and regulations, local council by-laws and relevant NCC and AS codes.

Human impact safety requirements shall comply with NCC H1D8 (3) and Part 8.4 of the ABCB Housing provisions.

Glazing NCC H1D8 All windows to be aluminium awning style, double glazed (obscured safety glass to bathrooms as shown on drawings) All glazing shall comply with the requirements of AS 2047 & AS 1288 and NCC H1D8.

Framing NCC H1D6 All timber framing, fixing and bracing shall comply with AS 1684 and the requirements of NCC H1D6. Manufactured sizes must not be undersized to those specified, for all timber sizes array random spacing and timber sizes, stress grades, spacing and wall bracing refer to Engineer's details. Tie-down details shall be in accordance with Engineer's details and comply with NCC H1D6 (4). Structural steel members shall comply with the requirements of clauses in NCC H1D6 (3). Refer to Engineer's details where provided.

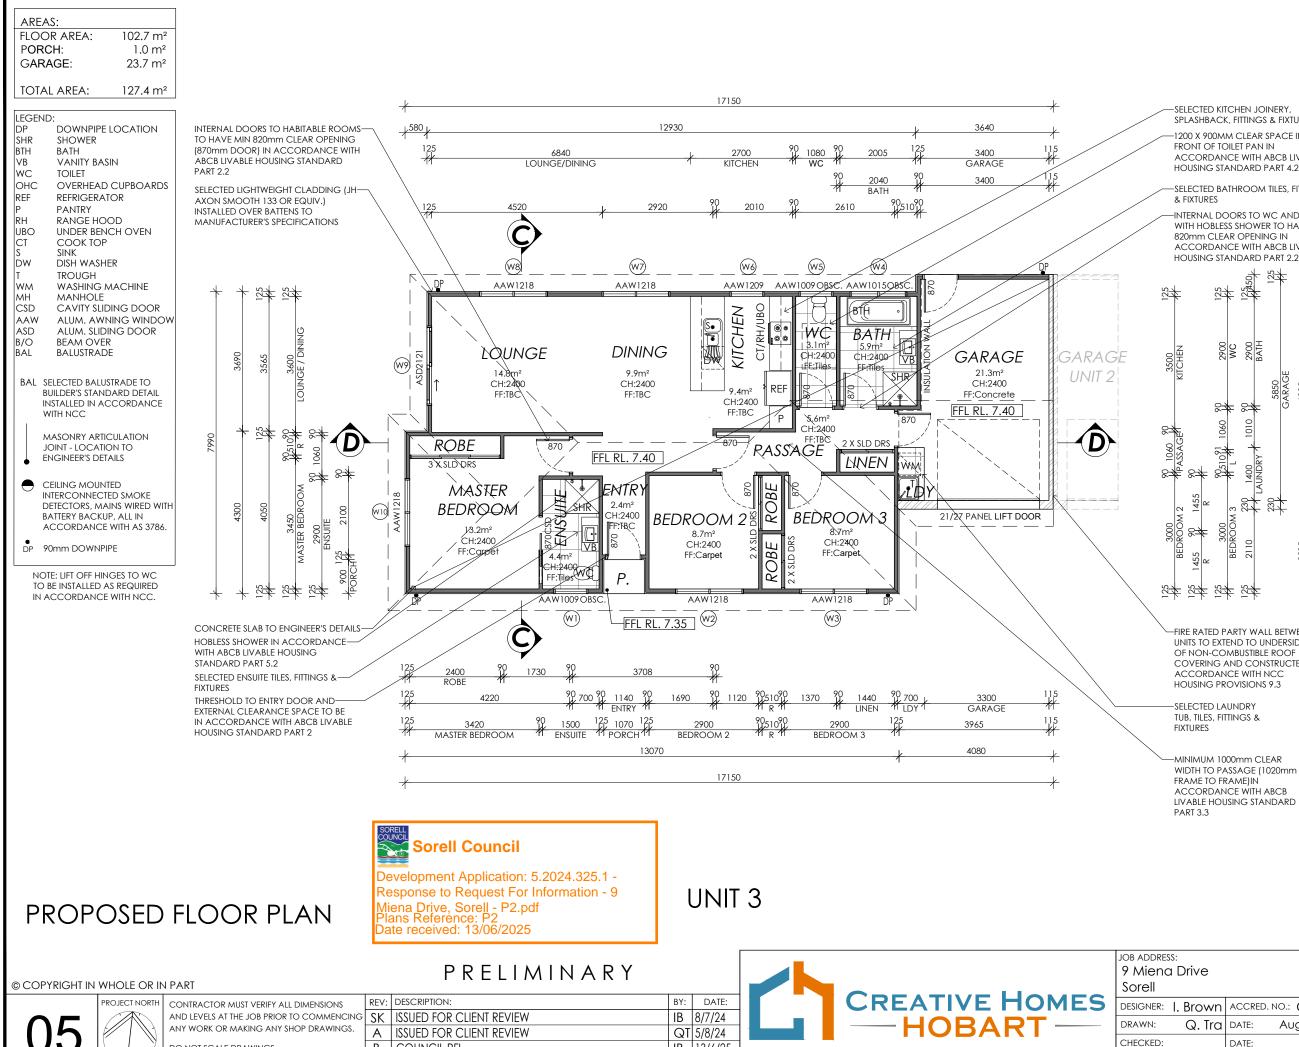

IB 13/6/25

B COUNCIL RFI

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CREATIVE HOMES HOBART, CNR OF ELWICK ROAD & BROOKER HIGHWAY, GLENORCHY 7010 PH: 03 6272 3000

Drive			Matthew Ch	amberlain
. Brown	ACCRED.	NO.: CC6652	SHEET:	5of 25
Q. Tra	DATE:	August 2024	DESIGN TYPE:	Custom
	DATE:		DRAWING NO:	98076
1:100	REV:	В		30010

provisions Part 10.2. Provide waterproc plasterboard sheeting to all walls and ceilings. Provide ceramic tiles or other approved water resistant lining in accordance with Part 10.2.9 to a minimum height of 1800mm to shower walls and to a height of min 150mm behind baths, basins, sinks, troughs, washing machines and wall fixtures. For construction of floor wastes refer to NCC ABCB Housing provisions part 10.2.12. For typical installation requirements for substrate preparation, penetrations, flashings/ junctions, membranes, screeds, hobs, boths, bewere deprivate and screene refer to showers, door jambs and screens refer to ABCB Housing provisions part 10.2.14-32.

MINIMUM 1000mm CLEAR WIDTH TO PASSAGE (1020mm FRAME TO FRAME)IN ACCORDANCE WITH ABCB LIVABLE HOUSING STANDARD

SCALE:

HOUSING PROVISIONS 9.3 SELECTED LAUNDRY TUB, TILES, FITTINGS &

ACCORDANCE WITH NCC

OF NON-COMBUSTIBLE ROOF

-FIRE RATED PARTY WALL BETWEEN UNITS TO EXTEND TO UNDERSIDE COVERING AND CONSTRUCTED IN

800 MC 2900 SATH 5850 205 8<del>7</del> 8<del>7</del> 010 090 9051091 1400 LAUNDRY 87 1455 R 8t 8 0000 8# E L 455 R <u> 27 27 27 27</u>

& FIXTURES INTERNAL DOORS TO WC AND ROOM WITH HOBLESS SHOWER TO HAVE MIN 820mm CLEAR OPENING IN ACCORDANCE WITH ABCB LIVABLE

12 × 12

34

SELECTED BATHROOM TILES, FITTINGS

1200 X 900MM CLEAR SPACE IN FRONT OF TOILET PAN IN ACCORDANCE WITH ABCB LIVABLE HOUSING STANDARD PART 4.2

SELECTED KITCHEN JOINERY, SPLASHBACK, FITTINGS & FIXTURES

> Energy efficiency: Insulation must comply with AS/NZS4859.1 and be installed in accordance with ABCB housing provisions Part 13.2.2 and comply with minimum R values for climate zone 7. Bulk insulation between external studs to be insulated with min R2.0. [Ensure batts fit within cavity without compression making sure that R2.0. (Ensure batts tit within cavity without compression, making sure that there is at least 25mm gap from the reflective surface). External walls are to be clad with vapour permeable reflective foil over the outside of the timber frame. Ceiling to be insulated with R4.0 and vapour permeable carting R4.0 and vapour permeable sarking. Floor to be insulated with Min R1.7 batts where applicable. Seal exhaust fans to Ensuite, Bathroom, Laundry and Kitchen. All downlights to be IC rated. Construction of the external walls, floor and roof for compliance with building sealing requirements shall comply with BCA 2019 Part 3.12 General: All flashings, weep holes and damp proof coursing to be in accordance with NCC Housing provisions Part 5.7. Fibre cement sheet in accordance with NCC Housing provisions Part 7.5. Block construction in accordance NCC Housing provisions Part 5. Plasterboard linings to internal walls and ceilings with selected cornice. (see below for wet areas)

Wet areas: All wet areas shall comply with the requirements of ABCB Housing provisions Part 10.2. Provide waterproof


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Builder and subcontractors to verify all dimension and levels prior to the commencement of any work. Give 24hrs commencement of any work. Give 24hrs: minimum notice where amendments are required to design of working drawings. These drawings are to be read in Surveyor's drawings and notes. Do not scale drawings. Dimensions are to take preference over scale. Building specification and Engineer's drawings shall override architectural drawings. All construction work shall be carried out in construction work shall be carried out in accordance with the state building regulations, local council by-laws and relevant NCC and AS codes.

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Framina NCC H1D6 Framing NCC H1D6. All timber framing, fixing and bracing shall comply with AS 1684 and the requirements of NCC H1D6. Manufactured sizes must not be undersized to those specified, for all timber sizes, stress grades, spacing and wall bracing refer to Engineer's details. Tie-down details shall be in accordance with Engineer's details and comply with NCC H1D6 (4). Structural steel members shall comply with the requirements of shall comply with the requirements of clauses in NCC H1D6 (3). Refer to Engineer's details where provided



IB 13/6/25

CREATIVE HOMES HOBART, CNR OF ELWICK ROAD & BROOKER HIGHWAY, GLENORCHY 7010 PH: 03 6272 3000

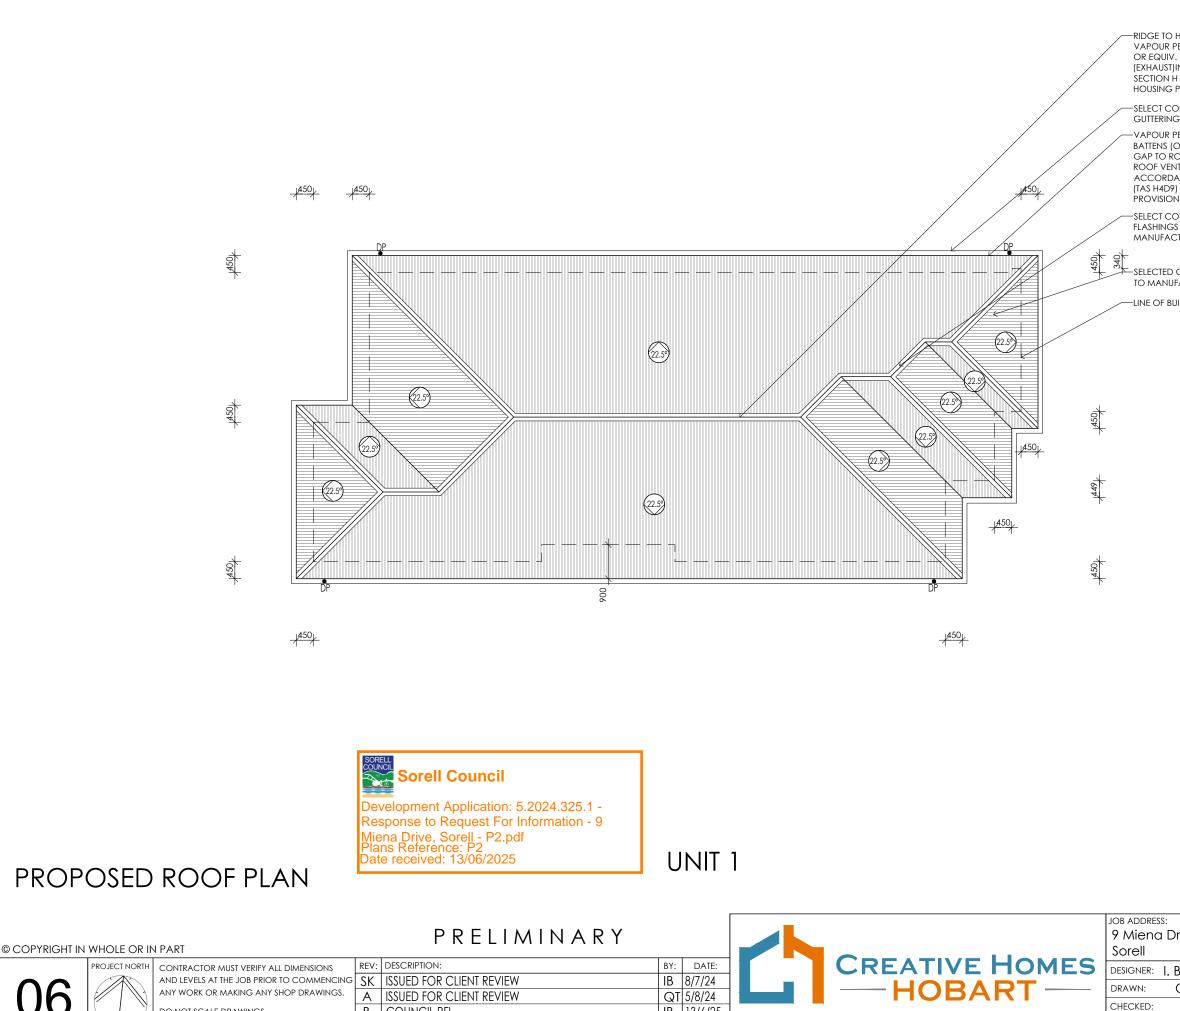B COUNCIL RFI

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ALWAYS USE WRITTEN DIMENSIONS.

) HAVE CONTINUOUS GAP IN	
R PERMEABLE SARKING (5mm)	
IV. VENTILATION SYSTEM	
T)IN ACCORDANCE WITH NCC	
I H (TAS H4D9) AND ABCB	
G PROVISIONS 10.8.3	

-SELECT COLORBOND FASCIA AND

-VAPOUR PERMEABLE SARKING UNDER BATTENS (OR EQUIV.) (WITH 25MM AIR GAP TO ROOFING) AND MINIMUM 10MM ROOF VENTILATION (SUPPLY) GAP IN ACCORDANCE WITH NCC SECTION H (TAS H4D9) AND ABCB HOUSING PROVISIONS 10.8.3

-SELECT COLORBOND CAPPING AND FLASHINGS INSTALLED TO MANUFACTURER'S SPECIFICATION

-SELECTED COLORBOND ROOF INSTALLED TO MANUFACTURER'S SPECIFICATION

-LINE OF BUILDING UNDER

Framing NCC H1D6 All timber framing, fixing and bracing shall comply with AS 1684 and the requirements of NCC H1D6. Manufactured sizes must not be undersized to those specified, for all timbers in the practice area area timber sizes, stress grades, spacing and wall bracing refer to Engineer's details. Tie-down details shall be in accordance with Engineer's details and comply with NCC H1D6 (4). Structural steel members shall comply with the requirements of clauses in NCC H1D6 (3). Refer to Engineer's details where provided.

Glazing NCC H1D8 All windows to be aluminium awning style, double glazed (obscured safety glass to bathrooms as shown on

drawings) All glazing shall comply with the requirements of AS 2047 & AS 1288 and NCC H1D8.

Human impact safety requirements shall comply with NCC H1D8 (3) and Part 8.4 of the ABCB Housing provisions.

Note: Builder and subcontractors to verify all dimension and levels prior to the commencement of any work. Give 24hrs minimum notice where amendments are required to design of working drawings. These drawings are to be read in conjunction with Engineer's and Surveyor's drawings and notes. Do not scale drawings. Dimensions are to take preference over scale. Building specification and Engineer's drawings shall override architectural drawings. All construction work shall be carried out in accordance with the state building regulations, local council by-laws and regulations, local council by-laws and relevant NCC and AS codes.

Important notice for attention of Owners: the Owners attention is drawn to the fact that foundations and associated drainage in all sites requires continuing maintenance to assist footing performance. Advice for foundation maintenance is contained in the CSIRO building technology file 18 and it is the Owners responsibility to maintain the site in accordance with this downant. in accordance with this document

Energy efficiency: Insulation must comply with AS/NZS4859.1 and be installed in accordance with ABCB housing provisions Part 13.2.2 and comply with minimum R values for climate zone 7. Bulk insulation between external studs to be insulated with min R2.0. [Ensure batts fit within cavity without compression making sure that

R2.0. (Ensure batts it within cavity without compression, making sure that there is at least 25mm gap from the reflective surface). External walls are to be clad with vapour permeable reflective foil over the outside of the timber frame. Ceiling to be insulated with P4.0 and vapour permeable sarking. R4.0 and vapour permeable sarking. Floor to be insulated with Min R1.7 batts where applicable. Seal exhaust fans to Ensuite, Bathroom, Laundry and Kitchen. All downlights to be IC rated. Construction of the external walls, floor and rose for compliance with building and roof for compliance with building sealing requirements shall comply with BCA 2019 Part 3.12

General: All flashings, weep holes and damp proof coursing to be in accordance with NCC Housing provisions Part 5.7. Fibre cement sheet in accordance with NCC Housing provisions Part 7.5. Block construction in accordance NCC Housing provisions Part 5. Plasterboard linings to internal walls and ceilings with celected cornice (see below for wet selected cornice. (see below for wet areas)

Wet areas: All wet areas shall comply with the requirements of ABCB Housing provisions Part 10.2, Provide waterproof plasterboard sheeting to all walls and ceilings. Provide ceramic tiles or other approved water resistant lining in accordance with Part 10.2,9 to a minimum height of 1800mm to shower walls and to a height of min 150mm behind baths, basins, sinks, troughs, washing machines and wall fixtures.

For construction of floor wastes refer to NCC ABCB Housing provisions part 10.2.12. For typical installation requirements for substrate preparation, penetrations, flashings/ junctions, membranes, screeds, hobs, baths, showers, door jambs and screens refer to ABCB Housing provisions part 10.2.14-32.

• DP 90mm DOWNPIPE

SCALE:

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. Brown	ACCRED.	NO.: CC6652	SHEET:	60f 25
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	DATE:		DRAWING NO:	98076
1:100	REV:	В		90070

#### Framing NCC H1D6

All timber framing, fixing and bracing shall comply with AS 1684 and the requirements of NCC H1D6. Manufactured sizes must not be undersized to those specified, for all timber sizes, stress grades, spacing and wall bracing refer to Engineer's details. Tie-down details shall be in accordance with Engineer's details and comply with NCC H1D6 (4). Structural steel members shall comply with the requirements of clauses in NCC H1D6 (3). Refer to Engineer's details where provided.

1450j

DO NOT SCALE DRAWINGS.

ALWAYS USE WRITTEN DIMENSIONS

#### Glazing NCC H1D8

All windows to be aluminium awning style, double glazed (obscured safety glass to bathrooms as shown on drawings) All alazing shall comply with the requirements of AS 2047 & AS 1288 and NCC H1D8.

Human impact safety requirements shall comply with NCC H1D8 (3) and Part 8.4 of the ABCB Housing provisions.

#### Note:

Builder and subcontractors to verify all dimension and levels prior to the commencement of any work. Give 24hrs minimum notice where amendments are required to design of working drawings.

These drawings are to be read in conjunction with Engineer's and Surveyor's drawings and notes. Do not scale drawings. Dimensions are to take preference over scale. Building specification and Engineer's drawings shall override architectural drawinas. All construction work shall be carried out in accordance with the state building regulations, local council by-laws and relevant NCC and AS codes.

Important notice for attention of Owners: the Owners attention is drawn to the fact that foundations and associated drainage in all sites requires continuing maintenance to assist footing performance.

Advice for foundation maintenance is contained in the CSIRO building technology file 18 and it is the Owners responsibility to maintain the site in accordance with this document.

#### Energy efficiency:

Insulation must comply with AS/NZS4859.1 and be installed in accordance with ABCB housing provisions Part 13.2.2 and comply with minimum R values for climate zone 7. Bulk insulation between external studs to be insulated with min R2.0. (Ensure batts fit within cavity without compression, making sure that there is at least 25mm gap from the reflective surface). External walls are to be clad with vapour permeable reflective foil over the outside of the timber frame.


CREATIVE HOMES HOBART, CNR OF ELWICK ROAD & BROOKER HIGHWAY, GLENORCHY 7010 PH: 03 6272 3000

Ceiling to be insulated with R4.0 and vapour permeable sarking. Floor to be insulated with Min R1.7 batts where applicable. Seal exhaust fans to Ensuite, Bathroom, Laundry and Kitchen, All downlights to be IC rated. Construction of the external walls, floor and roof for compliance with building sealing requirements shall comply with BCA 2019 Part 3.12

#### General:

All flashings, weep holes and damp proof coursing to be in accordance with NCC Housing provisions Part 5.7. Fibre cement sheet in accordance with NCC Housing provisions Part 7.5. Block construction in accordance NCC Housing provisions Part 5. Plasterboard linings to internal walls and ceilings with selected cornice. (see below for wet areas)

SCALE:

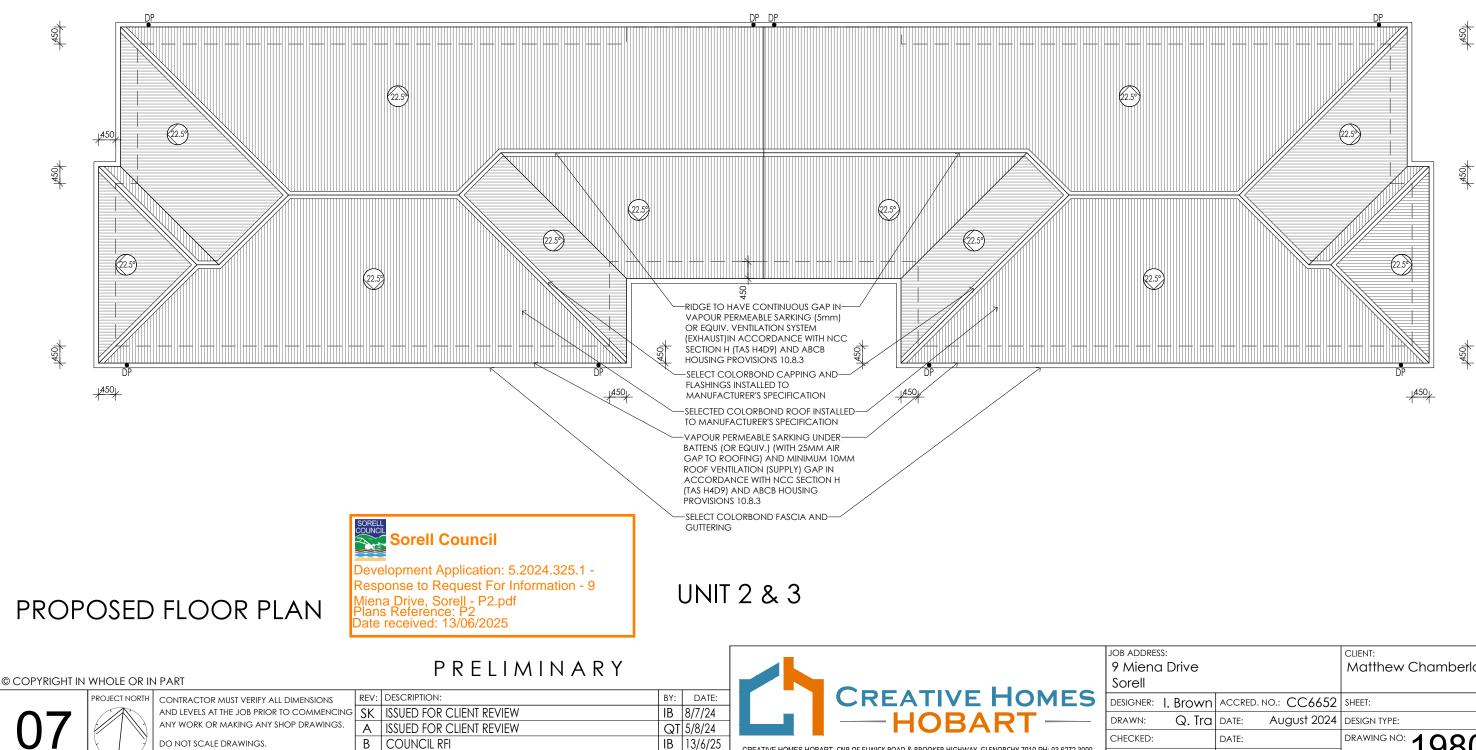


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Wet areas: All wet areas shall comply with the requirements of ABCB Housing provisions Part 10.2. Provide waterproof plasterboard sheeting to all walls and ceilinas. Provide ceramic tiles or other approved water resistant lining in accordance with Part 10.2.9 to a minimum height of 1800mm to shower walls and to a height of min 150mm behind baths, basins, sinks, troughs, washing machines and wall fixtures.

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Drive			Matthew (	Chamberlain
Brown	ACCRED.	NO.: CC6652	SHEET:	8of 25
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Framing NCC H1D6 All timber framing, fixing and bracing shall comply with AS 1684 and the requirements of NCC H1D6. Manufactured sizes must not be undersized to those specified, for all timber sizes, stress grades, spacing and wall bracing refer to Engineer's details. Tie-down details shall be in accordance with Engineer's details and comply with NCC H1D6 (4). Structural steel members shall comply with the requirements of clauses in NCC H1D6 (3). Refer to Engineer's details where provided.

Glazing NCC H1D8 All windows to be aluminium awning style, double glazed (obscured safety glass to bathrooms as shown on drawings) All glazing shall comply with the requirements of AS 2047 & AS 1288 and NCC H1D8.

Human impact safety requirements shall comply with NCC H1D8 (3) and Part 8.4 of the ABCB Housing provisions.

Builder and subcontractors to verify all

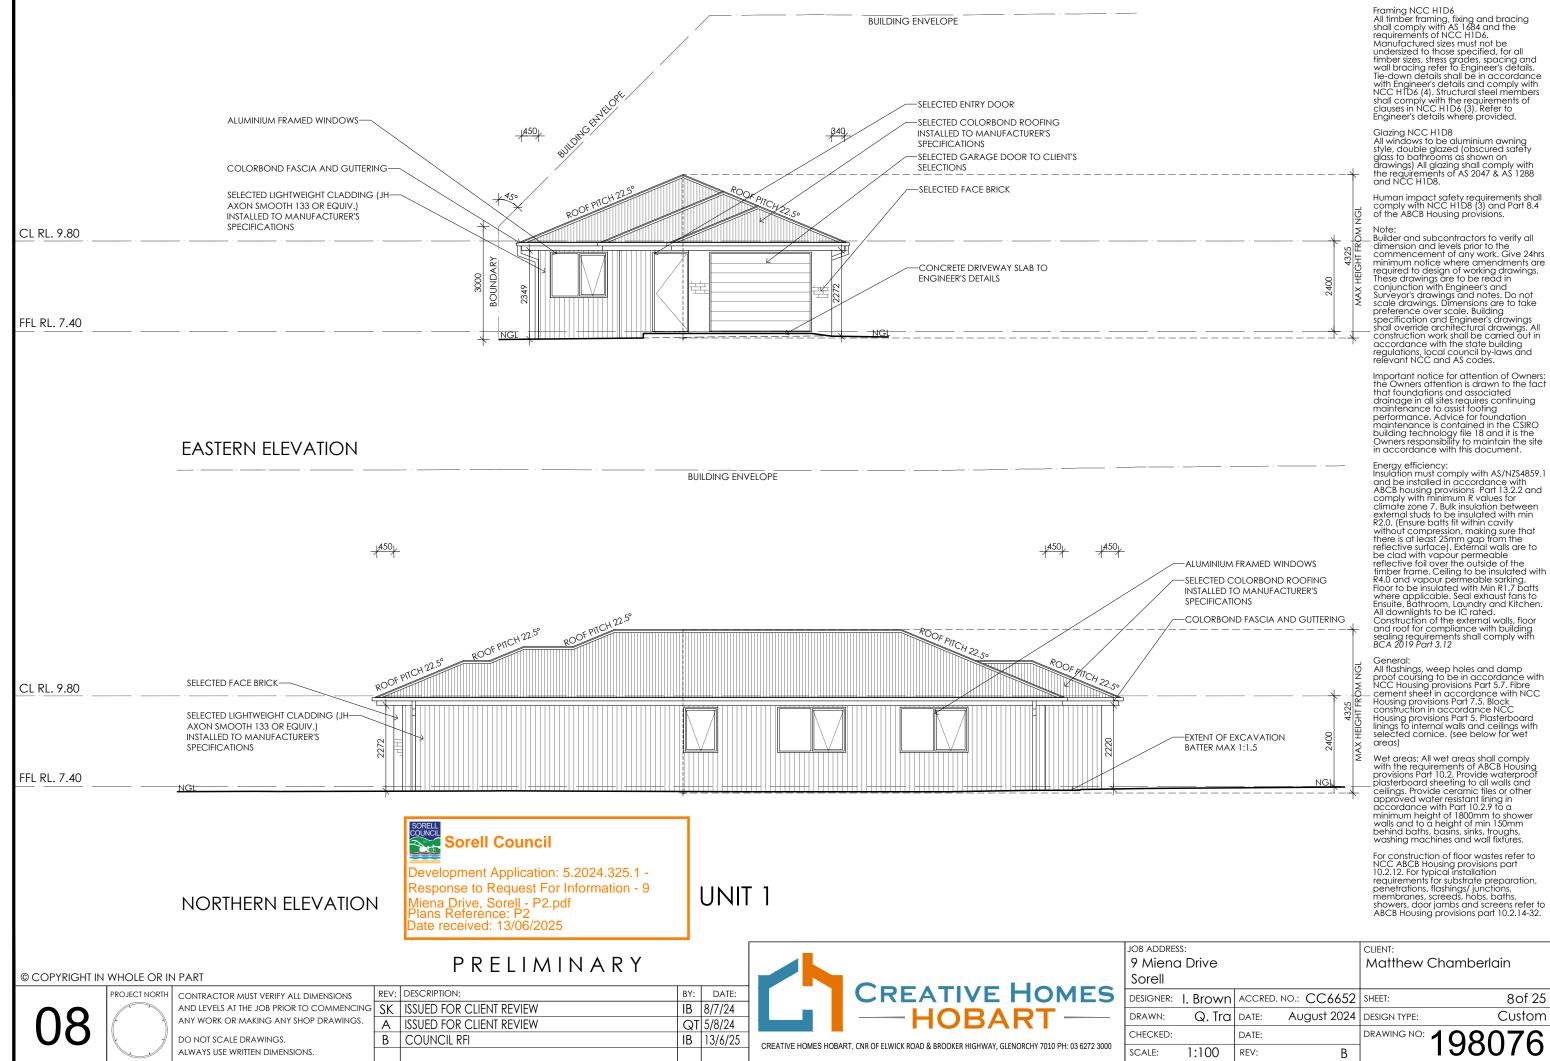Important notice for attention of Owners: the Owners attention is drawn to the fact that foundations and associated drainage in all sites requires continuing maintenance to assist footing performance. Advice for foundation

maintenance is contained in the CSIRO building technology file 18 and it is the Owners responsibility to maintain the site in accordance with this document.

Energy efficiency: Insulation must comply with AS/NZS4859.1


and be installed in accordance with ABCB housing provisions Part 13.2.2 and comply with minimum R values for climate zone 7. Bulk insulation between external studs to be insulated with min R2.0. (Ensure batts fit within cavity

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minimum height of 1800mm to shower walls and to a height of min 150mm behind baths, basins, sinks, troughs, washing machines and wall fixtures.

For construction of floor wastes refer to

showers, door jambs and screens refer to ABCB Housing provisions part 10.2.14-32.

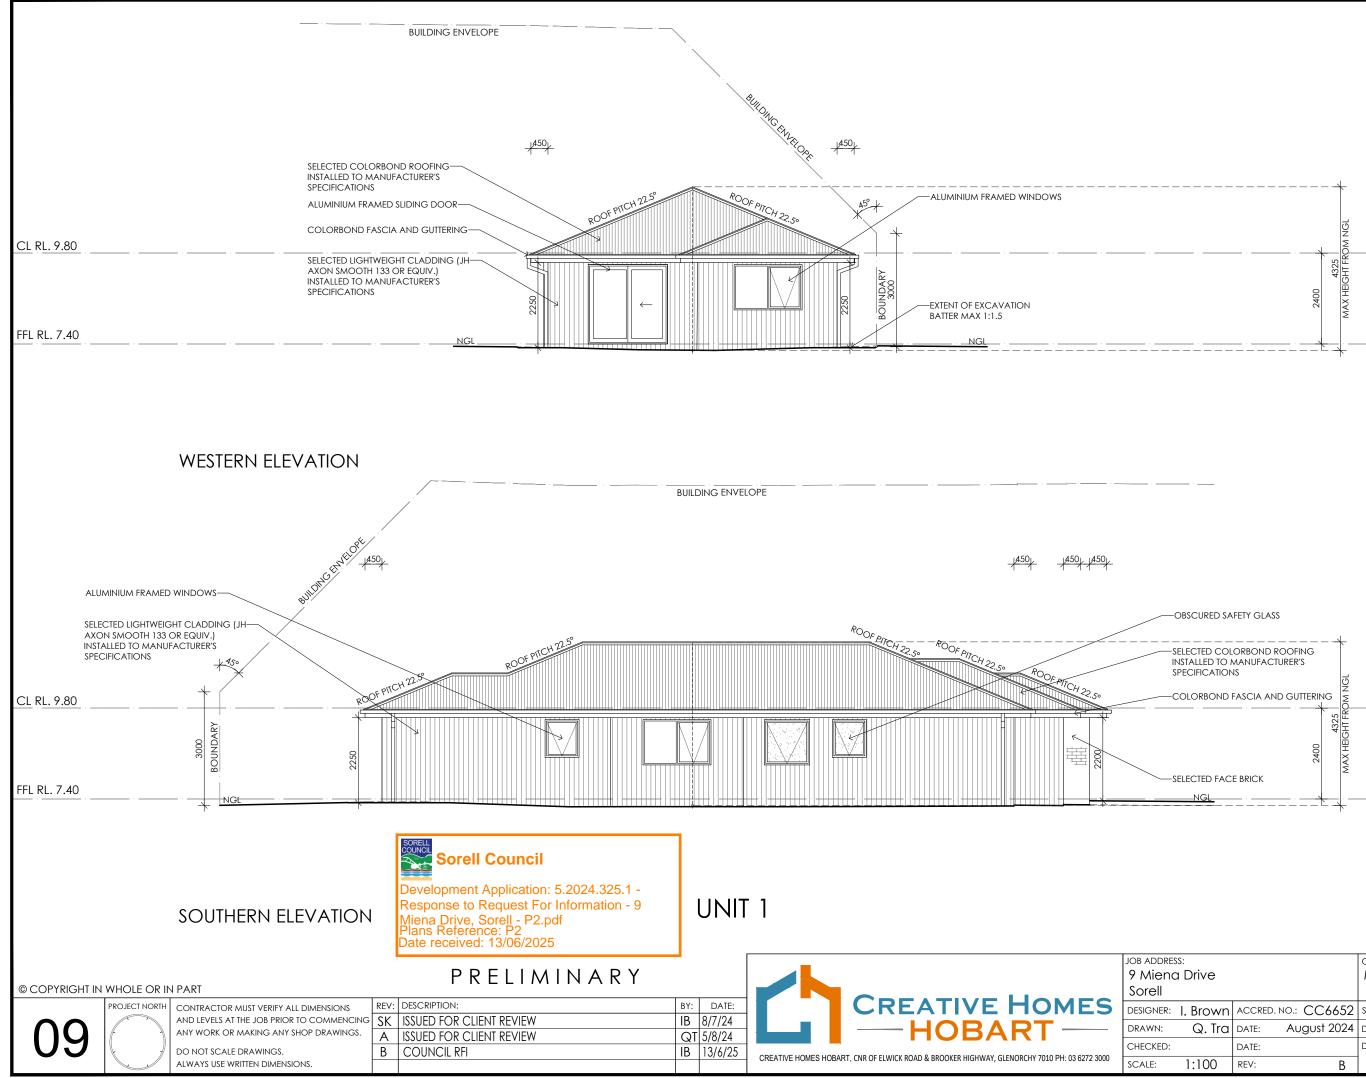

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# Note

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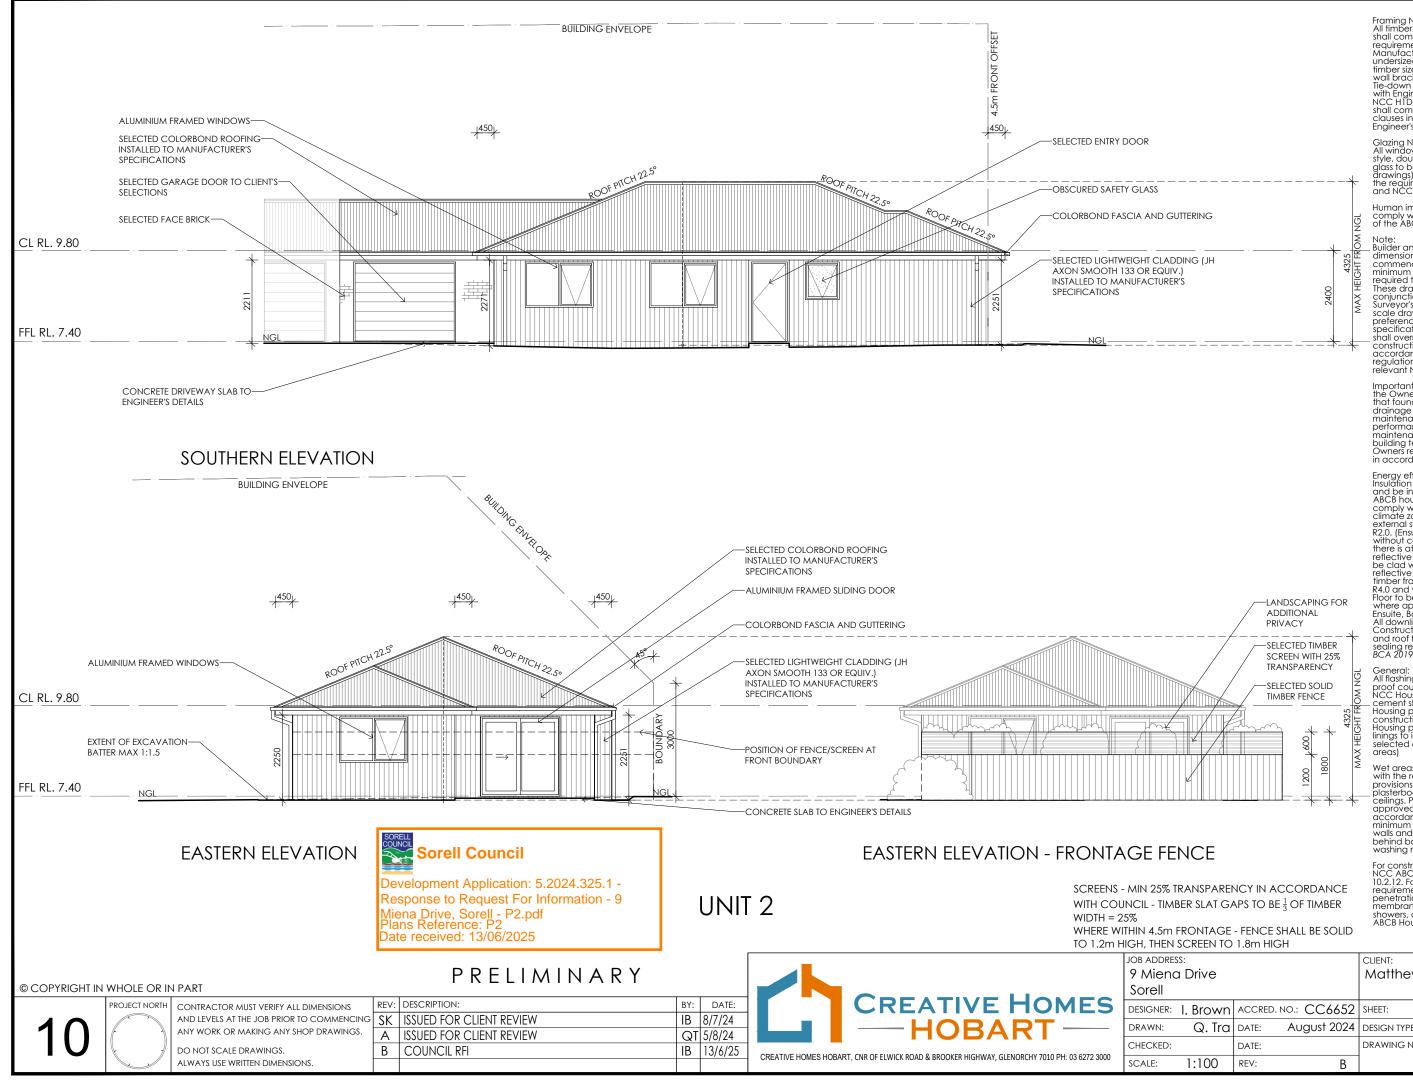
# General

General: All flashings, weep holes and damp proof coursing to be in accordance with NCC Housing provisions Part 5.7. Fibre - cement sheet in accordance with NCC Housing provisions Part 7.5. Block construction in accordance NCC Housing provisions Part 5. Plasterboard linings to internal walls and ceilings with selected cornice. (see below for wet areas) areas)

Wet areas: All wet areas shall comply with the requirements of ABCB Housing provisions Part 10.2. Provide waterproof plasterboard sheeting to all walls and ceilings. Provide ceratic tiles or other approved water costant liting a in approved water resistant lining in accordance with Part 10.2.9 to a minimum height of 1800mm to shower walls and to a height of min 150mm behind baths, basins, sinks, troughs, washing machines and wall fixtures.

For construction of floor wastes refer to For construction of floor wastes refer to NCC ABCB Housing provisions part 10.2.12. For typical installation requirements for substrate preparation, penetrations, flashings/ junctions, membranes, screeds, hobs, baths, showers, door jambs and screens refer to ABCB Housing provisions part 10.2.14-32.

Drive			CLIENT: Matthew Chamberlain		
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For construction of floor wastes refer to NCC ABCB Housing provisions part 10.2.12. For typical installation requirements for substrate preparation, penetrations, flashings/ junctions, membranes, screeds, hobs, baths, showers, door jambs and screens refer to ABCB Housing provisions part 10.2.14-32.

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in accordance with this document Energy efficiency: Insulation must comply with AS/NZS4859.1 and be installed in accordance with ABCB housing provisions Part 13.2.2 and comply with minimum R values for climate zone 7. Bulk insulation between external studs to be insulated with min R2.0. (Ensure batts fit within cavity without compression, making sure that there is at least 25mm gap from the reflective surface). External walls are to be clad with vapour permeable reflective foil over the outside of the timber frame. Ceiling to be insulated with R4.0 and vapour permeable sarking.

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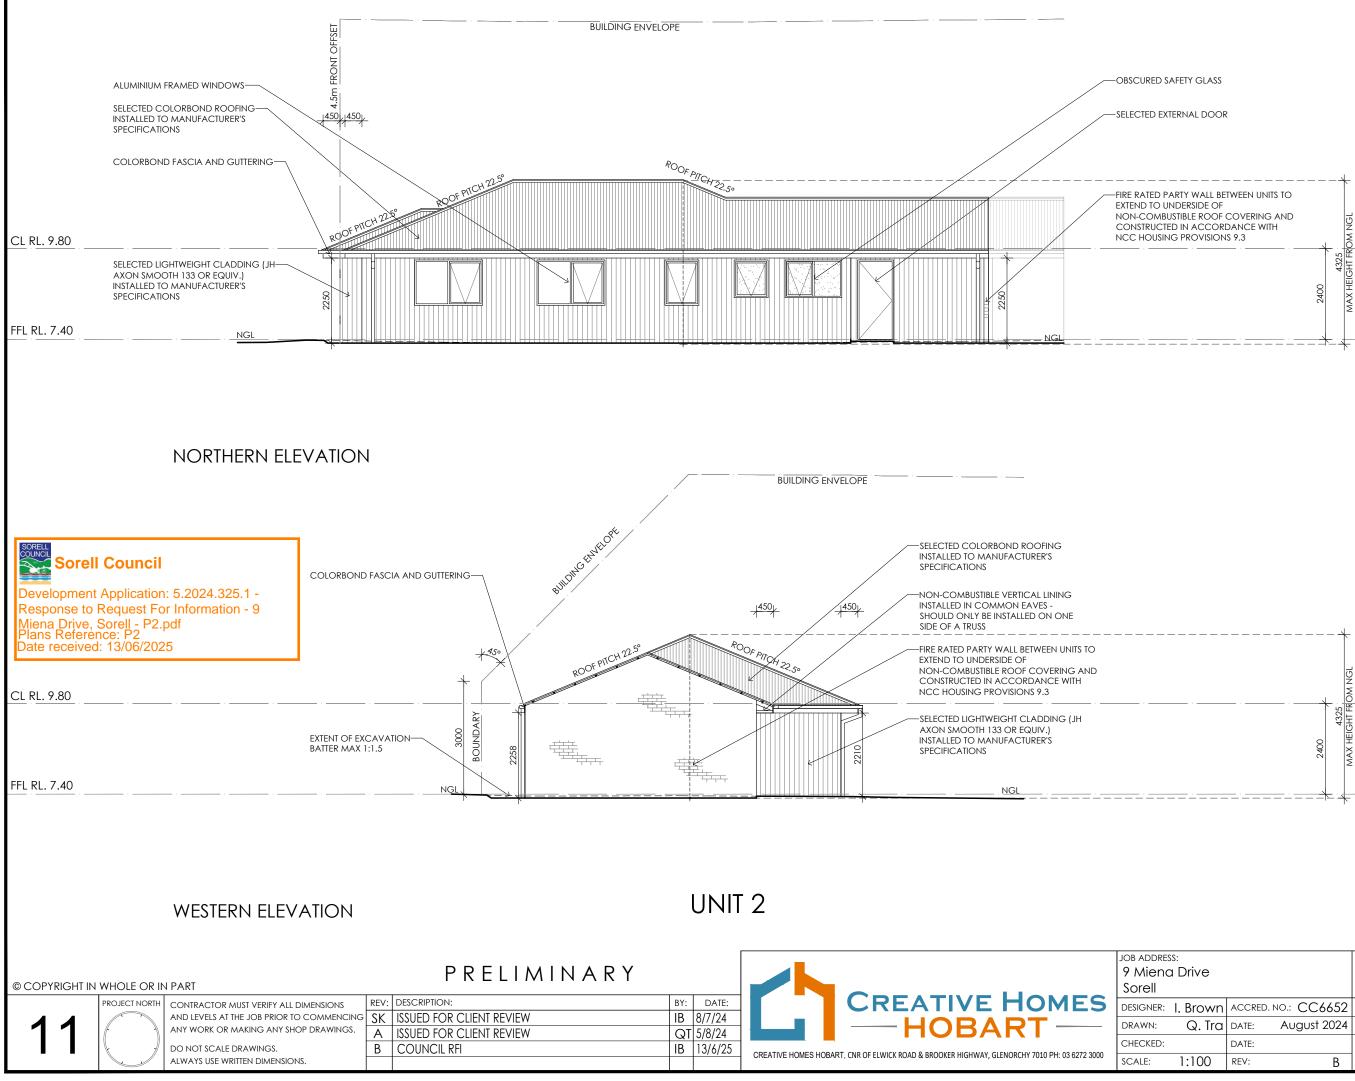
Human impact safety requirements shall comply with NCC H1D8 (3) and Part 8.4 of the ABCB Housing provisions.

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Engineer's details where provided. Glazing NCC H1D8 All windows to be aluminium awning style, double glazed (obscured safety

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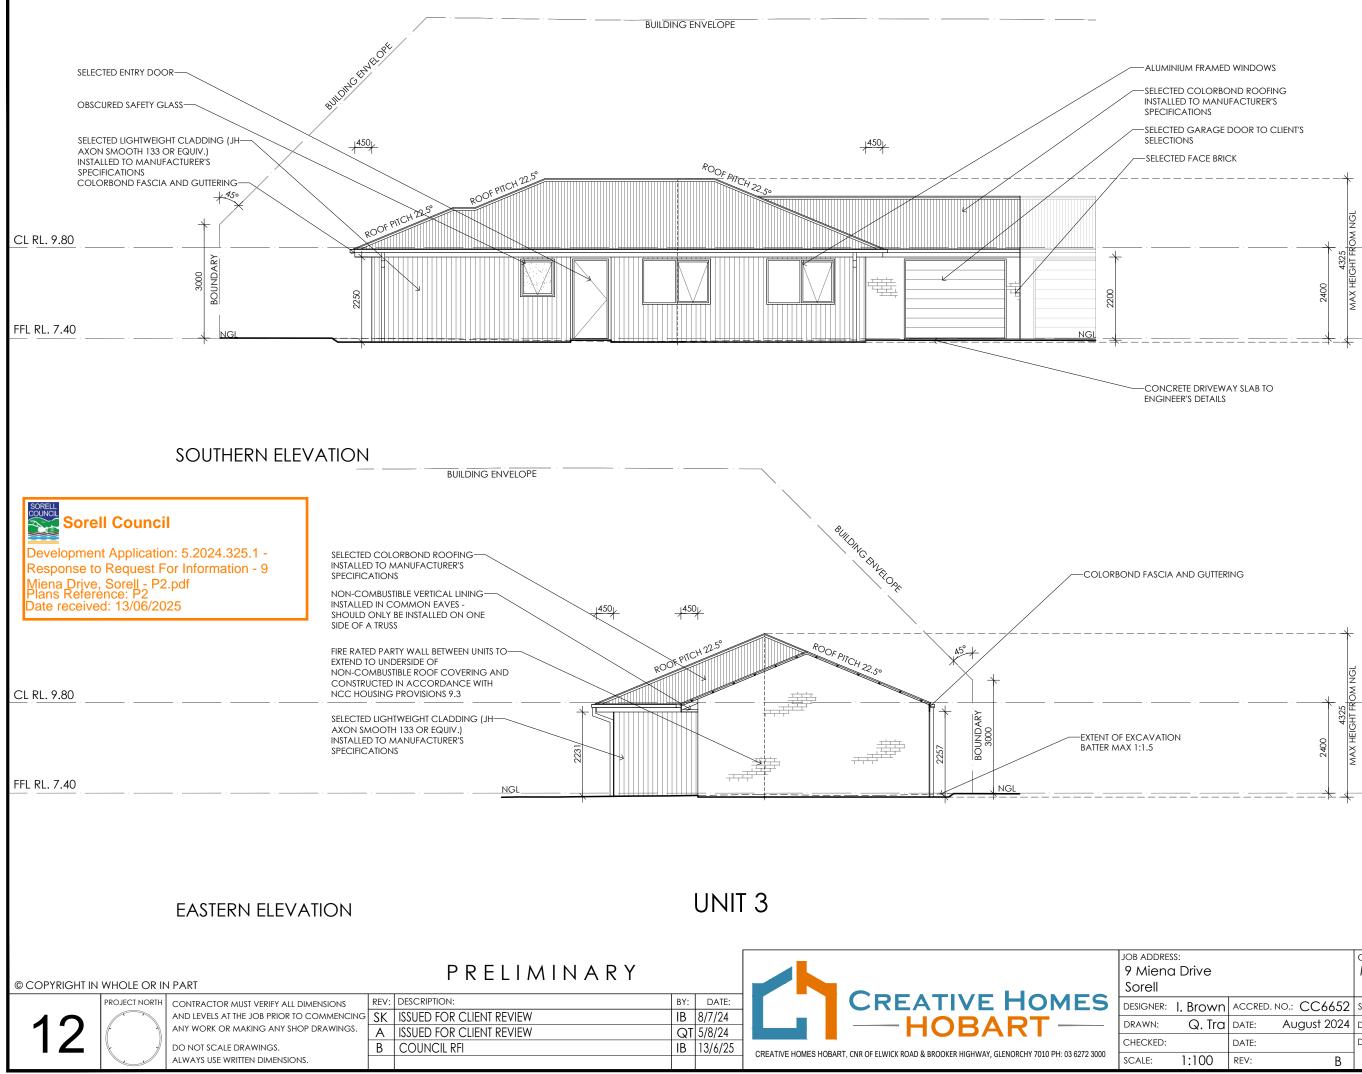
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Wet areas: All wet areas shall comply with the requirements of ABCB Housing provisions Part 10.2, Provide waterproof plasterboard sheeting to all walls and ceilings. Provide ceramic tiles or other approved water resistant liming in accordance with Part 10.2,9 to a minimum height of 1800mm to shower walls and to a height of min 150mm behind baths, basins, sinks, troughs, washing machines and wall fixtures.

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Drive			CLIENT: Matthew Chamberlain		
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Glazing NCC H1D8 All windows to be aluminium awning style, double glazed (obscured safety glass to bathrooms as shown on drawings) All glazing shall comply with the requirements of AS 2047 & AS 1288 and NCC H1D8.

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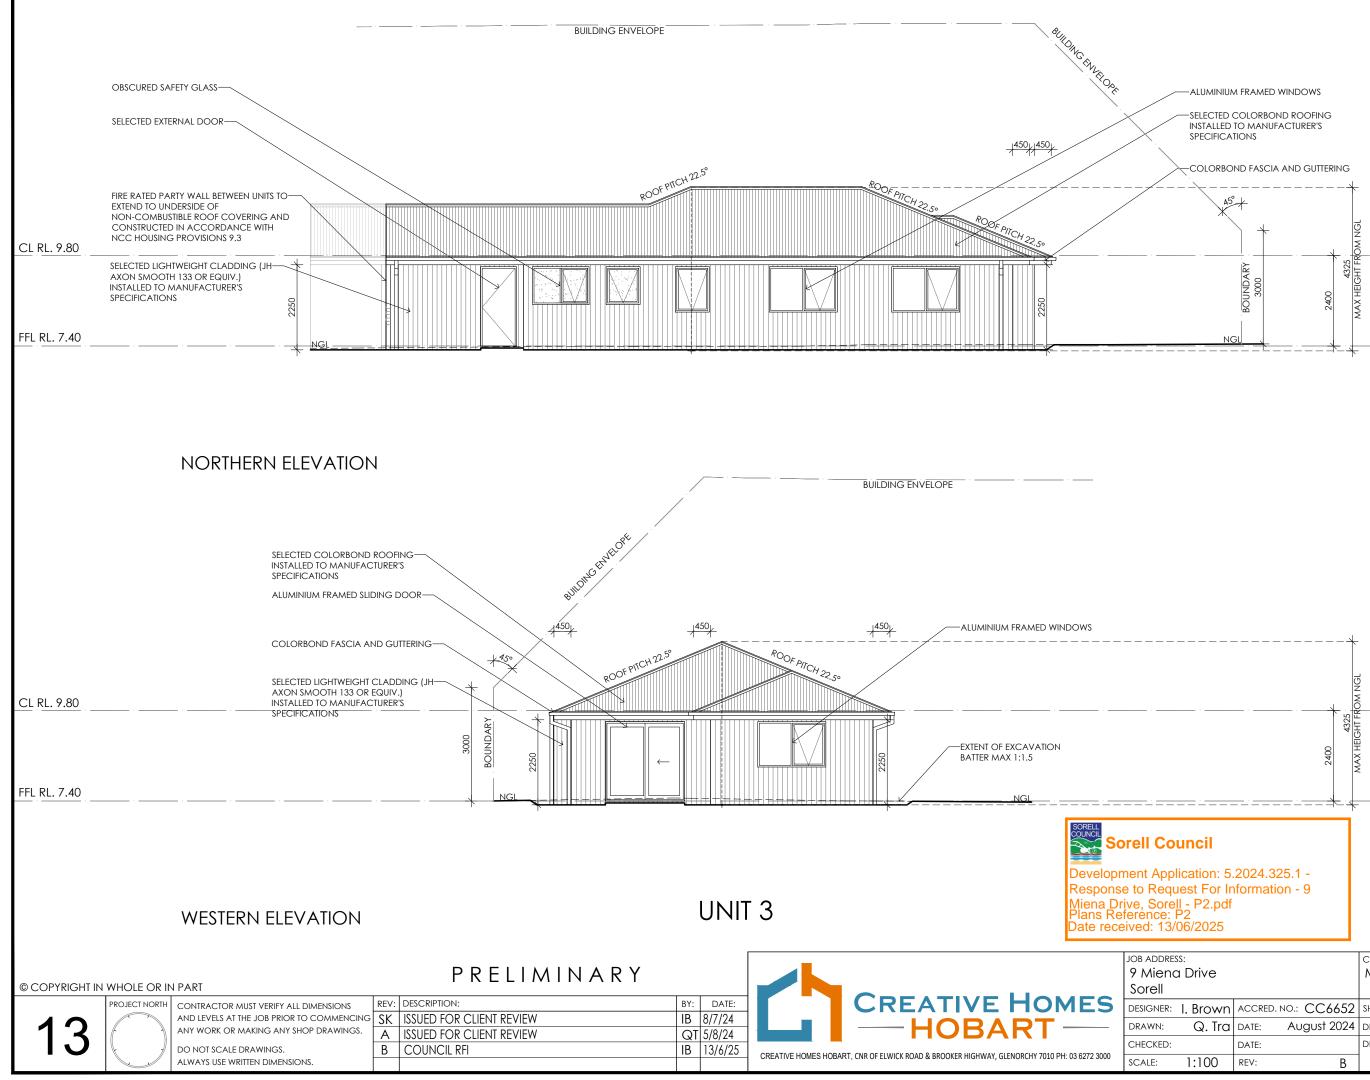
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Wet areas: All wet areas shall comply with the requirements of ABCB Housing provisions Part 10.2, Provide waterproof plasterboard sheeting to all walls and ceilings. Provide ceramic tiles or other approved water resistant liming in accordance with Part 10.29 to a minimum height of 1800mm to shower walls and to a height of min 150mm behind baths, basins, sinks, troughs, washing machines and wall fixtures.

For construction of floor wastes refer to NCC ABCB Housing provisions part 10.2.12. For typical installation requirements for substrate preparation, penetrations, flashings/ junctions, membranes, screeds, hobs, baths, showers, door jambs and screens refer to ABCB Housing provisions part 10.2.14-32.

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Drive			CLIENT: Matthew Chamberlain		
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# Glazina NCC H1D8

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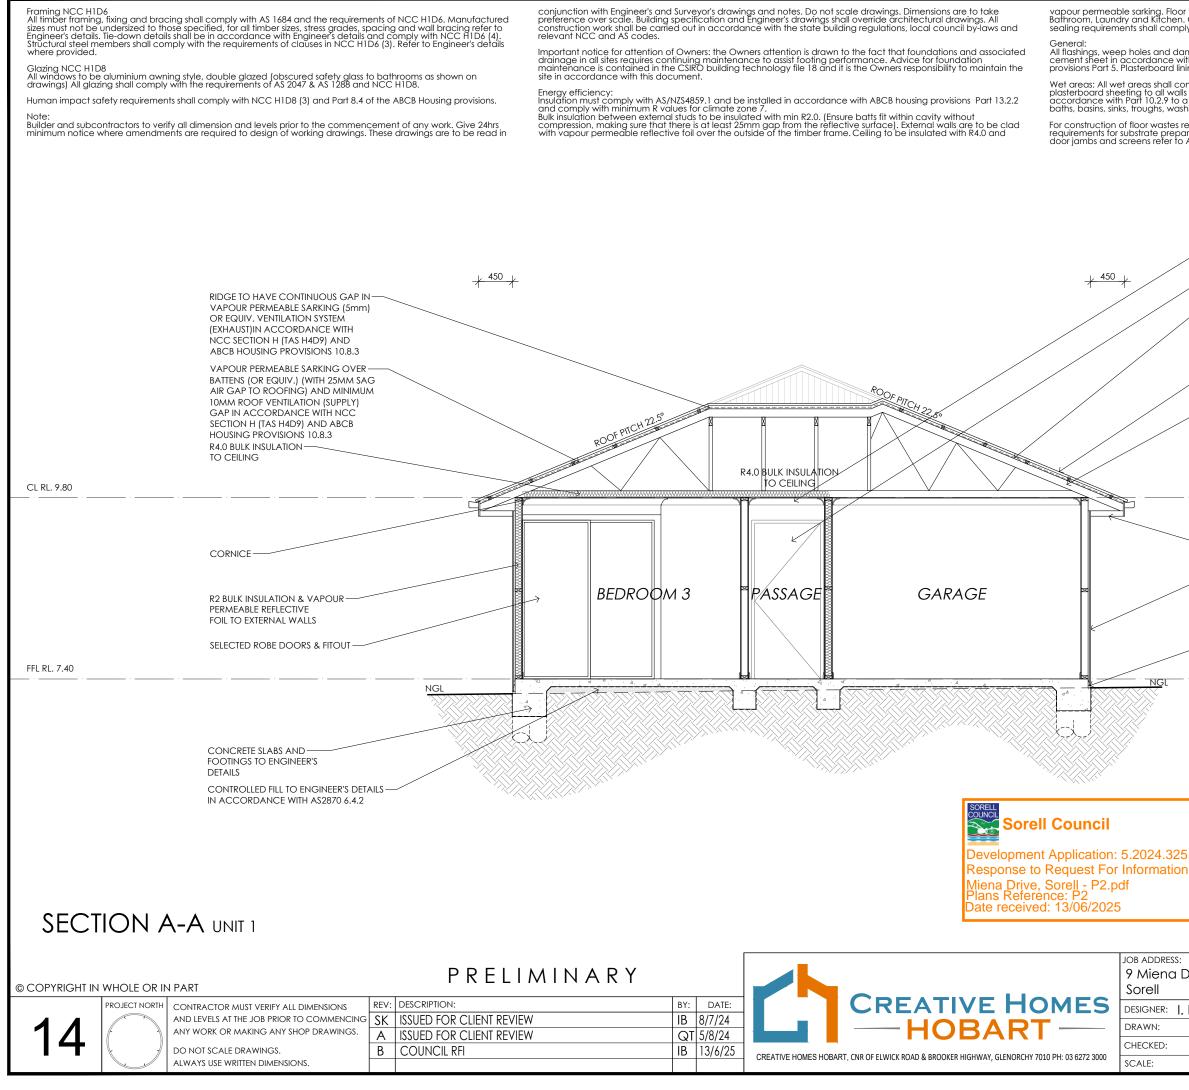
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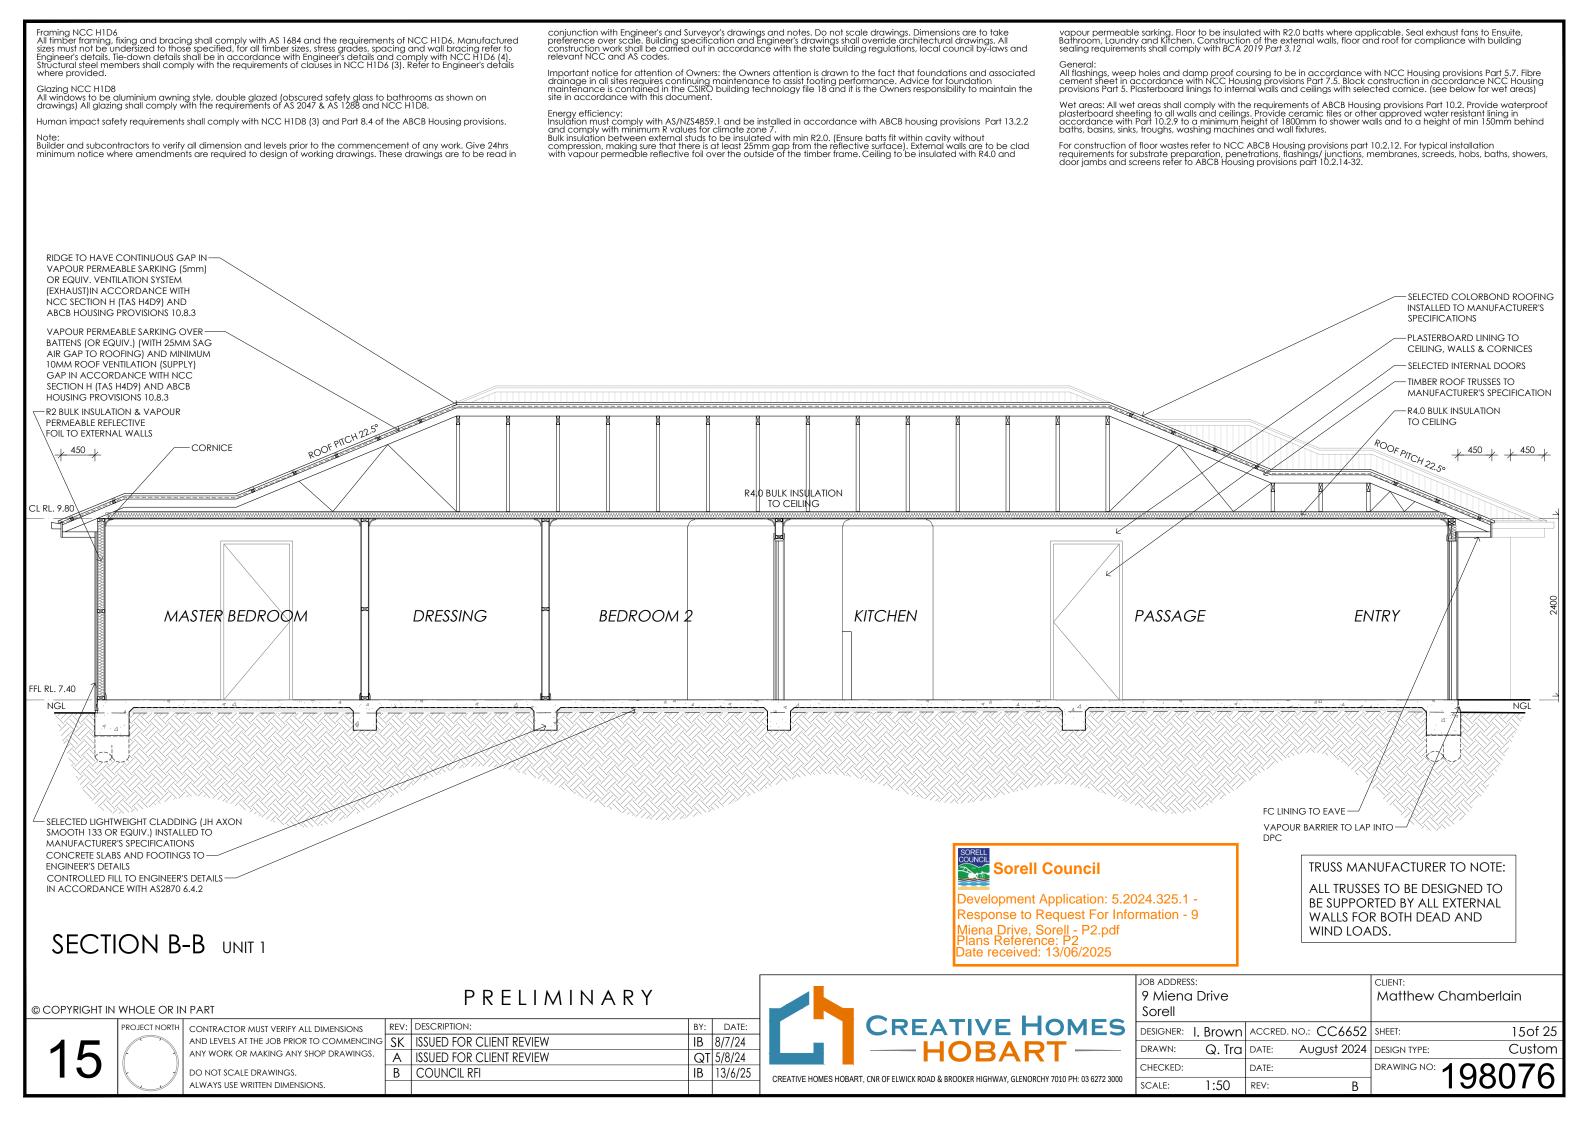
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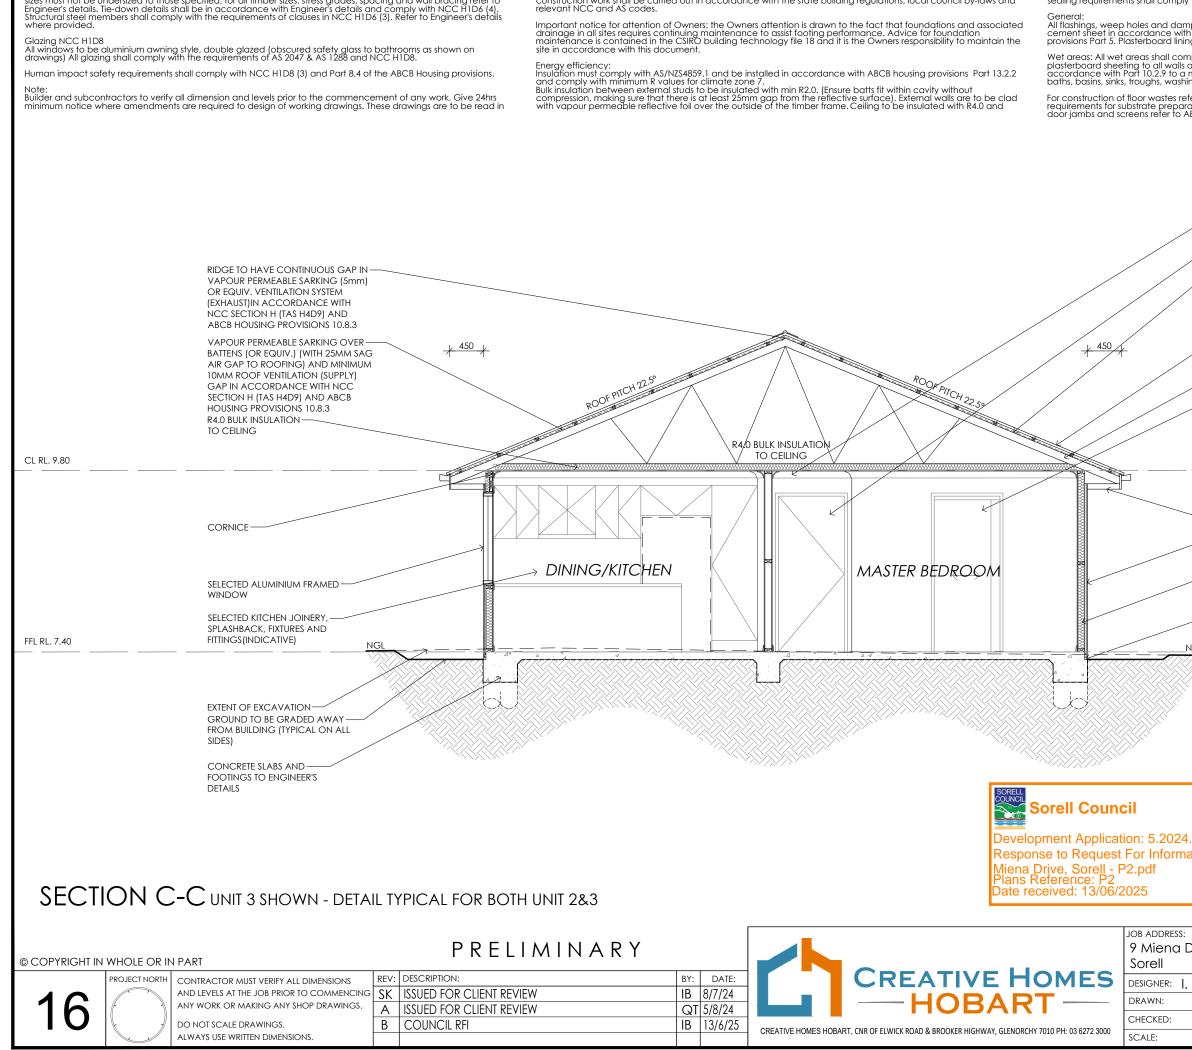
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Drive			Matthew C	Chamberla	iin
. Brown	ACCRED. NO.	CC6652	SHEET:		14of 25
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Framing NCC H1D6 All timber framing, fixing and bracing shall comply with AS 1684 and the requirements of NCC H1D6. Manufactured sizes must not be undersized to those specified, for all timber sizes, stress grades, spacing and wall bracing refer to Engineer's details. Tie-down details shall be in accordance with Engineer's details and comply with NCC H1D6 (4). Structural steel members shall comply with the requirements of clauses in NCC H1D6 (3). Refer to Engineer's details

conjunction with Engineer's and Surveyor's drawings and notes. Do not scale drawings. Dimensions are to take preference over scale. Building specification and Engineer's drawings shall override architectural drawings. All construction work shall be carried out in accordance with the state building regulations, local council by-laws and relevant NCC and AS codes.


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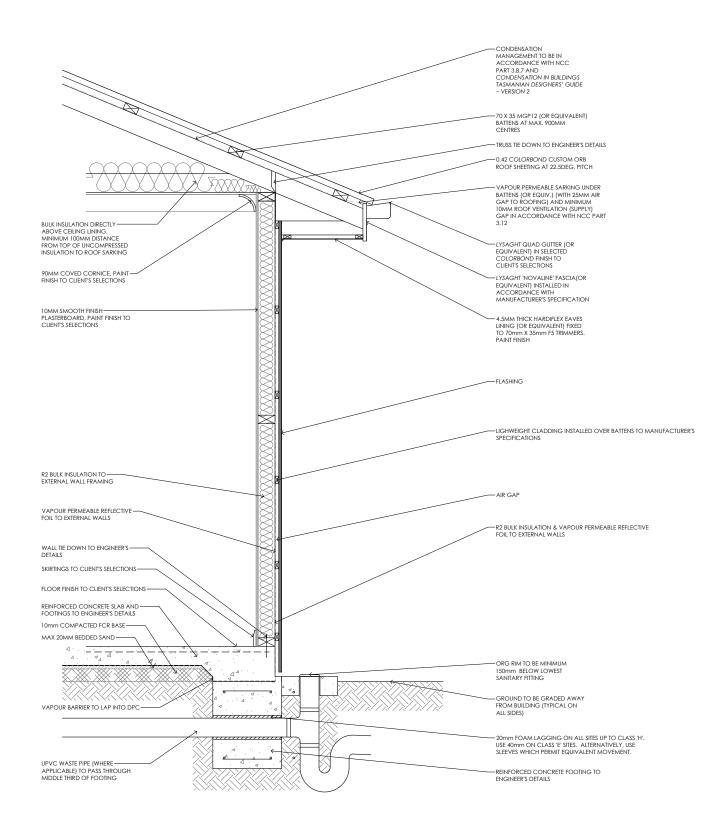
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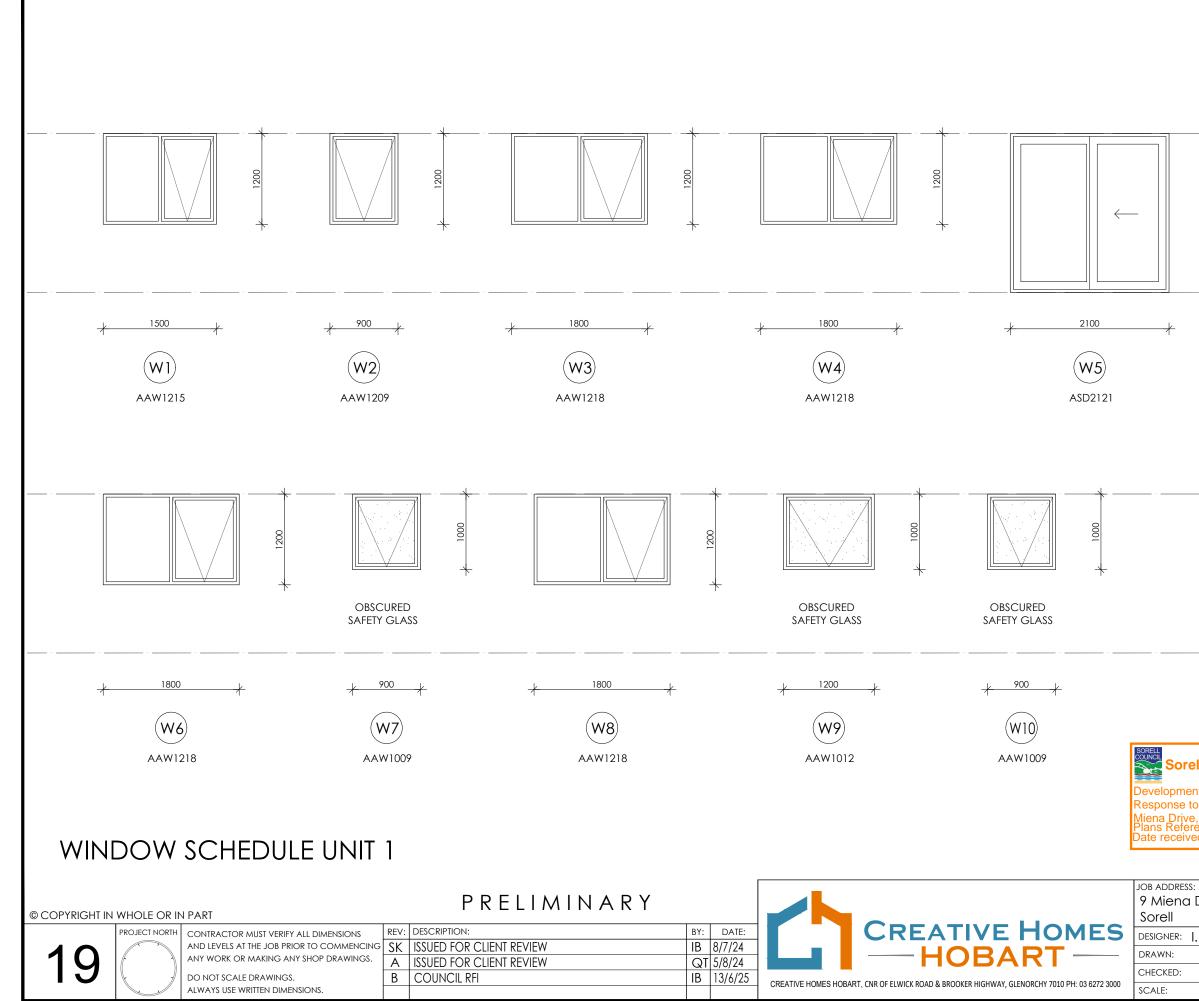
FLOOR, WALL & ROOF DETAIL SCALE 1:20

# TYPICAL SECTION DETAILS

© C	OPYRIGHT IN	WHOLE OR IN PART	PRELIMINARY				JOB ADDRES 9 Mieno Sorell			CLIENT: Matthew C	Chamberlain
	10	PROJECT NORTH AND LEVELS AT THE JOB PRIOR TO COMMENCING ANY WORK OR MAKING ANY SHOP DRAWINGS.	REV: DESCRIPTION: SK ISSUED FOR CLIENT REVIEW A ISSUED FOR CLIENT REVIEW	BY: DATE: IB 8/7/24 QT 5/8/24		CREATIVE HOMES	DESIGNER: DRAWN:	I. Brown ACCRED. Q. Tra DATE:	NO.: CC6652 August 2024		18of 25 Custom
	10	DO NOT SCALE DRAWINGS. ALWAYS USE WRITTEN DIMENSIONS.	B COUNCIL RFI	IB 13/6/25	CREATIVE HOMES HO	BART, CNR OF ELWICK ROAD & BROOKER HIGHWAY, GLENORCHY 7010 PH: 03 6272 3000	CHECKED: SCALE: AS	DATE: SHOWN REV:	В	DRAWING NO:	198076

# Sorell Council

Development Application: 5.2024.325.1 -Response to Request For Information - 9 Miena Drive, Sorell - P2.pdf Plans Reference: P2 Date received: 13/06/2025

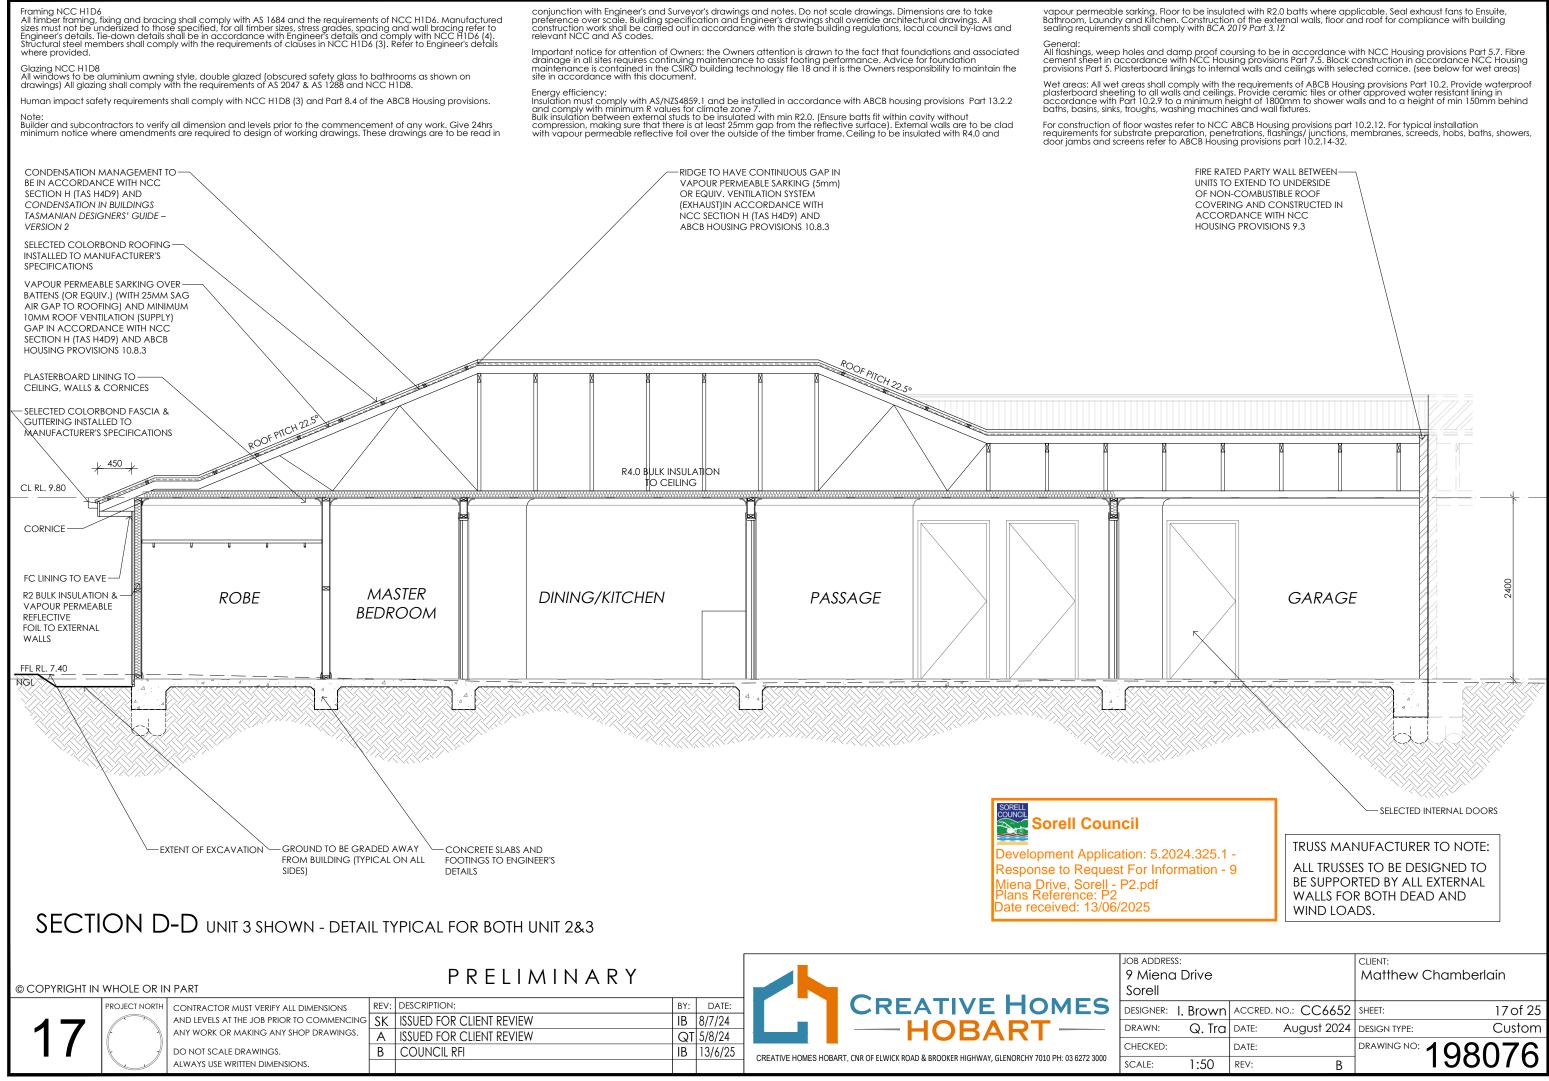

# Sorell Council

evelopment Application: 5.2024.325.1 -Response to Request For Information - 9 Miena Drive, Sorell - P2.pdf Plans Reference: P2 Date received: 13/06/2025

fg FIXED GLAZING

Framing NCC H1D6 All timber framing, fixing and bracing shall comply with AS 1684 and the requirements of NCC H1D6. Manufactured sizes must not be undersized to those specified, for all timber sizes stress grades practing and timber sizes, stress grades, spacing and wall bracing refer to Engineer's details. Tie-down details shall be in accordance with Engineer's details and comply with NCC H1D6 (4). Structural steel members shall comply with the requirements of clauses in NCC H1D6 (3). Refer to Engineer's details where provided Engineer's details where provided.

Glazing NCC H1D8 All windows to be aluminium awning style, double glazed (obscured safety glass to bathrooms as shown on drawings) All glazing shall comply with the requirements of AS 2047 & AS 1288 and NCC H1D8.

Human impact safety requirements shall comply with NCC H1D8 (3) and Part 8.4 of the ABCB Housing provisions.

Builder and subcontractors to verify all Builder and subcontractors to verify all dimension and levels prior to the commencement of any work. Give 24hrs minimum notice where amendments are required to design of working drawings. These drawings are to be read in conjunction with Engineer's and Surveyor's drawings and notes. Do not scale drawings. Dimensions are to take preference over scale. Building specification and Engineer's drawings shall override architectural drawings. All construction work shall be carried out in accordance with the state building regulations, local council by-laws and relevant NCC and AS codes.

Important notice for attention of Owners the Owners attention is drawn to the fac that foundations and associated drainage in all sites requires continuing maintenance to assist footing performance. Advice for foundation maintenance is contained in the CSIRO building technology file 18 and it is the Owners responsibility to maintain the site in accordance with this document.

in accordance with this document. Energy efficiency: Insulation must comply with AS/NZS4859.1 and be installed in accordance with ABCB housing provisions Part 13.2.2 and comply with minimum R values for climate zone 7. Bulk insulation between external studs to be insulated with min R2.0. (Ensure batts fit within cavity without compression, making sure that there is at least 25mm gap from the reflective surface). External walls are to be clad with vapour permeable reflective foil over the outside of the timber frame. Ceiling to be insulated with R4.0 and vapour permeable Floor to be insulated with Min R1.7 batts where applicable. Seal exhaust fans to Ensuite, Bathroom, Laundry and Kitchen. All downlights to be IC rated. Construction of the external walls, floor and roof for compliance with building sealing requirements shall comply with BCA 2019 Part 3.12 General:


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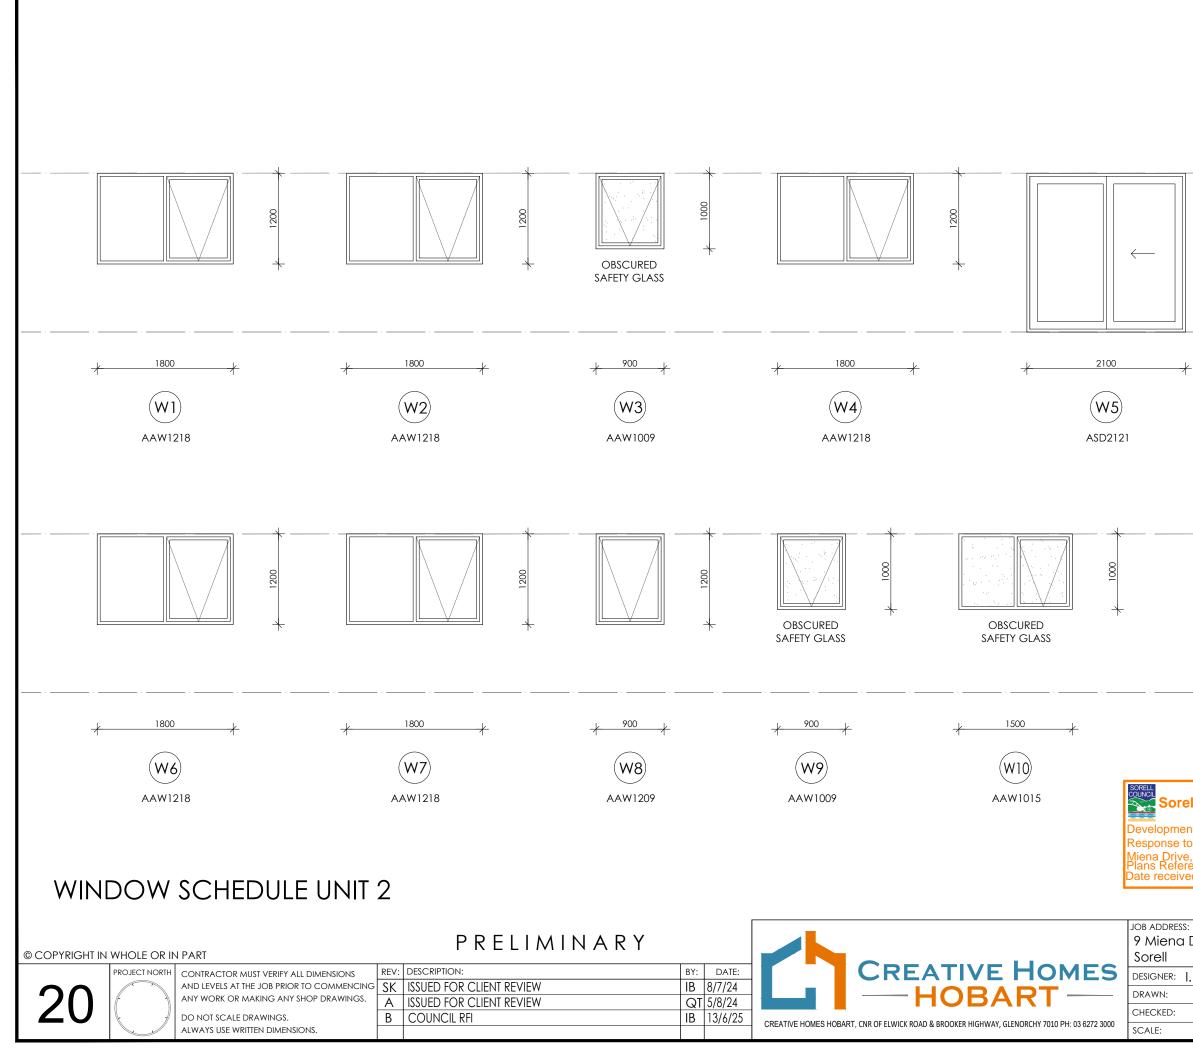
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Drive			CLIENT: Matthew Cho	amberlain
. Brown	ACCRED.	NO.: CC6652	SHEET:	19 of 25
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# Sorell Council

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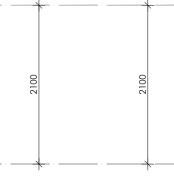
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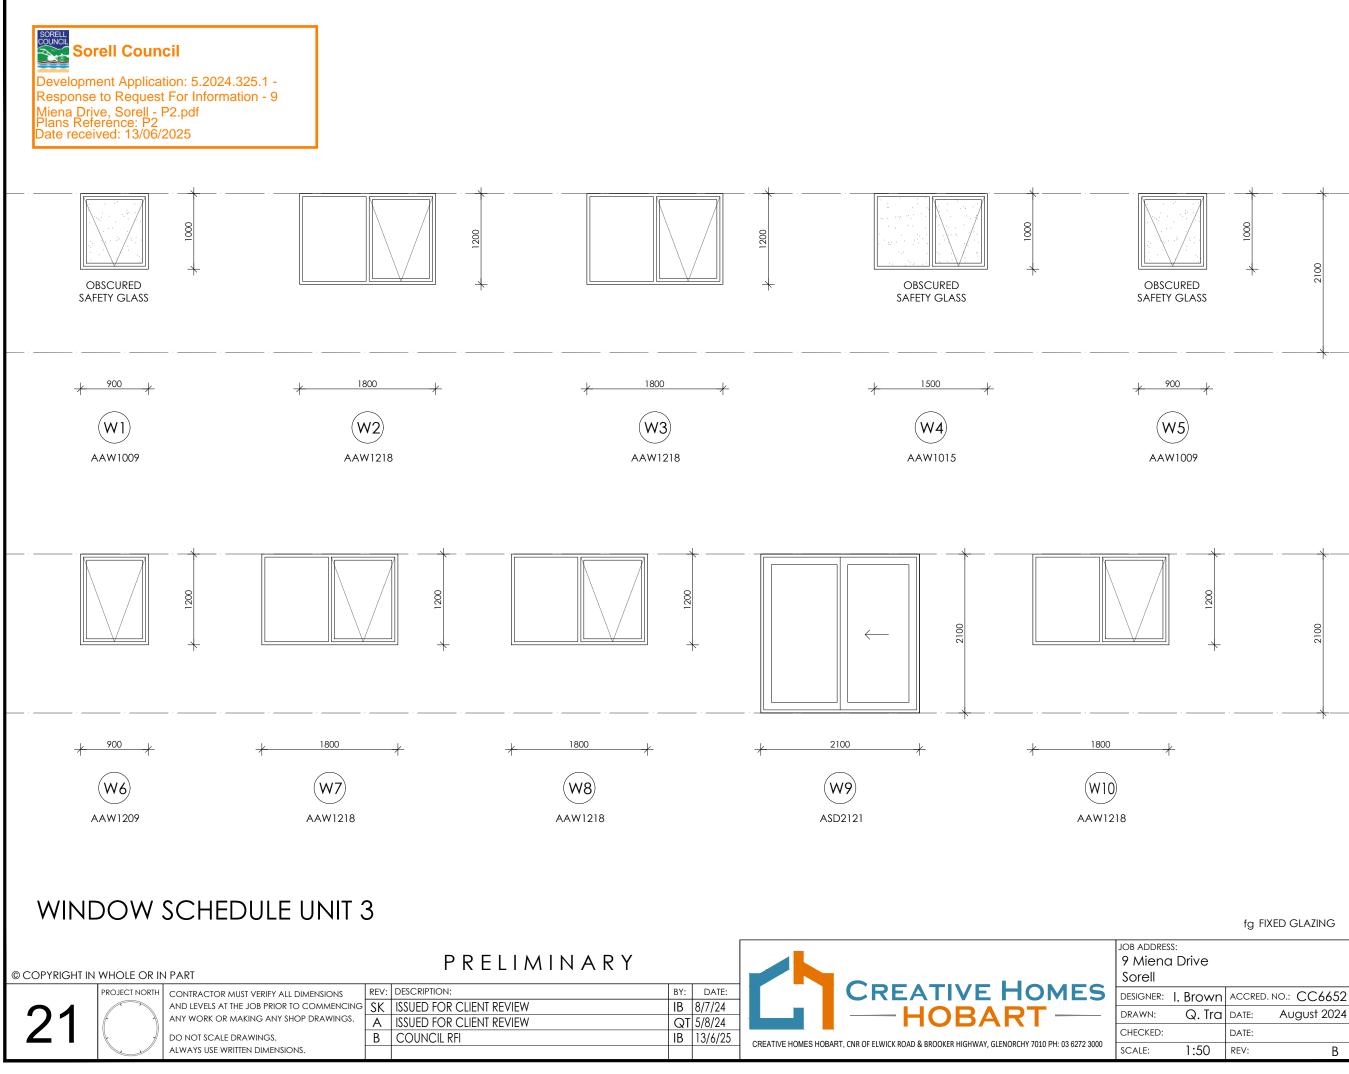
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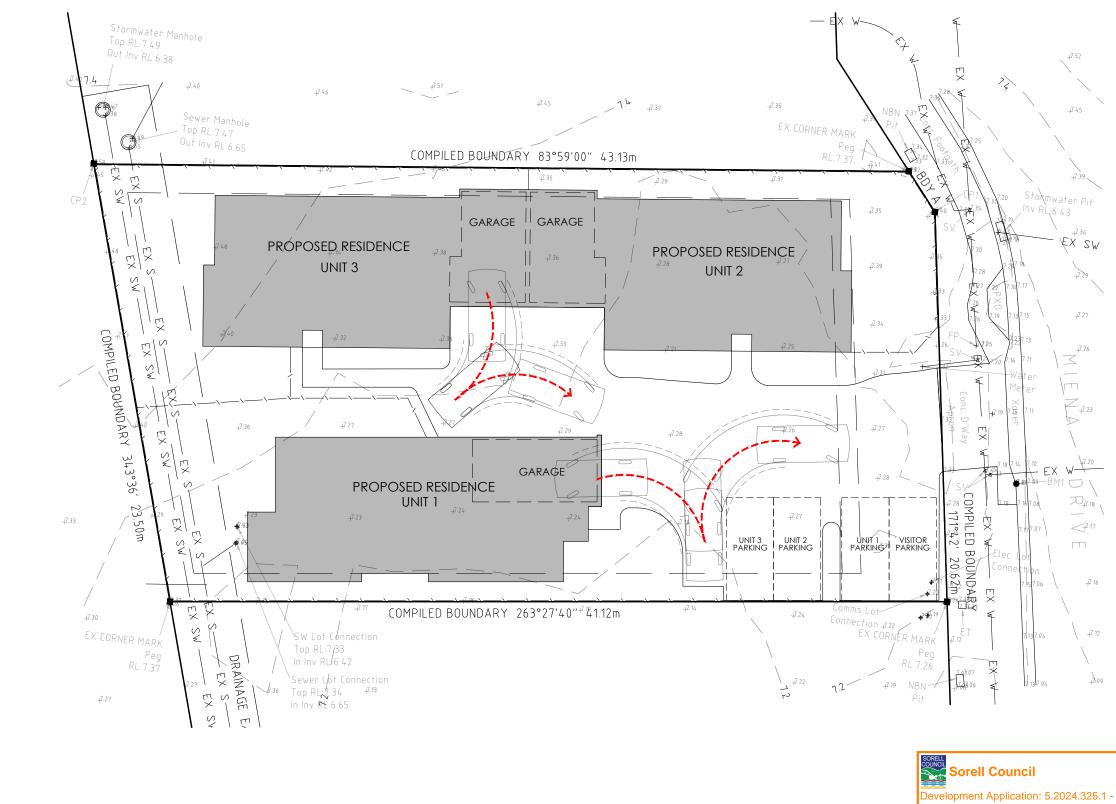
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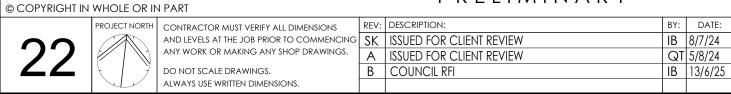
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Drive			CLIENT: Matthew Chamberlain		
. Brown	ACCRED.	NO.: CC6652	SHEET:	21of 25	
Q. Tra	DATE:	August 2024		Custom	
	DATE:		DRAWING NO:	98076	
1:50	REV:	В		90070	



# PROPOSED TURNING PATHS UNIT 1 AND 3 GARAGE EXIT PATH

PRELIMINARY

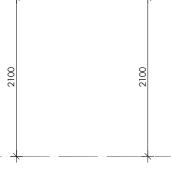




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I. Brown	ACCREE	D. NO.: CC6652	SHEET:	22 of 25	
Q. Tra	DATE:	August 2024		Custom	
	DATE:		DRAWING NO: 🖌	98076	
1:200	REV:	В		90070	

Miena Drive, Sorell - P2.pdf Plans Reference: P2 Date received: 13/06/2025				NOTE: ALL TURNING PATHS HAVE BEEN CALCULATED FOR A 885 VEHICLE IN ACCORDANCE WITH AS2890.1			
JOB ADDRES 9 Mienc Sorell				CLIENT: Matthew Chamberlain			
DESIGNER:	I. Brown	ACCRED	NO.: CC6652	SHEET:	22 of 25		
DRAWN:	Q. Tra	DATE:	August 2024	DESIGN TYPE:	Custom		
CHECKED:		DATE:		DRAWING NO:	98076		
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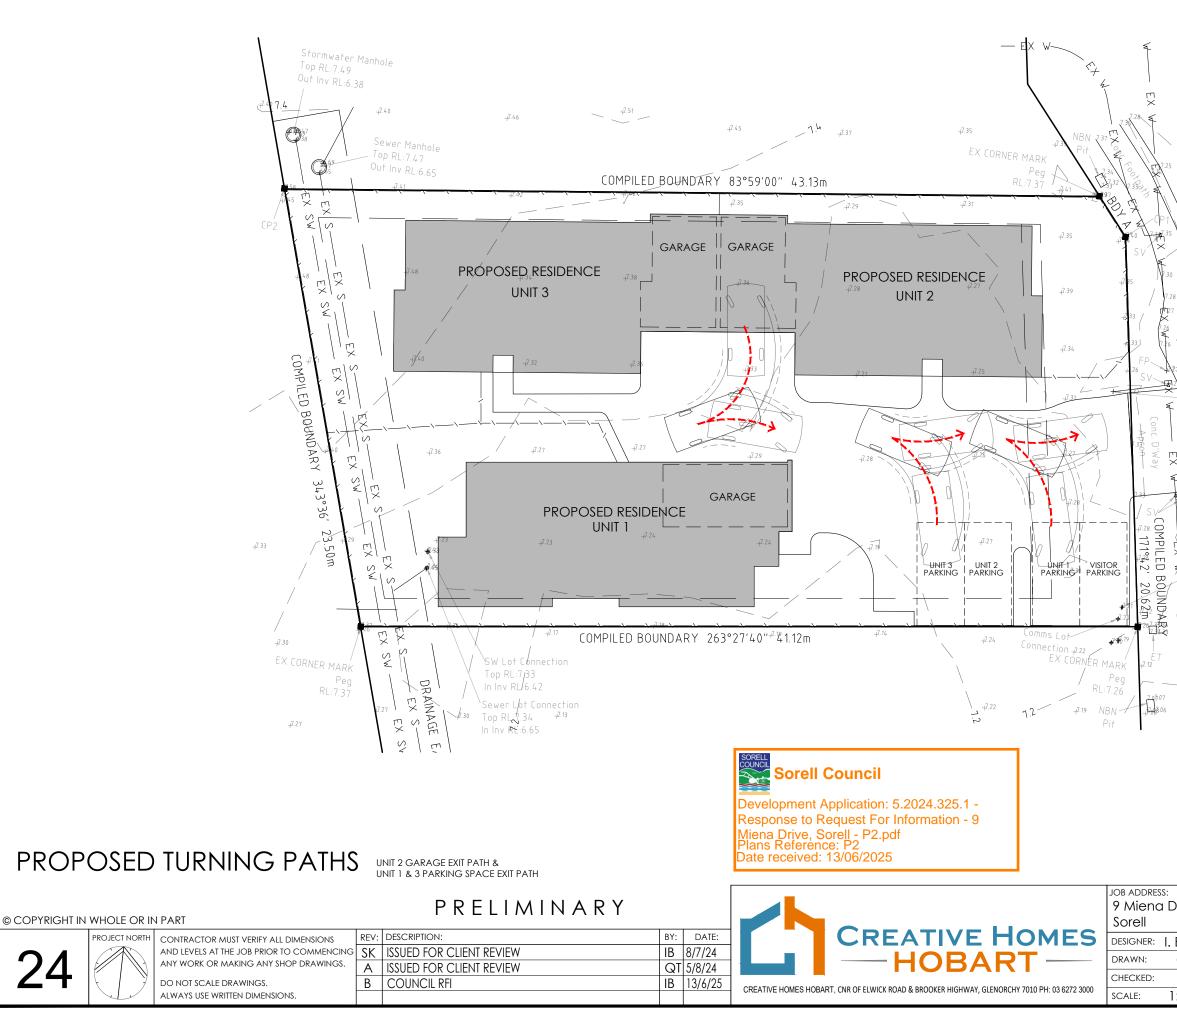
Response to Request For Information - 9

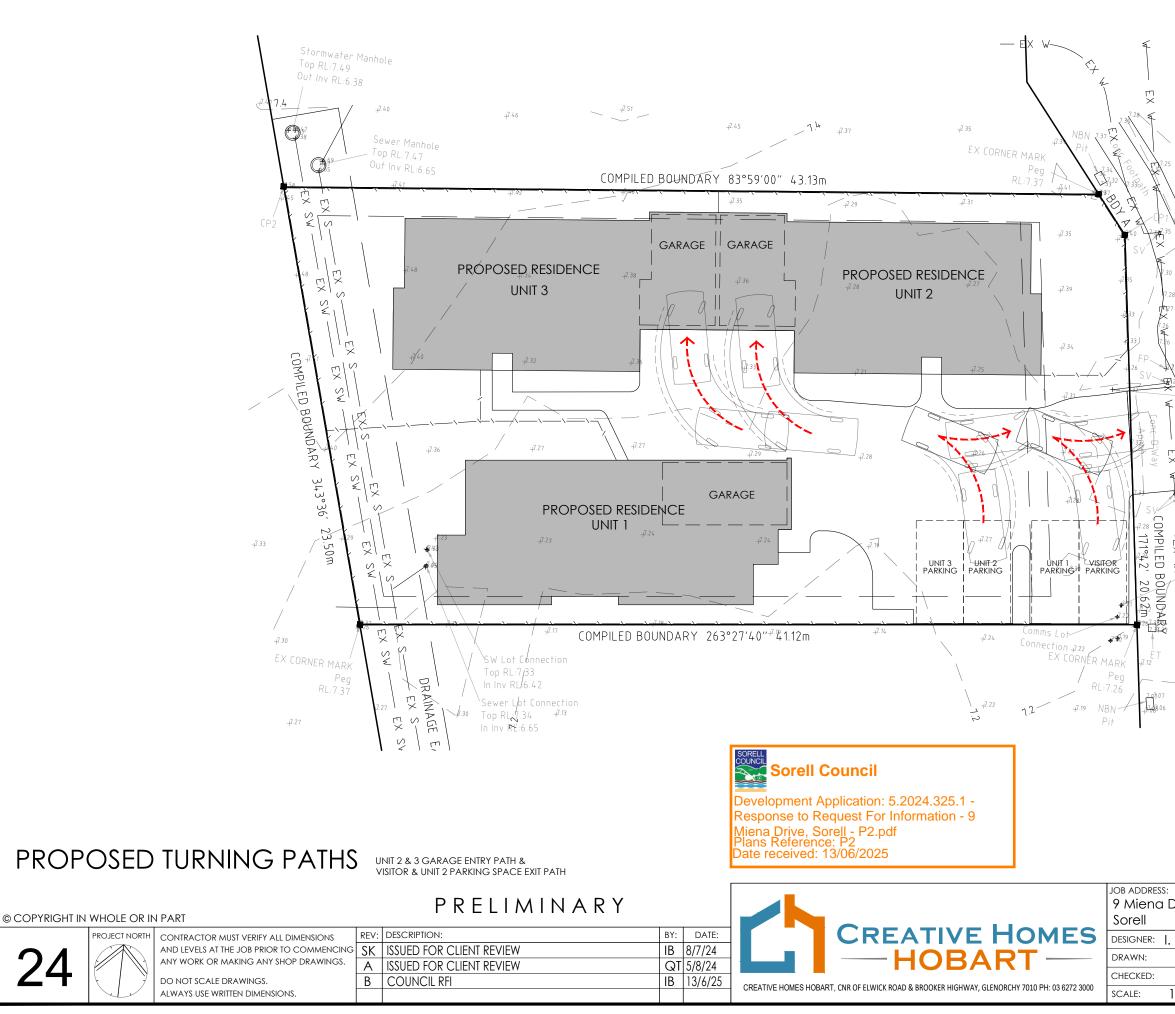

: Drive			CLIENT: Matthew Cl	hamberlain
. Brown	ACCRED	. NO.: CC6652	SHEET:	24 of 25
Q. Tra	DATE:	August 2024	DESIGN TYPE:	Custom
	DATE:		DRAWING NO:	98076
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NOTE: ALL TURNING PATHS HAVE BEEN CALCULATED FOR A 885 VEHICLE IN ACCORDANCE WITH AS2890.1






: Drive			CLIENT: Matthew Ch	namberlain
. Brown	ACCRED	. NO.: CC6652	SHEET:	24 of 25
Q. Tra	DATE:	August 2024	DESIGN TYPE:	Custom
	DATE:		DRAWING NO:	98076
1:200	REV:	В		90070

NOTE: ALL TURNING PATHS HAVE BEEN CALCULATED FOR A B85 VEHICLE IN ACCORDANCE WITH AS2890.1



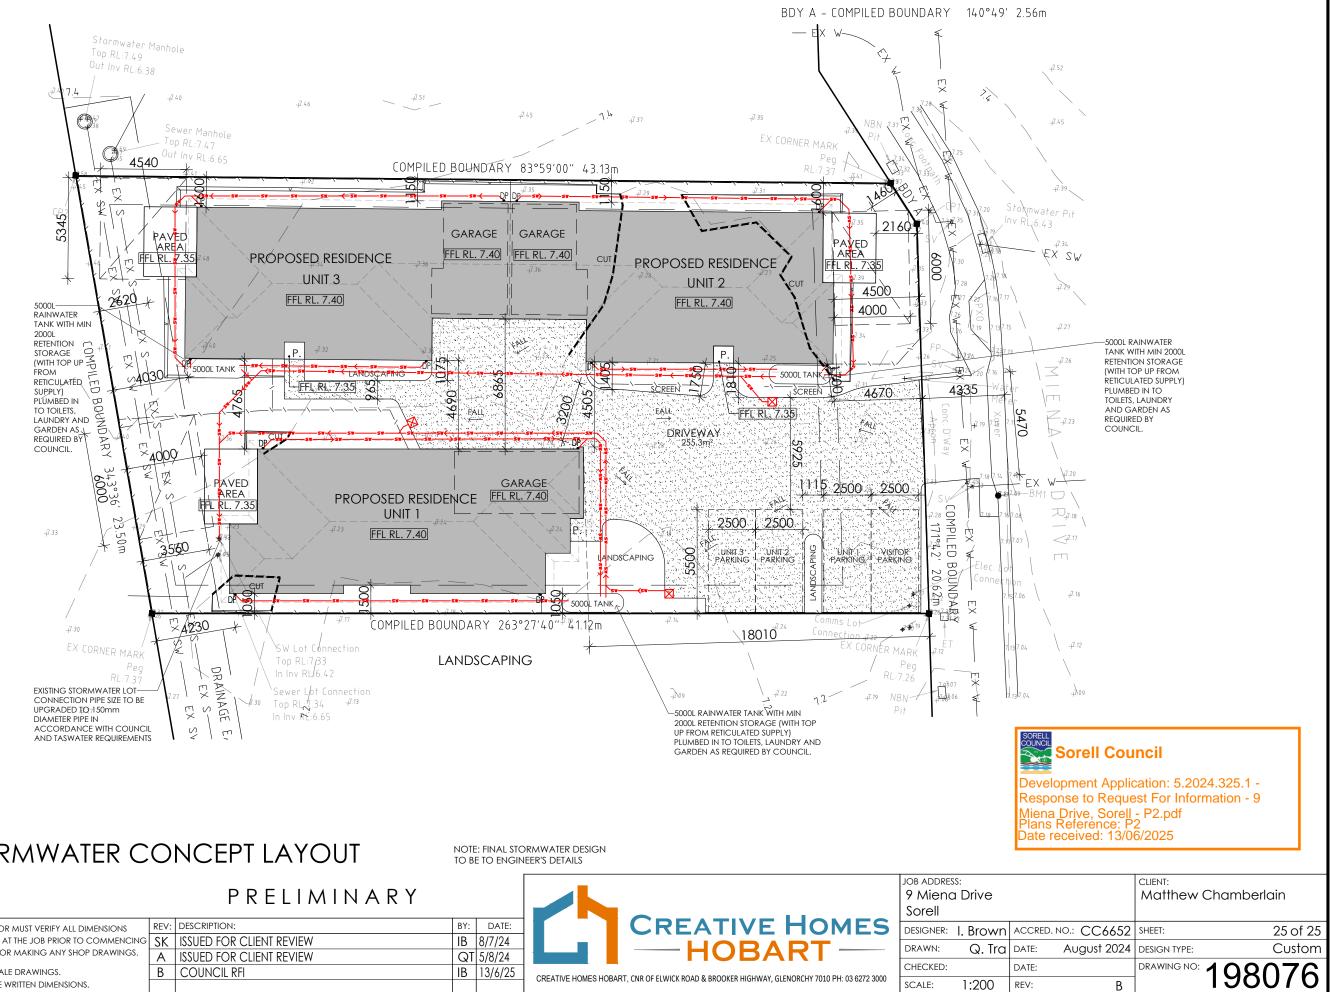

# PROPOSED STORMWATER CONCEPT LAYOUT

# SCALE:

# © COPYRIGHT IN WHOLE OR IN PART

25	PROJECT NORTH		REV:	DESCRIPTION:	BY:	DATE:		
			SK	ISSUED FOR CLIENT REVIEW	IB	8/7/24		
			А	ISSUED FOR CLIENT REVIEW	QT	5/8/24		
		do not scale drawings. Always use written dimensions.	В	COUNCIL RFI	IB	13/6/25		