

NOTICE OF PROPOSED DEVELOPMENT

Notice is hereby given that an application has been made for planning approval for the following development:

SITE: 2 Rowan Avenue, Primrose Sands

PROPOSED DEVELOPMENT:

DWELLING (RETROSPECTIVE)

The relevant plans and documents can be inspected at the Council Offices at 47 Cole Street, Sorell during normal office hours, or the plans may be viewed on Council's website at www.sorell.tas.gov.au until Monday 7th July 2025.

Any person may make representation in relation to the proposal by letter or electronic mail (sorell.council@sorell.tas.gov.au) addressed to the General Manager. Representations must be received no later than **Monday 7th July 2025**

APPLICANT: 20 TWENTY PROPERTY DEVELOPMENTS

APPLICATION NO: DA 2024 / 00175 1

DATE: 19 June 2025

Part B: Please note that Part B of this form is publicly exhibited.

Full description of Proposal:	Use:			
- · · · · · · · · · · · · · · · · · · ·	Development:			
	Large or complex proposals s	hould be	e described	in a letter or planning report.
Design and cons	truction cost of proposal:		\$	
Is all, or some th	e work already constructed:		No: □	Yes: □
Location of proposed	Street address:			
works:				code:
	Certificate of Title(s) Volum	ıe:		Folio:
Current Use of Site				
Current Owner/s: Name(s)				
Is the Property of Register?	on the Tasmanian Heritage	No: □	Yes: □	If yes, please provide written advice from Heritage Tasmania
Is the proposal than one stage?	o be carried out in more	No: □	Yes: □	If yes, please clearly describe in plans
Have any potentially contaminating uses been undertaken on the site?		No: □	Yes: □	If yes, please complete the Additional Information for Non-Residential Use
Is any vegetation proposed to be removed?		No: □	Yes: □	If yes, please ensure plans clearly show area to be impacted
Does the proposal involve land administered or owned by either the Crown or Council?			Yes: □	If yes, please complete the Council or Crown land section on page 3
If a new or upgraded vehicular crossing is required from Council to the front boundary please				
•	hicular Crossing (and Associa			cation form
nttps://www.sor	ell.tas.gov.au/services/engir	<u>ieering/</u>		Sorell Council


Development Application:5.2024.175.1 -Response to Request for information -P3.pdf Plan Reference:P3 Date received:25/11/2024

CERTIFICATE OF TITLE

LAND TITLES ACT 1990



TASMANIA

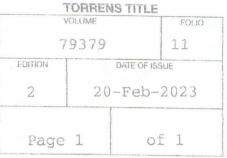

I certify that the person described in Schedule 1 is the registered proprietor of an estate in fee simple (or such other estate or interest as is set forth in that Schedule) in the land within described subject to such exceptions, encumbrances, interests and entries specified in Schedule 2 and to any additional entries in the Folio of the Register.



Recorder of Titles



42 A.

A ATA

DESCRIPTION OF LAND

Parish of CARLTON, Land District of PEMBROKE Lot 11 on Diagram 79379 (formerly being 454-13D) Derivation: Part of Lot 31145 (1072 Acres) Granted to E.J. Kennedy Prior CT 2023/90

SCHEDULE 1

M991246 TRANSFER to CRAIG EDWARD JOHNSTON Registered 20-Feb-2023 at 12.02 PM

SCHEDULE 2

Reservations and conditions in the Crown Grant if any
A222526 BENEFITING EASEMENT: Right of carriageway over the
piece of land containing 16 perches shown on Diagram
No. 82024 created by Order

A222526 BENEFITING EASEMENT: Right of drainage over the
Drainage Easement shown passing through Lot 14
(marked D.C.) on Diagram No. 79379 created by Order

A222526 BURDENING EASEMENT: Right of drainage (appurtenant to
Lots 7-10 on Diagram No. 79379) over the Drainage
Easement shown passing through the said land within

described created by Order A222526 FENCING COVENANT created by Order



Development Application: Devvelopment Application - 2 Rowan Avenue, Primrose Sands -P1.pdf Plans Reference:P1 Date Received:25/07/2024



. lans Reference:P1 late Received:25/07/2024


Shangarai 2 9 F and

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BUILDER TO VERIFY ALL DIMENSIONS PRIOR TO COMMENCING
CONSTRUCTION. NOTIFY DESIGNER OF ANY DISCREPANCIES
BEFORE PROCEEDING DRAWINGS SHALL NOT BE USED FOR
CONSTRUCTION PURPOSES UNTIL ISSUED FOR CONSTRUCTION.

* NB

Ccrouch NOT in Requested Item by Council.


Bed plates 90 x 35?? Studs 90x45 pine. Noggins 90x45 Pine Flooring Yellow Tounge Floor

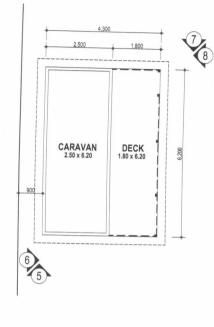

studs uso & window 250 x 45. Headers.

Heights as per Plans

Floor Joists as per engineers drowings Rofters etc es per engineers drowing.

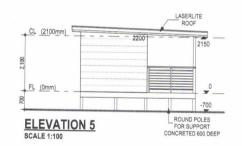




ELEVATION 6

Sorell Council

Development Application: Devvelopment
Application - 2 Rowan Avenue, Primrose Sands -

Plans Reference:P1
Date Received:25/07/2024

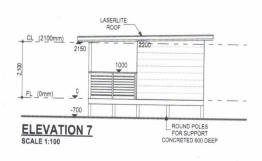

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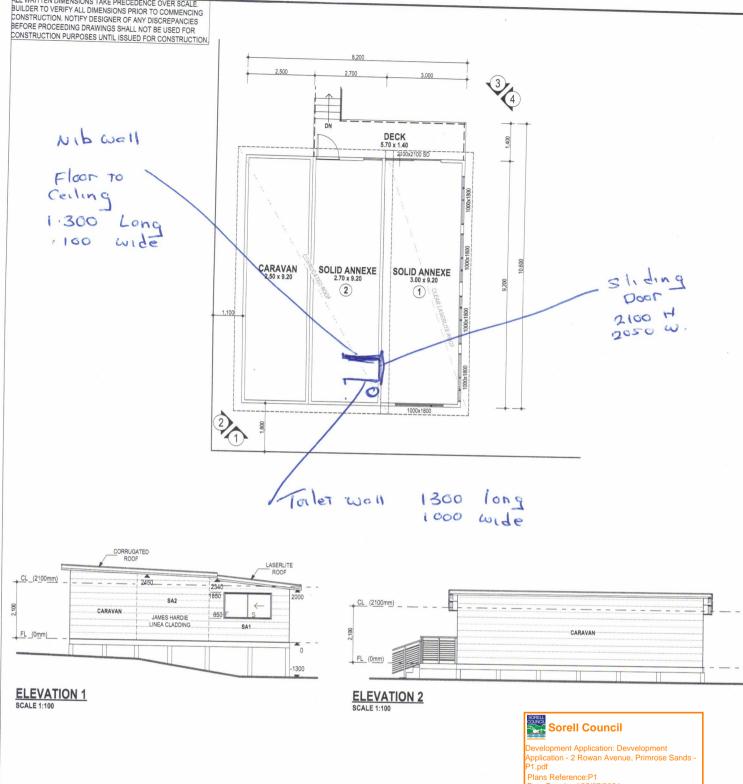
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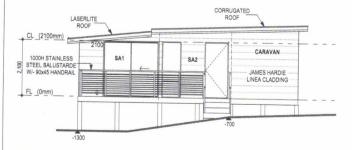
PROPOSED ALTERATION & ADDITION FOR
CRAIG & VIKKI JOHNSTON

ADDRESS
2 ROWAN AVENUE, PRIMROSE
SANDS

Rev.	Amendment	Drawn	Date	CARAVAN 1	
Α	ISSUED FOR DISCUSSION	VN-ARC	14-03-23	SCALE:	1:100, 1:4.24
				DRAWN:	VN-ARC
				CHECKED:	
				DWG NO :	2 OF 3



Plans Reference:P1 Date Received:25/07/2024



ELEVATION 4

CL (2100mm)

FL (0mm)

2,100

	Area m²	Perimeter m
1. CARAVAN 1	15.500	17,400
2. DECK 1	11.160	16.000
3. CARAVAN 2	75.440	34.800
4. DECK 2	7.982	14.204

1850

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ELEVATION 3 SCALE 1:100

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PROPOSED ALTERATION & ADDITION FOR
CRAIG & VIKKI JOHNSTON

ı	ADDRESS
	2 ROWAN AVENUE, PRIMROSE
	SANDS

Rev.	Amendment	Drawn	Date	CARAVAN 2		1000
Α	ISSUED FOR DISCUSSION	VN-ARC	14-03-23	SCALE:	1:1, 1:100	-
				DRAWN:	VN-ARC	-
				CHECKED:		-
				DWG NO :	3 OF 3	

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2 ROWAN AVENUE, PRIMROSE SANDS PROPOSED ALTERATION & ADDITION FOR: CRAIG & VIKKI JOHNSTON

1:200, 1:1

VN-ARC

DWG NO: CHECKED: DRAWN: SCALE:


1 OF 3

1. CARAVAN 1 2. DECK 1 3. CARAVAN 2 4. DECK 2

X GUTTET Downpipe Tonks

over Flow Graw Tonks Corrently go to westewater (pro posing to send to food when drains are complete.

or into Netural Easment water Flow.

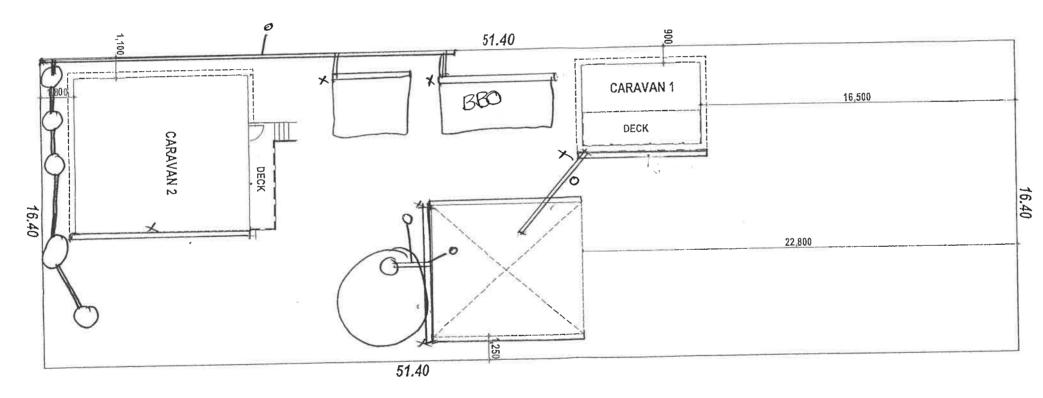

Sorell Council

Development Application: Advertising Documents
- 2 Rowan Avenue, Primrose Sands -5.2024.175.1.pdf

Plans Reference:P4 Date Received: 20/06/2025 ROWAN AVENUE

WRITTEN DIMENSIONS TAKE PRECEDENCE OVER SCALE.
DER TO VERIFY ALL DIMENSIONS PRIOR TO COMMENCING
STRUCTION. NOTIFY DESIGNER OF ANY DISCREPANCIES
DRE PROCEEDING DRAWINGS SHALL NOT BE USED FOR
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Points 4+5


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SUPPORT - BIM - SERVICES

ADDRESS
2 ROWAN AVENUE, PRIMROSE
SANDS PROPOSED ALTERATION & ADDITION FOR: CRAIG & VIKKI JOHNSTON

1. CARAVAN 1 2. DECK 1 3. CARAVAN 2 4. DECK 2 DWG NO: DRAWN: 1 OF 3 VN-ARC meter m 17.400 16,000 34.800 14.204



Sorell Council

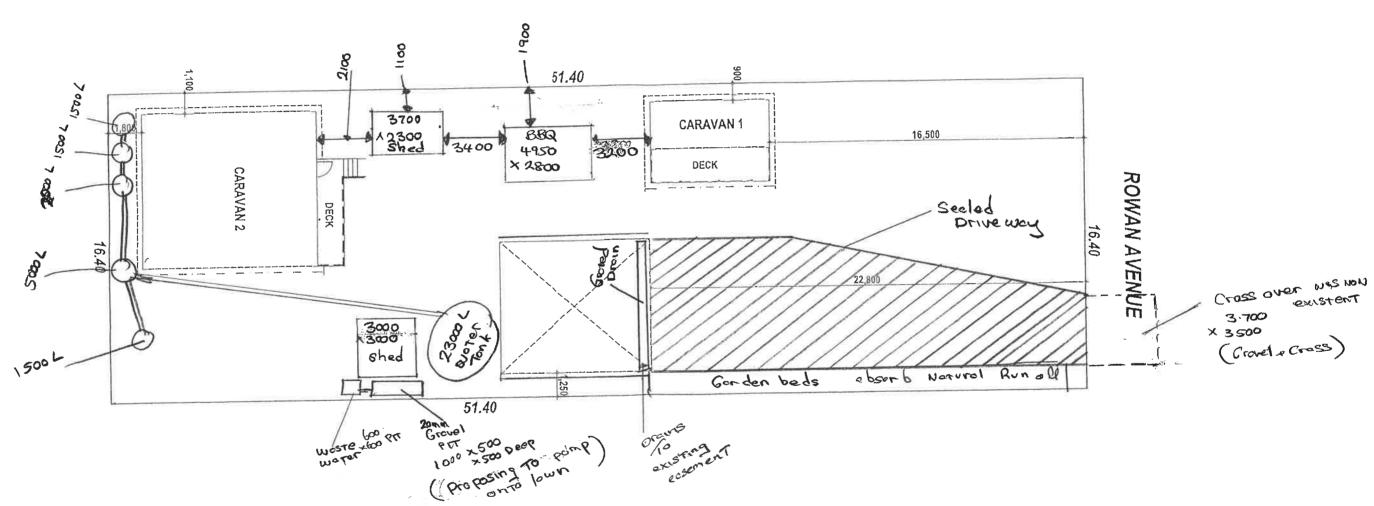- 2 Rowan Avenue, Primrose Sands

-5.2024.175.1.pdf Plans Reference:P4 Date Received: 20/06/2025

Development Application: Advertising Documents

· You take the son!

Site Plan

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ADDRESS 2 ROWAN AVENUE, PRIMROSE SANDS PROPOSED ALTERATION & ADDITION FOR: CRAIG & VIKKI JOHNSTON

1. CARAVAN 1 2. DECK 1 3. CARAVAN 2 4. DECK 2 DWG NO: DRAWN: VN-ARC 1 OF 3

51.40 **CARAVAN 1** 1,800 16,500 DECK CARAVAN 2 DECK 16.40 22,800 Gorden Bed 51.40


ROWAN AVENUE

Sorell Council

Development Application: Advertising Documents - 2 Rowan Avenue, Primrose Sands -5.2024.175.1.pdf Plans Reference:P4 Date Received:20/06/2025

ALL WRITTEN DIMENSIONS TAKE PRECEDENCE OVER SCALE. BUILDER TO VERIFY ALL DIMENSIONS PRIOR TO COMMENCING CONSTRUCTION. NOTIFY DESIGNER OF ANY DISCREPANCIES BEFORE PROCEEDING DRAWINGS SHALL NOT BE USED FOR CONSTRUCTION PURPOSES UNTIL ISSUED FOR CONSTRUCTION.

ROWAN AVENUE

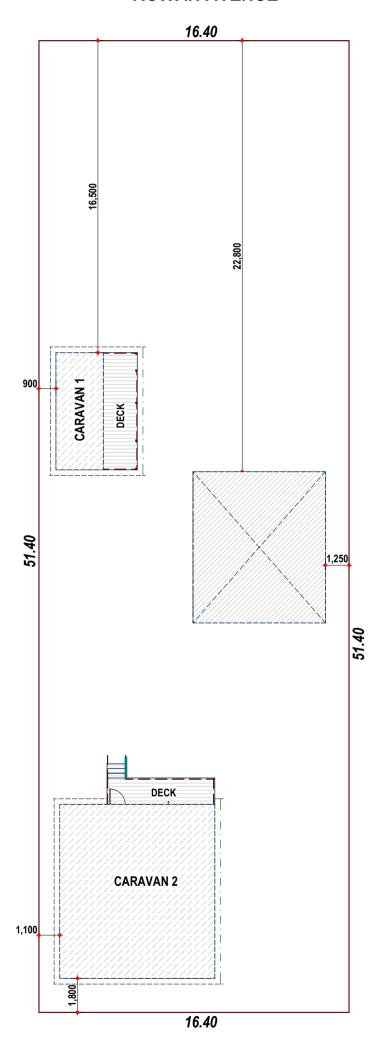



	Area m²	Perimeter m
1. CARAVAN 1	15.500	17.400
2. DECK 1	11.160	16.000
3. CARAVAN 2	75.440	34.800
4. DECK 2	7.982	14.204

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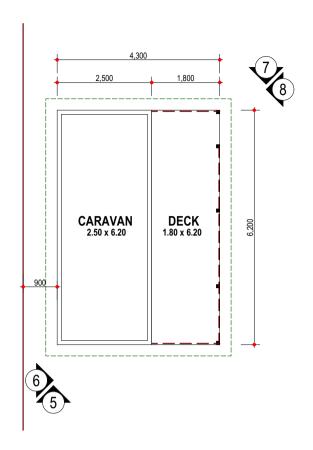
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CRAIG &	VIKKI	TOHNST	.UN


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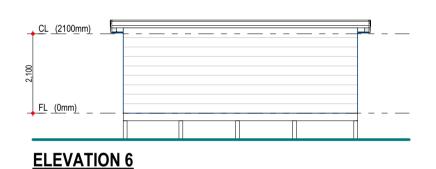
2 ROWAN AVENUE, PRIMROSE SANDS

1	Rev.	Amendment	Drawn	Date	SITE	E PLAN
	Α	ISSUED FOR DISCUSSION	VN-ARC	14-03-23	1:200	1:200
	В	ISSUED FOR CONSTRUCTION	VN-ARC	22-03-23	SCALE:	1.200
	С	RFI	VN-ARC	03-04-24	DRAWN:	VN-ARC
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					DWG NO :	1 OF 3
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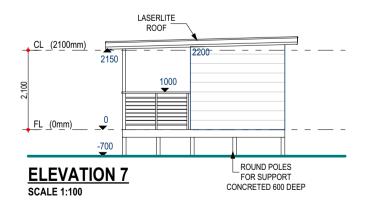
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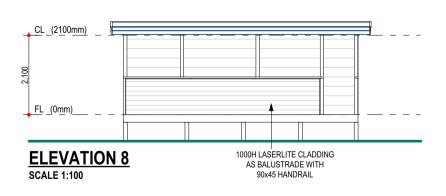






Sorell Council Development Application: Devvelopment Application - 2 Rowan Avenue, Primrose Sands -Plans Reference:P1 Date Received:25/07/2024

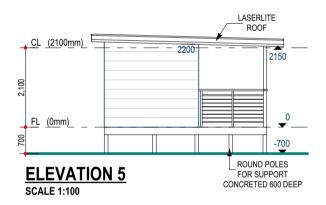



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PROPOSED ALTERATION & ADDITION FOR:
CRAIG & VIKKI JOHNSTON


SCALE 1:100


ADDRESS


ADDRESS	
2 ROWAN AVENUE, PRIMROSE	
SANDS	

Rev.	Amendment	Drawn	Date	CAR	AVAN 1	
Α	ISSUED FOR DISCUSSION	VN-ARC	14-03-23	CCALE.	1:100	
В	ISSUED FOR CONSTRUCTION	VN-ARC	22-03-23	SCALE:	1.100	
С	RFI	VN-ARC	03-04-24	DRAWN:	VN-ARC	
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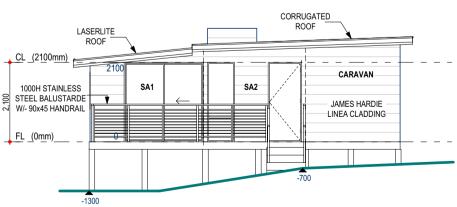




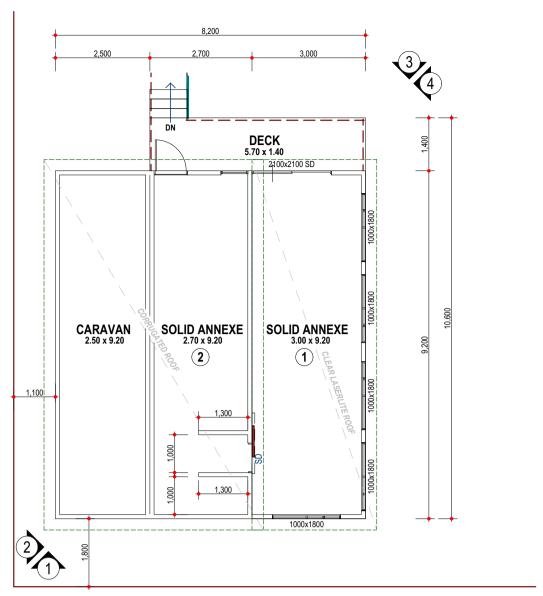


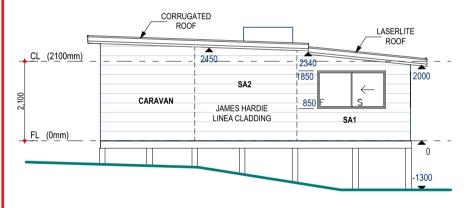ELEVATION 1 SCALE 1:100

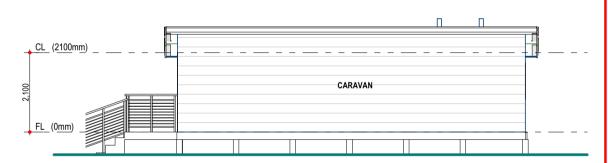ELEVATION 2 SCALE 1:100





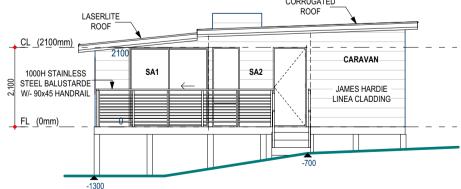



ELEVATION 3 SCALE 1:100

ELEVATION 4
SCALE 1:100

	Area m²	Perimeter m
1. CARAVAN 1	15.500	17.400
2. DECK 1	11.160	16.000
3. CARAVAN 2	75.440	34.800
4. DECK 2	7.982	14.204

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PROPOSED ALTERATION & ADDITION FOR:
CRAIG & VIKKL JOHNSTON

ADDRESS

2 ROWAN AVENUE, PRIMROSE SANDS

Rev.	Amendment	Drawn	Date	CAR	AVAN 2
Α	ISSUED FOR DISCUSSION	VN-ARC	14-03-23	CCALE.	1:100
В	ISSUED FOR CONSTRUCTION	VN-ARC	22-03-23	SCALE: 1:100	
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				DRAWN.	VN-ARC
				CHECKED:	
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				DWG NO :	3 OF 3
				55110.	3 05 3

AS CONSTRUCTED ALTERATIONS 2 ROWAN AVENUE,

PRIMROSE SANDS

ENGINEERING DRAWINGS

No	DRAWING
001	GENERAL NOTES
002	SMALL CARAVAN FOOTINGS & DECK FRAMING PLANS
003	SMALL CARAVAN ROOF FRAMING PLAN
101	LARGE CARAVAN FOOTINGS PLAN
102	LARGE CARAVAN GROUND FLOOR FRAMING PLAN
103	LARGE CARAVAN ROOF FRAMING PLAN
201	TIE DOWN NOTES

RELEVANT CODES USED

THE FOLLOWING AUSTRALIAN STANDARDS HAVE BEEN USED FOR ENGINEERING DESIGN:

- CONCRETE FOOTINGS IN ACCORDANCE WITH AS2870.
- CONCRETE DESIGNED IN ACCORDANCE WITH AS3600.
- WIND CLASSIFICATION IN ACCORDANCE WITH AS4055.
- STEEL IN ACCORDANCE WITH AS4100.
- TIMBER FRAMING IN ACCORDANCE WITH AS1684.
- TIMBER BRACING AND TIE DOWNS IN ACCORDANCE WITH AS1684.



Slawomir (Slawek) Misiun Civil/ Structural Engineer MIE Aust. 927148 Accredited Building Practitioner No. CC4102M



M: 0438 433 113

E: info@alphaconsulting.com.au W: alphaconsulting.com.au

C Alpha Consulting, 2005 All rights reserved.

GENERAL

- G1 All dimensions shown should be checked on site. Do not scale dimensions.
- These drawings to be read in conjunction with architectural drawings. Any discrepancies should be refered to the project manager, prior to proceeding with any work.
- G3 Builders responsibility to comply with all planning conditions.
- Refer to architectural drawings for all set downs.
- G5 No changes to design are allowed without engineer's approval.
- Founding to be inspected by building surveyor, engineer or Engineer's representative - refer to C.S.I.R.O. document for house maintenance.

EXCAVATION AND SITE PREPARATION

- The site is to be stripped of all vegetation and organic material prior to cutting or
- All trenches must be clean and free from all loose material
- F3 Bases of footings shall be horizontal U.N.O.
- * If trenching or other site work indicates the presence of foundation materials significantly different than those indicated on drawings, please notify this office as soon as possible.

CONCRETE

- Workmanship, materials and design shall be in accordance with AS 3600 and associated codes listed therein and the specification.
- Concrete shall be 25 MPa minimum unless noted otherwise, with 20mm nominal maximum aggregate size and 80mm slump
- C3 Do not place conduits, pipes and the like within concrete cover.
- C4 All concrete shall be properly cured by keeping all exposed surfaces in a moist or damp condition for at least the first 7 days after placement.
 - Concrete must be maintained continuously wet for at least the first three days. Plastic sheeting is preferred to retain moisture and it will be necessary to provide additional water during the initial period.
- C5 Where brittle floor coverings are to be used (eg. tiled areas), extra measures are required to control the effect of shrinkage cracking. Some measures include the following:
 - a flexible grout bed shall be provided under tiles.
 - the placement of floor coverings shall be delayed (3 months minimum)

REINFORCEMENT

- Reinforcement designations are: N: D500N bar deformed to AS/NZ 4671 in accordance with AS 3600 and associated codes listed therein and the specification.
- Reinforcement is to be placed evenly, straight and adequately tied to prevent any movement during pouring of concrete.
- Where splicing is required, the minimum lap length in all cases shall be in accordance with the following table, unless noted otherwise:

N12	500
N16	750
N20	1100

- Trench mesh to be lapped 40 bar diameter throughout. U.N.O.
- Where reinforcement is continuous through a pour break, scabble, remove all loose material and dampen the old face before pouring against it.
- Reinforcement is represented diagrammatically and not necessarily in true projection.
- Cover to Reinforcement as noted on drawings.
- Fix all reinforcement and correctly tie in position using adequate bar chairs and spacer blocks in order that no disturbance of the reinforcement or puncturing of the membrane occurs during concrete pouring.

STEELWORK:

- Workmanship, materials and design shall be in accordance with A.S. 4100, associated codes listed therein and the specification.
- Unless noted otherwise steel elements shall be of the following grades:

General sections

- AS/NZS 3679 - AS/NZS 1163

C.H.S., R.H.S. & S.H.S. Purlins and girts

- grade G450 - Z275 to A.S. 1397

Hot-rolled steel flat products - AS/NZS 1594

- Refer to architectural drawings for lintels, cleats and members not specifically shown on these drawings.
- Bolting procedures are identified as follows:

Bolting Procedure	Grade MPa	Bolt TO A.S.	method of installation
4.6/S	4.6	AS 1111	Snug Tightened

- Welding categories shall be as follows Unless noted otherwise GP to A.S. 1554 Purlin & Girt Cleats GP to A.S. 1554
- Unless noted otherwise all fillet welds shall be 6mm continuous fillet welds.
- All steelworks to be blasted to class 2 and painted in accordance with architectural specifications.
- Contractor to provide and leave in place all temporary bracing where as required to stabilise the structure during erection until all perimeter bracing members are in place.



Slawomir (Slawek) Misiun Civil/ Structural Engineer MIE Aust. 927148 Accredited Building Practitioner No. CC4102M



ALPHA CONSULTING ENGINEERS & MANAGERS

M: 0438 433 113

E: info@alphaconsulting.com.au W: alphaconsulting.com.au

Project AS CONSTRUCTED ALTERATIONS 2 ROWAN AVENUE. PRIMROSE SANDS

Drawing **GENERAL NOTES** (C) Alpha Consulting, 2005 All rights reserved.

Date 03/02/2024 B.L.


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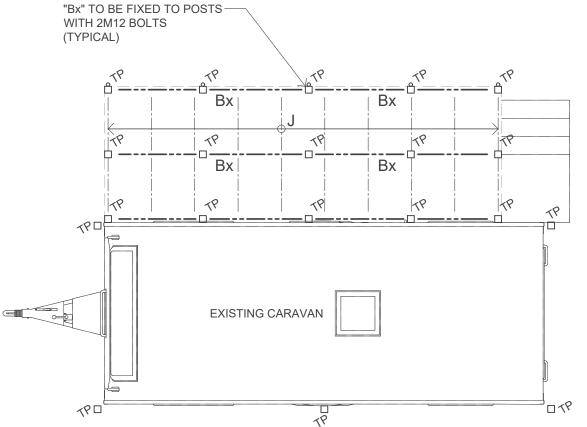
Scale AS INDIC.

Designed S.M.

Approved S.M.

Project/Drawing A23201 - 001 Rev



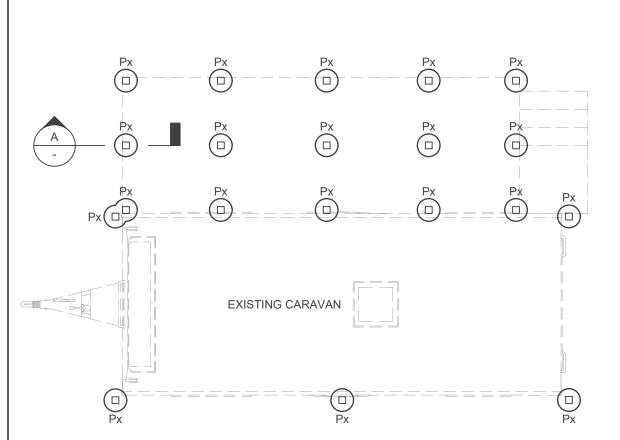

LEGEND


- Px: 450ø CONCRETE BORED PIER 1200 DEEP min.
- Bx: 140x45 MGP10 DECK BEARER
- J: 90x45 MGP10 at 600 CRS DECK JOIST
- TP: 90x90 T.P. TIMBER POST

FOOTINGS ARE DESIGNED TO CLASS "S" IN ACCORDANCE WITH A.S. 2870.

FOUNDING MATERIAL TO BE NATURAL SAND AND OF min. BEARING CAPACITY OF 100 kPa

FOOTINGS PLAN

1:50

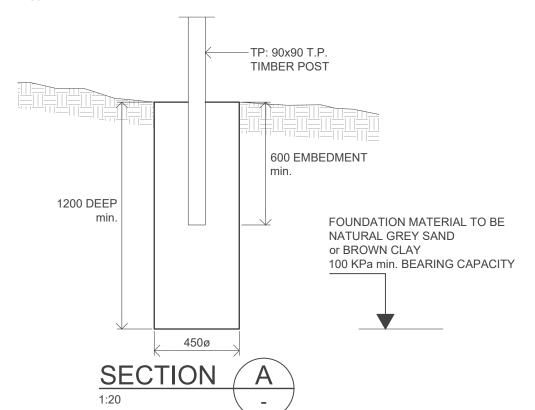

DECK FRAMING PLAN

1:50

Sorell Council

Development Application: Devvelopment
Application - 2 Rowan Avenue, Primrose Sands P1.pdf
Plans Reference:P1
Date Received:25/07/2024

Slawomir (Slawek) Misiun
Civil/ Structural Engineer
MIE Aust. 927148
Accredited Building Practitioner
No. CC4102M

ALF

ALPHA CONSULTING ENGINEERS & MANAGERS

M: 0438 433 113

E: info@alphaconsulting.com.au W: alphaconsulting.com.au

AS CONSTRUCTED ALTERATIONS
2 ROWAN AVENUE,
PRIMROSE SANDS

Drawing
SMALL CARAVAN
FOOTINGS & DECK
FRAMING PLANS
Designed Approved

S.M.


S.M.

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Date Drawn Scale 03/02/2024 B.L. 1:50

Project/Drawing A23201 - 002

1:50, 1:20 Rev WIND SITE CLASSIFICATION N3
IN ACCORDANCE WITH A.S.4055 & A.S.1684.2,
MAXIMUM WIND SPEED FOR BUILDING
Vu=50m/s

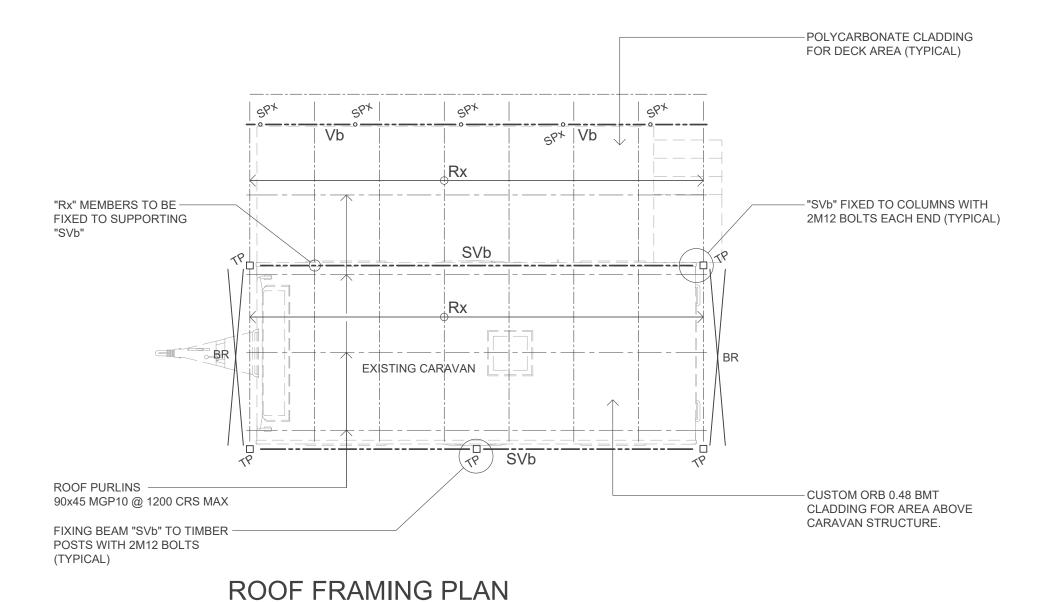

LEGEND

BR: DIAGONAL 30x0.8 METAL STRAP BRACING

Rx: 90x45 MGP10 RAFTERS at 900 CRS

SPx: 45x3.2 CHS STEEL POST STEEL POST TO BE CAST INTO CONCRETE PIERS 400 min. (TYPICAL)

SVb: C15015 STEEL VERANDAH BEAM

TP: 90x90 T.P. TIMBER POST

Vb: 90x45 T.P. TIMBER
VERANDAH BEAMS
(2 BEAMS PARALLEL @ 450 CRS min.)



Slawomir (Slawek) Misiun Civil/ Structural Engineer MIE Aust. 927148 Accredited Building Practitioner No. CC4102M ALPHA CONSULTING ENGINEERS & MANAGERS

M: 0438 433 113

E: info@alphaconsulting.com.au
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Project
AS CONSTRUCTED ALTERATIONS
2 ROWAN AVENUE,
PRIMROSE SANDS


Drawing SMALL CARAVAN ROOF FRAMING PLANS C Alpha Consulting, 2005 All rights reserved.

Date Drawn Sca

Date Drawn Scale 03/02/2024 B.L. 1:50

Designed Approved Project/Drawing S.M. A23201 - 003

Rev A

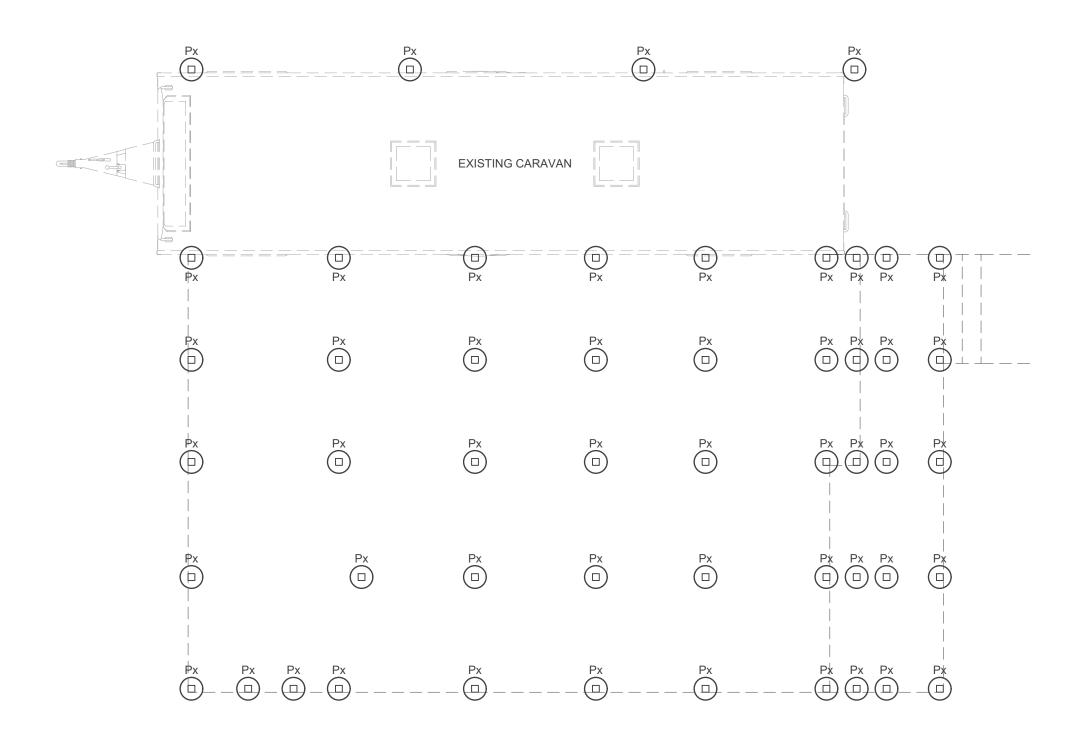

FOOTINGS PLAN



Slawomir (Slawek) Misiun Civil/ Structural Engineer MIE Aust. 927148 Accredited Building Practitioner No. CC4102M



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Project AS CONSTRUCTED ALTERATIONS 2 ROWAN AVENUE. PRIMROSE SANDS

Drawing LARGE CARAVAN **FOOTINGS PLAN**

S.M.

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LEGEND

NOTE:

OF 100 kPa

Px: min. 300ø CONCRETE BORED PIER

EXISTING FOOTING LOCATIONS SHOWN AS APPROXIMATE ONLY, DISTANCE BETWEEN FOOTINGS WITH TOLERANCE OF +/- 100mm

FOOTINGS ARE DESIGNED TO CLASS "S" IN ACCORDANCE WITH A.S. 2870.

FOUNDING MATERIAL TO BE NATURAL SAND AND OF min. BEARING CAPACITY

1200 DEEP min. INTO GROUND


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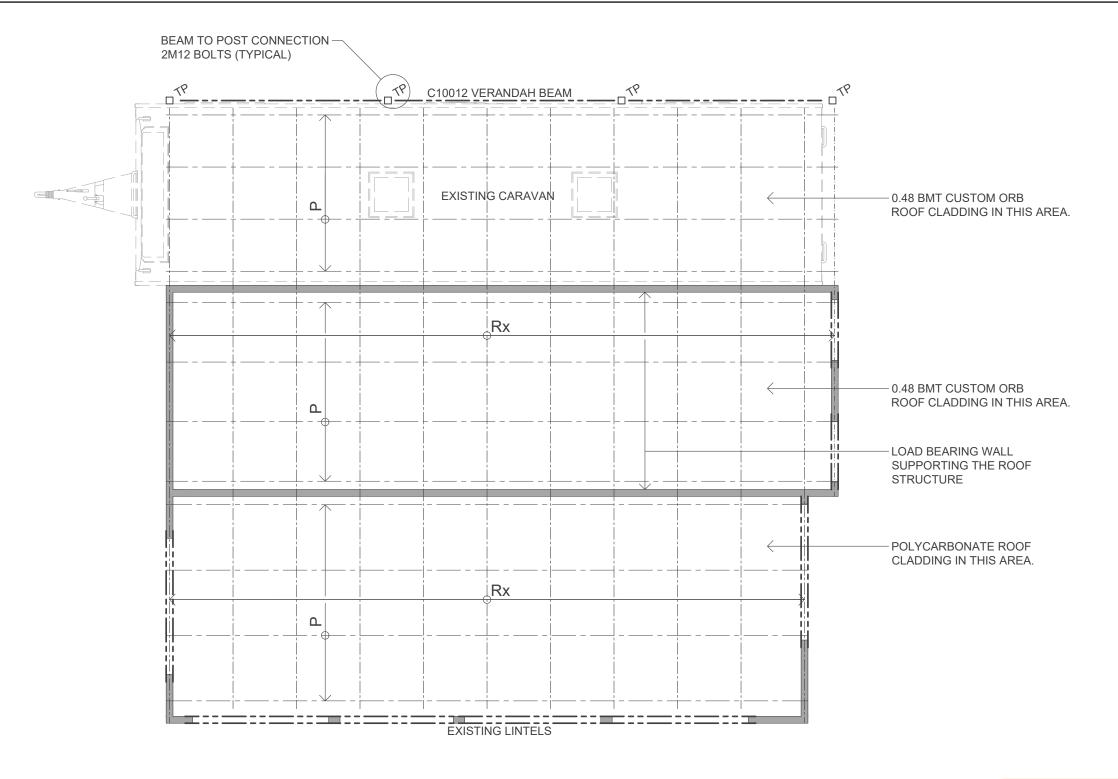
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Project/Drawing

Rev A23201 - 101 Α

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LEGEND

Rx: 90x45 MGP10 RAFTERS at 900 CRS

P: 90x45 MGP10 ROOF PURLINS at 900 CRS

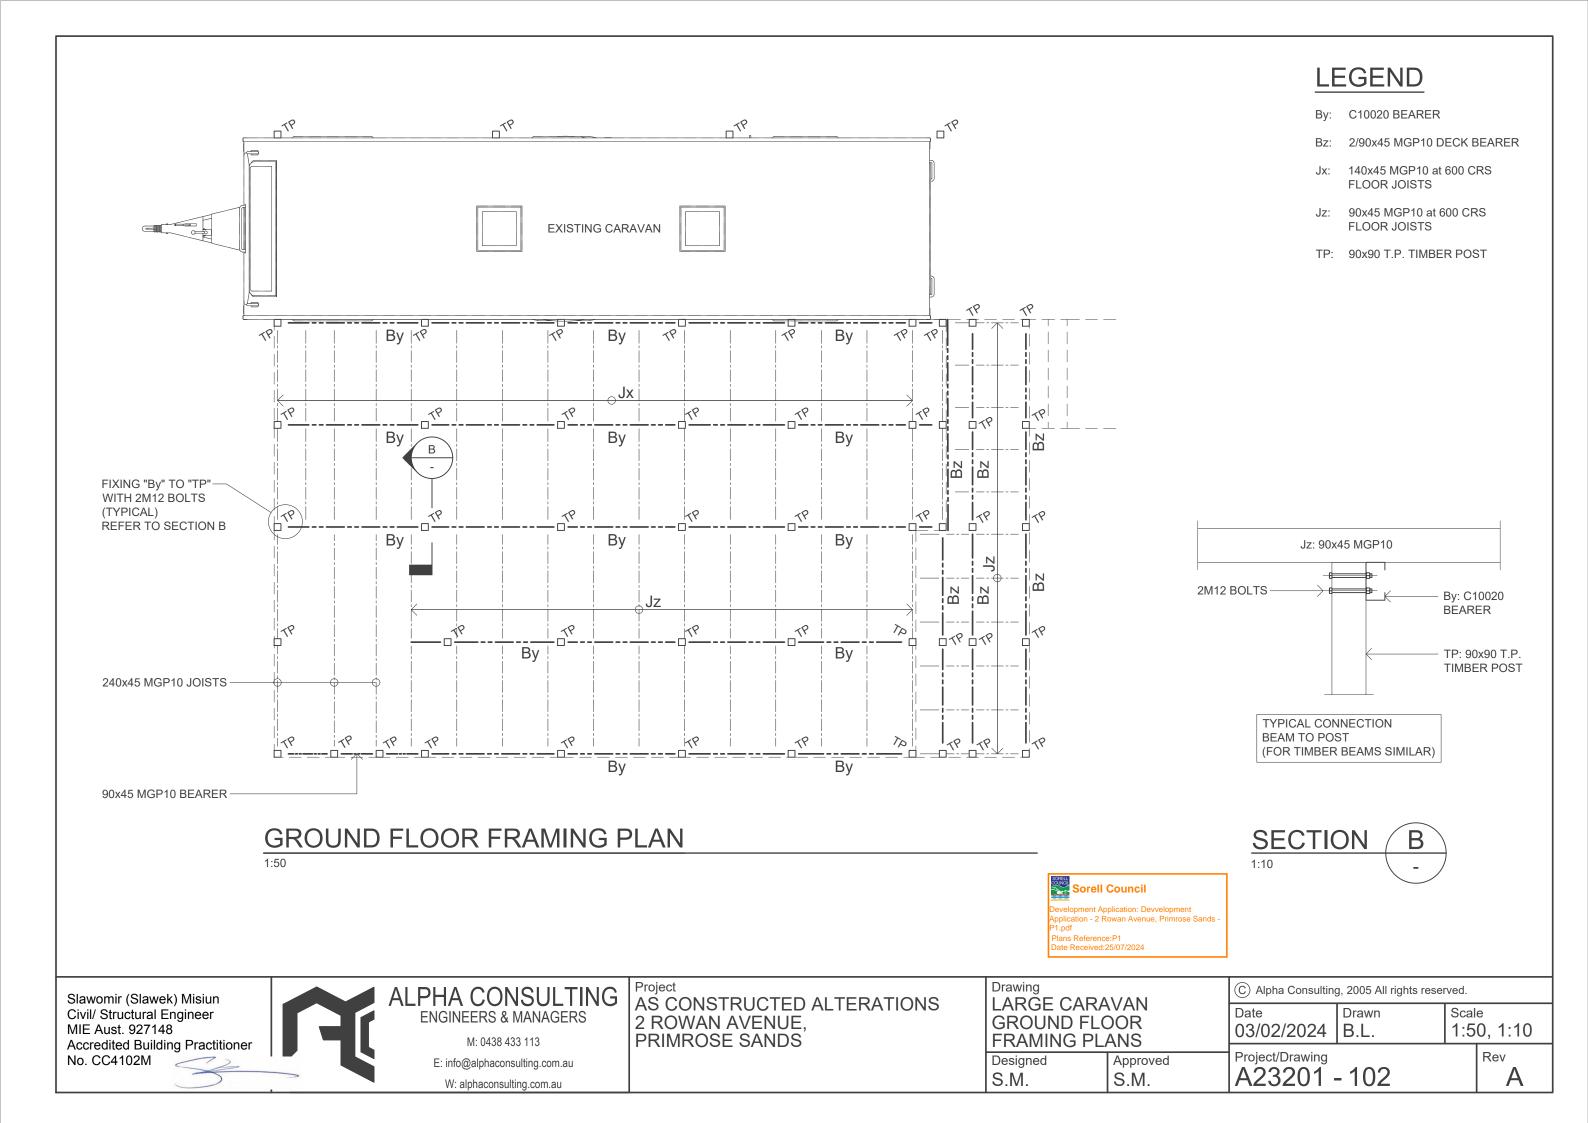TP: 90x90 T.P. TIMBER POST

NOTE:

ALL LINTELS 120x45 MGP10 or SIMILAR.

WIND SITE CLASSIFICATION N3
IN ACCORDANCE WITH A.S.4055 & A.S.1684.2,
MAXIMUM WIND SPEED FOR BUILDING
VIJESOM/s

ROOF FRAMING PLAN

1:50

Sorell Council

Development Application: Devvelopment
Application - 2 Rowan Avenue, Primrose Sands P1.pdf
Plans Reference:P1
Date Receiver:25/07/2024

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AS CONSTRUCTED ALTERATIONS 2 ROWAN AVENUE, PRIMROSE SANDS Drawing
LARGE CARAVAN
ROOF FRAMING
PLAN
Designed Approved

S.M.

S.M.

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Rev

N3 - SHEET ROOF - 6000 ULW

LOWER STORE	Y FLOOR FRAME TO SUPPORT	SINGLE OR UPP	ER STOREY FRAME TO FLOOR FRAME OR SLAB
BEARER / POST	4/75 X 3.33Ø OR 5/75 X 3.05Ø NAILS AND 1/30 X 0.8 GI STRAP OVER BEARER AND FIXED BOTH ENDS TO STUMP WITH 4/2.8Ø NAILS EACH END	BOTTOM PLATE / JOIST	1/M10 BOLT THROUGH TO BEARER @ 1200 CRS MAX 100 AWAY FROM JOIST LOCATION
BEARER / BRICK WALL, PIER	1/M10 BOLT OR 50 X 4 MILD STEEL FLAT BAR FIXED TO BEARER WITH M10 BOLT AND CAST INTO FOOTING.	BOTTOM PLATE / SLAB	CHEMICAL , EXPANSION OR FIRED PROPRIETORY FASTENER @ 900 CRS 5.4kN UPLIFT CAPACITY
BEARER / CONCRETE POST	6Ø ROD CAST INTO STUMP AND BENT OVER.	PLATE / STUD	30 X 0.8 GI STRAPS @ 900 MAX CRS. 6/2.8Ø NAILS EACH END TURN STRAP 100 MIN. DOWN FACE OF STUD
BEARER / STEEL POST	1/M10 COACH BOLT.	BEAM OR LINTEL / STUD	30 X 0.8 GI STRAP @ 900 CRS MIN. 250 DOWN FACE OF STUD. 6/2.8Ø NAILS EACH END, M10 BOLT OR GI STRAP TO FLOOR FRAME OR SLAB @ SIDE OF OPENING
FLOOR JOIST / BEARER	2/75 X 3.05Ø NAILS	BEAM OR LINTEL / POST	TIMBER POST - 2/M10 BOLTS STEEL POST - 50 X 6 MS PLATE, 1/M10 BOLT
LOWER STORE	Y WALL FRAME TO FLOOR FRAME / SLAB	RAFTER, TRUSS / WALL FRAME	2/30 X 0.8 LOOPED STRAPS @ 900 MAX CRS 3/2.8Ø NAILS EACH END
PLATE / STUD	30 X 0.8 GI STRAP 4/2.8Ø NAILS EACH END MIN. 100 DOWN FACE OF STUD	RAFTER / BEAM, LINTEL	CONCEALED FIXINGS 4 FRAMING ANCHORS @ 900 MAX CRS. 4/2.8Ø NAILS EACH END OF
BOTTOM PLATE / FLOOR JOIST	1/M10 BOLT THROUGH BEARER @ 3000 CRS		ANCHOR. EXPOSED FIXINGS 50 x 1.8 GI STRAP OVER RAFTER. 75mm No. 14 TYPE 17 SCREW EACH SIDE
BOTTOM PLATE / SLAB	CHEMICAL , EXPANSION OR FIRED PROPRIETORY FASTENER @ 900 CRS 5.4kn UPLIFT CAPACITY		OF RAFTER INTO TOP OF BEAM END FIXINGS 4/No. 14 TYPE 17 SCREWS THROUGH BEAM INTO END OF RAFTERS, MIN 35mm PENETRATION INTO RAFTERS.
SINGLE OR UPP	ER STOREY FLOOR FRAME TO SUPPORT	RAFTER / RIDGE	CONCEALED FIXINGS 4 FRAMING ANCHOR @ 900 MAX CRS. 4/2.8Ø NAILS EACH END OF ANCHOR.
BEARER / POST	2/ 30 X 0.8 GI STRAPS @ 1800 CRS, 4/2.8Ø EACH END STRAP INTO POST 2/2.8Ø NAILS INTO TOP OF BEARER		EXPOSED FIXINGS 50 x 1.8 GI STRAP OVER RAFTER. 75mm No. 14 TYPE 17 SCREW EACH SIDE OF RAFTER INTO TOP OF BEAM
BEARER / BRICK WALL, PIER	1/M10 BOLT THROUGH BEARER. BOLT TIED TO FOOTING		END FIXINGS 4/No. 14 TYPE 17 SCREWS THROUGH BEAM INTO END OF RAFTERS, MIN 35mm PENETRATION INTO RAFTERS.
BEARER / CONCRETE POST	75 X 8 MS FISHTAIL PLATE CAST INTO POST. 1/M10 BOLT THROUGH BEARER		SOME ENETTATION INTO IVALUENCE.
BEARER / STEEL POST	75 X 8 MS PLATE, 1/M12 BOLT THROUGH	RIDGE BOARD, HIP RAFTERS / WALLS	$1/30 \times 0.8$ GI LOOPED STRAP @ 1800 MAX CRS, $4/2.8\emptyset$ NAILS TIED DOWN TO INTERNAL WALLS AND EXTERNAL WALLS AT GABLE ENDS, WITH 30 \times 0.8 GI STRAP $4/2.8$ Ø NAILS EACH END OVER RIDGE
FLOOR JOIST / TOP PLATE, BEARER	2 METAL FRAMING ANCHORS 4/2.8Ø NAILS IN EACH LEG	ROOF BATTEN / RAFTER, TRUSS	2/75 X 3.05Ø DEFORMED SHANK NAILS GENERALLY 1/75 No. 14 TYPE 17 SCREW WITHIN 1200 OF ROOF EDGES.



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Project AS CONSTRUCTED ALTERATIONS 2 ROWAN AVENUE, PRIMROSE SANDS

Drawing TIE DOWN NOTES

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Date 03/02/2024 B.L.

Drawn

Scale N.T.S. Rev

Α

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