

# NOTICE OF PROPOSED DEVELOPMENT

Notice is hereby given that an application has been made for planning approval for the following development:

SITE: 63 Friendship Drive, Sorell

# **PROPOSED DEVELOPMENT:**

# **DWELLING**

The relevant plans and documents can be inspected at the Council Offices at 47 Cole Street, Sorell during normal office hours, or the plans may be viewed on Council's website at <a href="https://www.sorell.tas.gov.au">www.sorell.tas.gov.au</a> until Monday 26th May 2025.

Any person may make representation in relation to the proposal by letter or electronic mail (<a href="mailto:sorell.council@sorell.tas.gov.au">sorell.council@sorell.tas.gov.au</a>) addressed to the General Manager. Representations must be received no later than **Monday 26th May 2025**.

APPLICANT: Construct Creative Pty Ltd

APPLICATION NO: DA 2025 / 87 1 DATE: 09 May 2025

# Part B: Please note that Part B of this form is publicly exhibited.

Full description of Proposal:	Use: Dwelling				
	Development: Construction of a single dwelling				
	Large or complex proposals s	hould be described	in a letter or planning report.		
Design and const	truction cost of proposal:	\$ 442,30	00.00		
is all, or some the	e work already constructed:	No: 🗹	Yes:		
proposed		Posto	7172 code:		
Current Use of Site	Vacant Land				
Current Owner/s:	Name(s)	s Pty Ltd			
Is the Property or Register?	n the Tasmanian Heritage	No: ☑ Yes: □	If yes, please provide written advice from Heritage Tasmania		
Is the proposal to than one stage?	be carried out in more	No: ☑ Yes: □	If yes, please clearly describe in plans		
Have any potenti been undertaken	ally contaminating uses on the site?	No: ☑ Yes: □	If yes, please complete the Additional Information for Non-Residential Use		
ls any vegetation	proposed to be removed?	No: ☑ Yes: ☐	If yes, please ensure plans clearly show area to be impacted		
Does the proposa administered or or or Council?	al involve land owned by either the Crown	No: ☑ Yes: ☐	If yes, please complete the Council or Crown land section on page 3		
	led vehicular crossing is requinicular Crossing (and Associat		ation form		
https://www.sore	ell.tas.gov.au/services/engin	eering/	Development Application: 5.2025.87.1 - Development Application - 63 Friendship drive Sorell - P1.pdf Plans Reference:P1 Date Received:7/04/2025		

### **Declarations and acknowledgements**

- I/we confirm that the application does not contradict any easement, covenant or restriction specified in the Certificate of Title, Schedule of Easements or Part 5 Agreement for the land.
- I/we consent to Council employees or consultants entering the site and have arranged permission and/or access for Council's representatives to enter the land at any time during normal business hours.
- I/we authorise the provision of a copy of any documents relating to this application to any person for the purposes of assessment or public consultation and have permission of the copyright owner for such copies.
- I/we declare that, in accordance with s52(1) of the Land Use Planning and Approvals Act 1993, that I have notified the owner(s) of the intention to make this application.
- I/we declare that the information in this application is true and correct.

Details of how the Council manages personal information and how you can request access or corrections to it is outlined in Council's Privacy Policy available on the Council website.

- I/we acknowledge that the documentation submitted in support of my application will become a public record held by Council and may be reproduced by Council in both electronic and hard copy format in order to facilitate the assessment process, for display purposes during public exhibition, and to fulfil its statutory obligations. I further acknowledge that following determination of my application, Council will store documentation relating to my application in electronic format only.
- Where the General Manager's consent is also required under s.14 of the *Urban Drainage Act 2013*, by making this application I/we also apply for that consent.

Applicant Signature:

Signature: ...

..... Date: .

07/04/2025

### Crown or General Manager Land Owner Consent

If the land that is the subject of this application is owned or administered by either the Crown or Sorell Council, the consent of the relevant Minister or the Council General Manager whichever is applicable, must be included here. This consent should be completed and signed by either the General Manager, the Minister, or a delegate (as specified in s52 (1D-1G) of the Land Use Planning and Approvals Act 1993).

### Please note:

- If General Manager consent if required, please first complete the General Manager consent application form available on our website www.sorell.tas.gov.au
- If the application involves Crown land you will also need a letter of consent.
- Any consent is for the purposes of making this application only and is not consent to undertaken work or take any other action with respect to the proposed use or development.

	being responsible for the  Sorell Council	
administration of land at	Development Application: 5.2025.87.1 - Development Application - 63 Friendship drive, Sorell - P1.pdf Plans Reference:P1 Date Received:7/04/2025	
Signature of General Manager, Minister or Delegate: Signature:	Date:	



CREATIVE HOMES HOBART, CNR OF ELWICK ROAD & BROOKER HIGHWAY, GLENORCHY 7010 PH: 03 6272 3000

PROJECT ADDRESS: 63 FRIENDSHIP DRIVE, SORELL

TITLE REFERENCE: VOLUME: 185351 FOLIO: 91

**CLIENTS:** HALEY SOUTHGATE & EMMANUEL OPIRA

**DESIGNER:** Inge Brown, CC 6652

**DRAWINGS:** 01 COVER PAGE

02 PROPOSED SITE PLAN 03 PROPOSED FLOOR PLAN 04 PROPOSED ROOF PLAN 05 PROPOSED ELEVATIONS 06 PROPOSED ELEVATIONS

07 SECTION A-A

08 TYPICAL SECTION DETAILS
09 WINDOW SCHEDULE

**FLOOR AREAS:** FLOOR AREA: 127.4 m<sup>2</sup>

PORCH: 1.0 m<sup>2</sup> GARAGE: 43.5 m<sup>2</sup>

TOTAL AREA: 171.9 m<sup>2</sup> DECK: 9.7 m<sup>2</sup>

**SOIL CLASSIFICATION: --**

WIND CLASSIFICATION: --

**CLIMATE ZONE:** 7

BUSHFIRE ATTACK LEVEL: N/A - NOT WITHIN OVERLAY

**ALPINE AREA:** N/A

**CORROSION ENVIRONMENT:** N/A

# **DOCUMENTATION INDEX**

The documentation listed below should be read in conjunction with these drawings and form the basis of construction documentation for the project

Document	Revision	Ву
Working drawings planning issue (these drawings)	С	Creative Homes Hobart
Survey plan SP241596-01	А	Survey Plus
Soil assessment		Doyle Soil Consulting



# Sorell Council

Development Application: 5.2025.87.1 Response to Request For Information - 63 Friendship Drive, Sorell - P2.pdf Plans Reference: P2

THIS PLAN HAS BEEN PREPARED BY SLIRVEY PLUS FROM A COMBINATION OF EXISTING RECORDS AND

PHYSICAL FEATURES OF THE LAND AND SHOULD NOT BE USED FOR ANY OTHER PURPOSE.

FIELD SLIRVEY FOR THE PLIRPOSES OF SHOWING THE

2. TITLE BOUNDARIES SHOWN WERE NOT VERIFIED OR MARKED BY SURVEY PLUS AT THE TIME OF THIS SURVEY.

3. SERVICES SHOWN ON THIS PLAN WERE LOCATED WHERE POSSIBLE BY FIELD SURVEY. THEY ARE NOT A COMPLETE PICTURE OF SERVICES ON SITE. ALL SERVICE LOCATIONS ARE TO BE VERIFIED BEFORE COMMENCEMENT OF ANY WORK ON SITE, IN PARTICULAR THOSE SERVICES NOT PREVIOUSLY LOCATED THROUGH FIELD SURVEY

4 SURVEY PLUS CAN NOT ACCEPT HABILITY WHATSOEVER FOR LOSS OR DAMAGE CAUSED TO ANY UNDERGROUND SERVICE WHETHER SHOWN BY OUR SURVEY OR NOT. 5 THIS NOTE IS AN INTEGRAL PART OF THIS PLAN/DATA REPRODUCTION OF THIS PLAN OR ANY PART OF IT WITHOUT THIS NOTE BEING INCLUDED. IN FULL WILL RENDER THE INFORMATION. SHOWN ON SUCH A REPRODUCTION INVALID AND NOT SUITABLE FOR USE WITHOUT PRIOR AUTHORITY OF SURVEY PLUS.

6. HORIZONTAL DATUM IS MGA (GDA94).

7. VERTICAL DATUM IS AHD.

LIST DATA IMPORT

• TasWater-SewerLateralLine

8. CONTOUR INTERVAL IS 0.2 METRE, INDEX IS 1.0 METRE.

9. SURVEY BY ROBOTIC TOTAL STATION AND GPS.

10. IMPORTED DATA SHOWN ON THIS PLAN WAS OBTAINED FOR PUBLIC AVAILABLE DATA FROM VARIOUS GOVERNMENT AUTHORITIES. THIS INFORMATION IS PROVIDED FOR GUIDANCE ONLY THE ACCURACY OF ANY IMPORTED DATA IS PER THE ACCURACY QUOTED BY THE SOURCE AND IS IN NO WAY GUARANTEED BY SURVEY PLUS. USERS MUST NOT RELY ON THIS DATA FOR ON-GROUND LOCATION OF BOUNDARIES AND/OR

TasWater-WaterHydrant TasWater-WaterLateralLine

TasWater-WaterMain

CadastralParcel-OwnerInformation

11. BOUNDARIES ARE COMPILED ONLY FROM SP185351 AND RELEVANT SURVEY INFORMATION OBTAINED FROM LAND TITLES OFFICE AND ARE APPROXIMATE AND SUBJECT TO SURVEY.

12. ALL WINDOWS WERE NOT ABLE TO BE LOCATED DUE TO OBSTRUCTION OF LINE OF SIGHT FROM TOTAL STATION.
WINDOW LOCATIONS ARE APPROXIMATE ONLY DUE TO BEING UNABLE TO BE PERPENDICULAR TO WINDOWS WHEN LOCATING WOITATS IATOT HTIW

13. 3D DATA TURNED OFF IN LAYER CONTROL

MAJOR CONTOUR 3D

MINOR CONTOUR 3D

GPS DATA SCALE LOCATION JOB CONTROL POINT POINT NO: #1 DESCRIPTION: NAIL IN GRASS GPS SCALE FACTOR = 1.000378996 F: 547377 391 N: 5263724.758 RL: 41.146  $EPU = 0.04 \pm$ 



nt Application: 5.2025.87.1 Respor uest For Information - 63 Friendship Driv

CONFIRMED ON SITE PRIOR TO CONSTRUCTION. ATTENTION OF OWNER THE OWNERS ATTENTION IS DRAWN TO THE FACT THAT FOUNDATIONS AND ASSOCIATED DRAINAGE FOR ALL SITES REQUIRES CONTINUING MAINTENANCE TO ASSIST FOOTING PERFORMANCE, ADVICE FOR FOUNDATION MAINTENANCE IS CONTAINED IN THE CSIRO BUILDING TECHNOLOGY FILE 18 AND IT IS THE OWNERS RESPONSIBILITY TO MAINTAIN THE SITE IN

SITE PREPARATION
THE SITE IS TO BE DISTURBED AS MINIMALLY AS

EARTHWORKS SHALL BE CARRIED OUT IN ACCORDANCE WITH NCC PART 3.2.

ACCORDANCE WITH NCC TABLE 3.2.1.

PENETRATION, DAMPNESS, WEAKENING &

LOCATION OF ALL EXISTING SERVICES TO BE

THE BUILDING WORKS.

PART 3 3 2

POSSIBLE TO THE EXTENT REQUIRED TO CARRY OUT

UN-RETAINED EMBANKMENT GRADIENTS SHALL BE IN

DRAINAGE SHALL BE IN ACCORDANCE WITH NCC

THE BUILDER AND SUBCONTRACTOR SHALL ENSURE

THAT ALL STORMWATER DRAINS, SEWER PIPES AND THE LIKE ARE LOCATED AT A SUFFICIENT DISTANCE

FROM ANY BUILDINGS FOOTING AND/OR SLAB EDGE BEAMS SO AS TO PREVENT GENERAL MOISTURE

UNDERMINING OF ANY BUILDING AND IT'S FOOTING

SOIL AND WATER MANAGEMENT NOTES: DRAINAGE LINES ARE TO BE INSTALLED PRIOR TO THE PLACEMENT OF ROOF AND GLITTERING, ONCE DWELLING IS ROOFED, CONNECT IMMEDIATELY APPLY TEMPORARY COVERING TO DISTURBED AREAS THAT WILL REMAIN EXPOSED FOR 14 DAYS OR MORE DURING CONSTRUCTION (EG. WATERPROOF BLANKET, VEGETATION OR MULCH)

PROTECT ANY NEARBY OR ON-SITE DRAINAGE PITS FROM SEDIMENT BY INSTALLING SEDIMENT TRAPS AROUND THEM.

LIMIT ENTRY/EXIT TO ONE POINT AND STABILISE. INSTALL FACILITIES TO REMOVE DIRT/ MUD FROM VEHICLE WHEELS BEFORE THEY LEAVE THE SITE.

SITE TO BE VEGETATED AND PLANTED ACCORDING TO THE HOBART REGIONAL SOIL AND WATER MANAGEMENT CODE OF PRACTICE.

## BUILDER AND SUBCONTRACTORS TO VERIFY ALL **DIMENSIONS AND LEVELS** PRIOR TO THE COMMENCEMENT OF ANY WORK. GIVE 24 HOURS

MINIMUM NOTICE WHERE AMENDMENTS ARE REQUIRED TO DRAWINGS. THESE DRAWINGS ARE TO BE READ IN CONJUNCTION WITH DOCUMENTATION LISTED ON THE COVER PAGE. DO NOT SCALE

DIMENSIONS ARE TO TAKE PREFERENCE OVER SCALE. BUILDING SPECIFICATION AND ENGINEERS
DRAWINGS SHALL OVERRIDE ARCHITECTURAL

-THIS DRAWING IS TO BE READ IN CONJUNCTION WITH ALL OTHER DRAWING SHEETS, CONSULTANTS DRAWINGS, DOCUMENTS, SCHEDULES AND SPECIFICATIONS (AS APPLICABLE).
-THE BUILDER AND SUBCONTRACTOR SHALL ENSURE

THAT ALL STORMWATER DRAINS, SEWER PIPES AND THE LIKE ARE LOCATED AT A SUFFICIENT DISTANCE FROM ANY BUILDINGS FOOTING AND/OR SLAB EDGE BEAMS SO AS TO PREVENT GENERAL MOISTURE PENETRATION, DAMPNESS, WEAKENING & UNDERMINING OF ANY BUILDING AND ITS FOOTING

CONFIRMED ONSITE PRIOR TO CONSTRUCTION


### IMPORTANT!

SITE INFORMATION AS DRAWN IS APPROXIMATE ONLY. FINAL SITE INFORMATION IS SUBJECT TO A DETAILED CONTOUR SURVEY BY LICENSED SURVEYOR

SITE COVERAGE SITE AREA 899.2 m<sup>2</sup> PROPOSED BUILDING FOOTPRINT 171.9 m<sup>2</sup>

PROPOSED SITE COVERAGE 19.12 % JOB ADDRESS: Haley Southgate 63 Friendship Drive & Emmanuel Opira

designer: I. Brown accred. no.: CC6652 sheet: January 2025 DESIGN TYPE: DRAWING NO: DATE

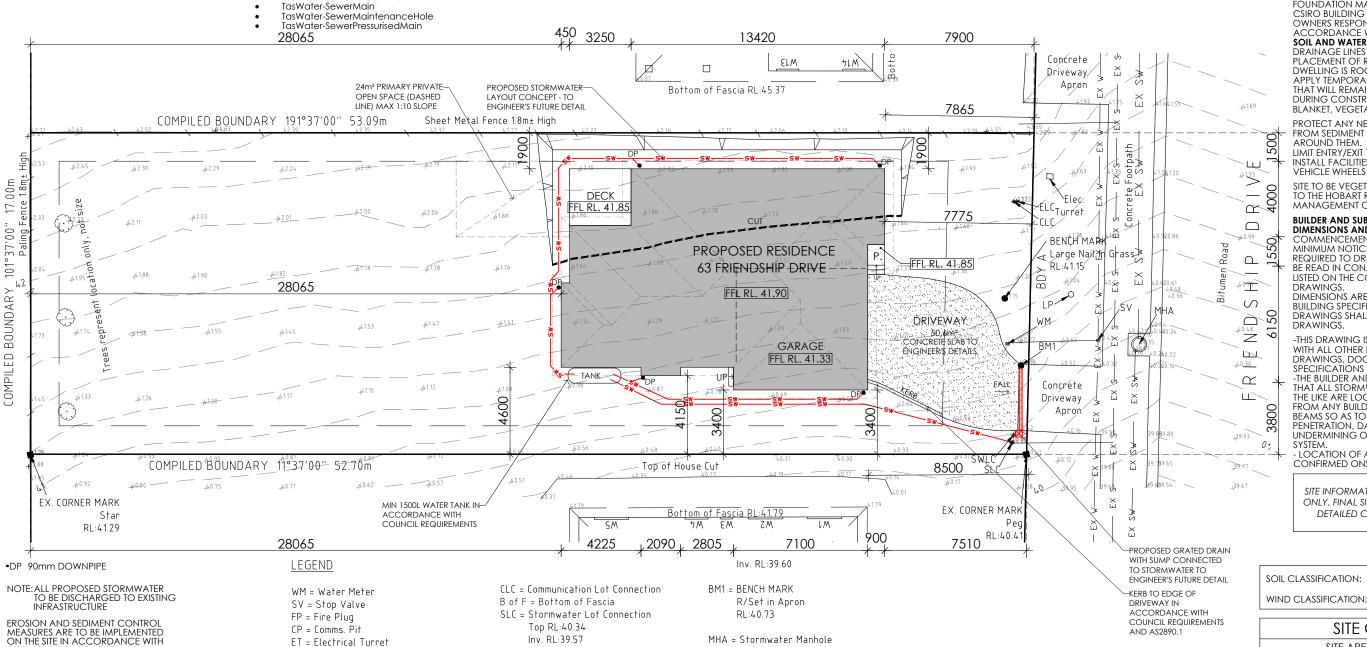

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ROJECT NORTH

DO NOT SCALE DRAWINGS.

CONTRACTOR MUST VERIFY ALL DIMENSIONS ANY WORK OR MAKING ANY SHOP DRAWINGS.

PROPOSED SITE PLAN SLC = Sewer Lot Connection ELC = Electricity Lot Connection

REV: DESCRIPTION: BY: and levels at the job prior to commencing  $\sl s$   $\sl s$  USSUED FOR CLIENT REVIEW NN 17/01/25 ISSUED FOR CLIENT REVIEW NN 28/02/25 B DESIGN AMENDMENTS IB 17/04/25 ALWAYS USE WRITTEN DIMENSIONS C. DESIGN AMENDMENTS IB 30/04/25

SLC = Sewer Lot Connection

Top RL:40.34

PRELIMINARY

SWLC = Stormwater Lot Connection

CREATIVE HOMES HOBART, CNR OF ELWICK ROAD & BROOKER HIGHWAY, GLENORCHY 7010 PH: 03 6272 3000

Top RL:40.35

In Inv RL:39.10

DATE:


Out Inv RL:38.97

Sorell

DRAWN:N. Nguyen | DATE: CHECKED: 1:200 REV: SCALE С

Custom

2 of 9

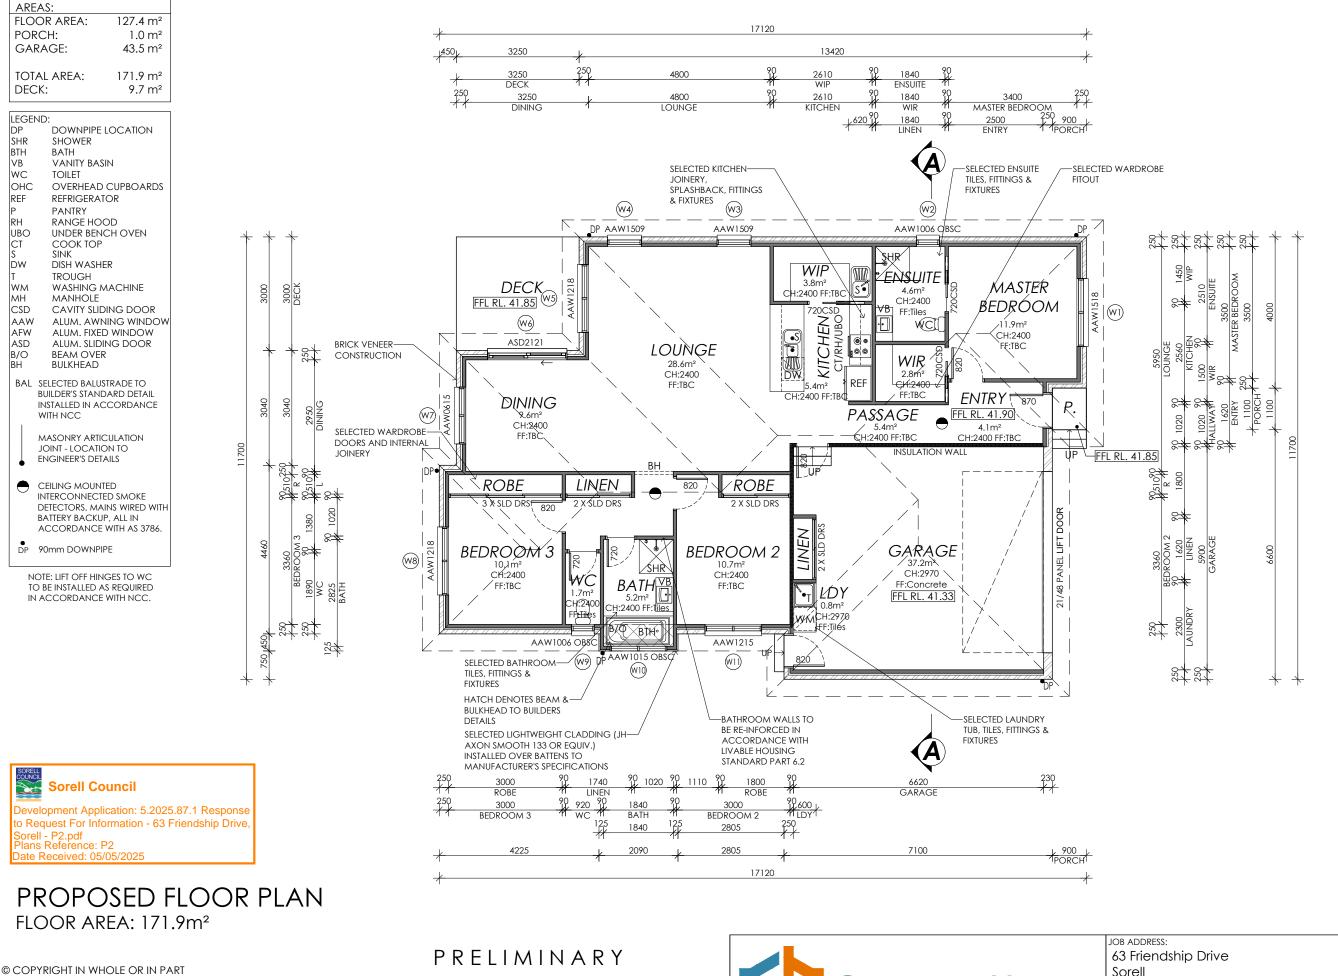

Framing NCC H1D6
All timber framing, fixing and bracing shall comply with AS 1684 and the requirements of NCC H1D6.
Manufactured sizes must not be undersized to those specified, for all timber sizes, stress grades, spacing and wall bracing refer to Engineer's details. Tie-down defails shall be in accordance with Engineer's details and comply with with Engineer's details and comply with NCC H1D6 (4). Structural steel members shall comply with the requirements of clauses in NCC H1D6 (3). Refer to Engineer's details where provided.

Glazing NCC H1D8
All windows to be aluminium awning style, double glazed (obscured safety glass to bathrooms as shown on drawings) All glazing shall comply with the requirements of AS 2047 & AS 1288 and NCC H1D8.

Human impact safety requirements shall comply with NCC H1D8 (3) and Part 8.4 of the ABCB Housing provisions.

Builder and subcontractors to verify all

Builder and subcontractors to verify all dimension and levels prior to the commencement of any work. Give 24hrs minimum notice where amendments are required to design of working drawings. These drawings are to be read in conjunction with Engineer's and Surveyor's drawings and notes. Do not scale drawings. Dimensions are to take preference over scale. Building specification and Engineer's drawings shall override architectural drawings. All construction work shall be carried out in accordance with the state building regulations, local council by-laws and relevant NCC and AS codes.

Important notice for attention of Owners: the Owners attention is drawn to the fact that foundations and associated drainage in all sites requires continuing maintenance to assist tooting performance. Advice for foundation maintenance is contained in the CSIRO building technology file 18 and it is the Owners responsibility to maintain the site in accordance with this document.

Energy efficiency: Insulation must comply with AS/NZS4859.1 and be installed in accordance with ABCB housing provisions Part 13.2.2 and comply with minimum R values for climate zone 7. Bulk insulation between external studs to

Bulk insulation between external studs to be insulated with min R2.0. (Ensure batts fit within cavity without compression, making sure that there is at least 25mm gap from the reflective surface). External walls are to be clad with vapour permeable reflective foil over the outside of the timber frame. Ceiling to be insulated with R4.0 and vapour permeable sarking. Floor to be insulated with Min R1.7 batts where applicable. Seal exhaust fans to Ensuite. Bathroom. Seal exhaust fans to Ensuite, Bathroom Laundry and Kitchen. All downlights to be IC rated. Construction of the externa walls, floor and roof for compliance with building sealing requirements shall comply with BCA 2019 Part 3.12

General:
All flashings, weep holes and damp proof coursing to be in accordance with NCC Housing provisions Part 5.7. Fibre cement sheet in accordance with NCC Housing provisions Part 7.5. Block construction in accordance NCC Housing provisions Part 5.7. Plasterboard linings to internal walls and ceilings with selected cornice. (see below for wet areas)


Wet areas: All wet areas shall comply with the requirements of ABCB Housing provisions Part 10.2. Provide waterprool plasterboard sheeting to all walls and ceilings. Provide ceramic tiles or other ceilings. Frovide Ceramic liles of other approved water resistant lining in accordance with Part 10.2.9 to a minimum height of 1800mm to shower walls and to a height of min 150mm behind baths, basins, sinks, troughs, washing machines and wall fixtures.

For construction of floor wastes refer to NCC ABCB Housing provisions part 10.2.12. For typical installation requirements for substrate preparation, penetrations, flashings/junctions, membranes, screeds, hobs, baths, showers, door jambs and screens refer to ABCB Housing provisions part 10.2.14-32.

PROJECT NORTH

CONTRACTOR MUST VERIFY ALL DIMENSIONS AND LEVELS AT THE JOB PRIOR TO COMMENCING SK ANY WORK OR MAKING ANY SHOP DRAWINGS.

DO NOT SCALE DRAWINGS. ALWAYS USE WRITTEN DIMENSIONS

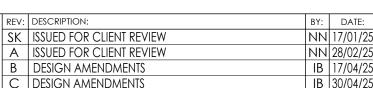



Sorell		&
designer: I. Brown	ACCRED. NO.: CC6652	SHE
DRAWN:N. Nguyen	DATE: January 2025	DES
CHECKED:	DATE:	DRA


SCALE:

CLIENT: Haley Southgate **Emmanuel Opira** 

EET: 3 of 9 SIGN TYPE: Custom AWING NO: 1:100 REV: С



oment Application: 5.2025.87.1 Response o Request For Information - 63 Friendship Drive

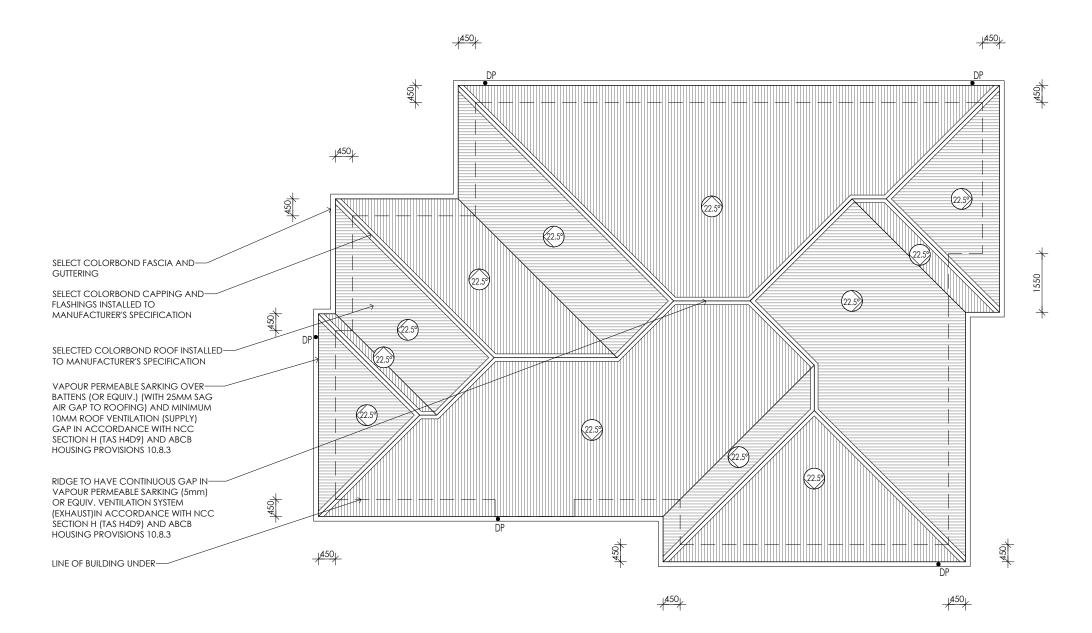

# PROPOSED ROOF PLAN

● DP 90mm DOWNPIPE

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CONTRACTOR MUST VERIFY ALL DIMENSIONS ANY WORK OR MAKING ANY SHOP DRAWINGS. DO NOT SCALE DRAWINGS. ALWAYS USE WRITTEN DIMENSIONS.

PRELIMINARY

REV: DESCRIPTION: DATE: BY: and levels at the job prior to commencing SK | ISSUED FOR CLIENT REVIEW NN 17/01/25 ISSUED FOR CLIENT REVIEW NN 28/02/25 DESIGN AMENDMENTS IB 17/04/25 C DESIGN AMENDMENTS IB 30/04/25



JOB ADDRESS: 63 Friendship Drive Sorell

1:100

REV:

CHECKED:

SCALE:

designer: I. Brown accred. no.: CC6652 sheet: DRAWN:N. Nguyen DATE: January 2025 DESIGN TYPE: DATE:

С

CLIENT: Haley Southgate & Emmanuel Opira

4 of 9 Custom DRAWING NO:

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Framing NCC H1D6
All timber framing, fixing and bracing shall comply with AS 1684 and the requirements of NCC H1D6.
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Human impact safety requirements shall comply with NCC H1D8 (3) and Part 8.4 of the ABCB Housing provisions.

Builder and subcontractors to verify all dimension and levels prior to the commencement of any work. Give 24hrs minimum notice where amendments are required to design of working drawings. These drawings are to be read in conjunction with Engineer's and Sunework drawings and pates. Do not conjunction with Engineer's and Surveyor's drawings and notes. Do not scale drawings. Dimensions are to take preference over scale. Building specification and Engineer's drawings shall override architectural drawings. All construction work shall be carried out in accordance with the state building regulations, local council by-laws and relevant NCC and AS codes.

Important notice for attention of Owners: the Owners attention is drawn to the fact the Owners attention is drawn to the fact that foundations and associated drainage in all sites requires continuing maintenance to assist footing performance. Advice for foundation maintenance is contained in the CSIRO building technology file 18 and it is the Owners responsibility to maintain the site in accordance with this document.


Energy efficiency:
Insulation must comply with AS/NZ\$4859.1
and be installed in accordance with
ABCB housing provisions Part 13.2.2 and
comply with minimum R values for
climate zone 7.
Bulk insulation between external studs to
be insulated with min R? 0. (Ensure batts be insulated with min R2.0. (Ensure batts
fit within cavity without compression,
making sure that there is at least 25mm
gap from the reflective surface). External
walls are to be clad with vapour
permeable reflective foil over the outside
of the timber frame. Ceiling to be


insulated with R4.0 and vapour permeable sarking. Floor to be insulated with Min R1.7 batts where applicable. Seal exhaust fans to Ensuite, Bathroom, Laundry and Kitchen. All downlights to be IC rated. Construction of the external walls, floor and roof for compliance with building sealing requirements shall comply with BCA 2019 Part 3.12

General: All flashings, weep holes and damp All flashings, weep holes and damp proof coursing to be in accordance with NCC Housing provisions Part 5.7. Fibre cement sheet in accordance with NCC Housing provisions Part 7.5. Block construction in accordance NCC Housing provisions Part 5.7. Plasterboard linings to internal walls and ceilings with selected cornice. (see below for wet great)

Wet areas: All wet areas shall comply Wet areas: All wet areas shall comply with the requirements of ABCB Housing provisions Part 10.2. Provide waterproof plasterboard sheeting to all walls and ceilings. Provide ceramic tiles or other approved water resistant lining in accordance with Part 10.2.9 to a minimum height of 1800mm to shower walls and to a height of min 150mm behind boths, basins, sinks, troughs, washing machines and wall fixtures.

For construction of floor wastes refer to For construction of tioor wastes refer to NCC ABCB Housing provisions part 10.2.12. For typical installation requirements for substrate preparation, penetrations, flashings/ junctions, membranes, screeds, hobs, baths, showers, door jambs and screens refer to ABCB Housing provisions part 10.2.14-32.

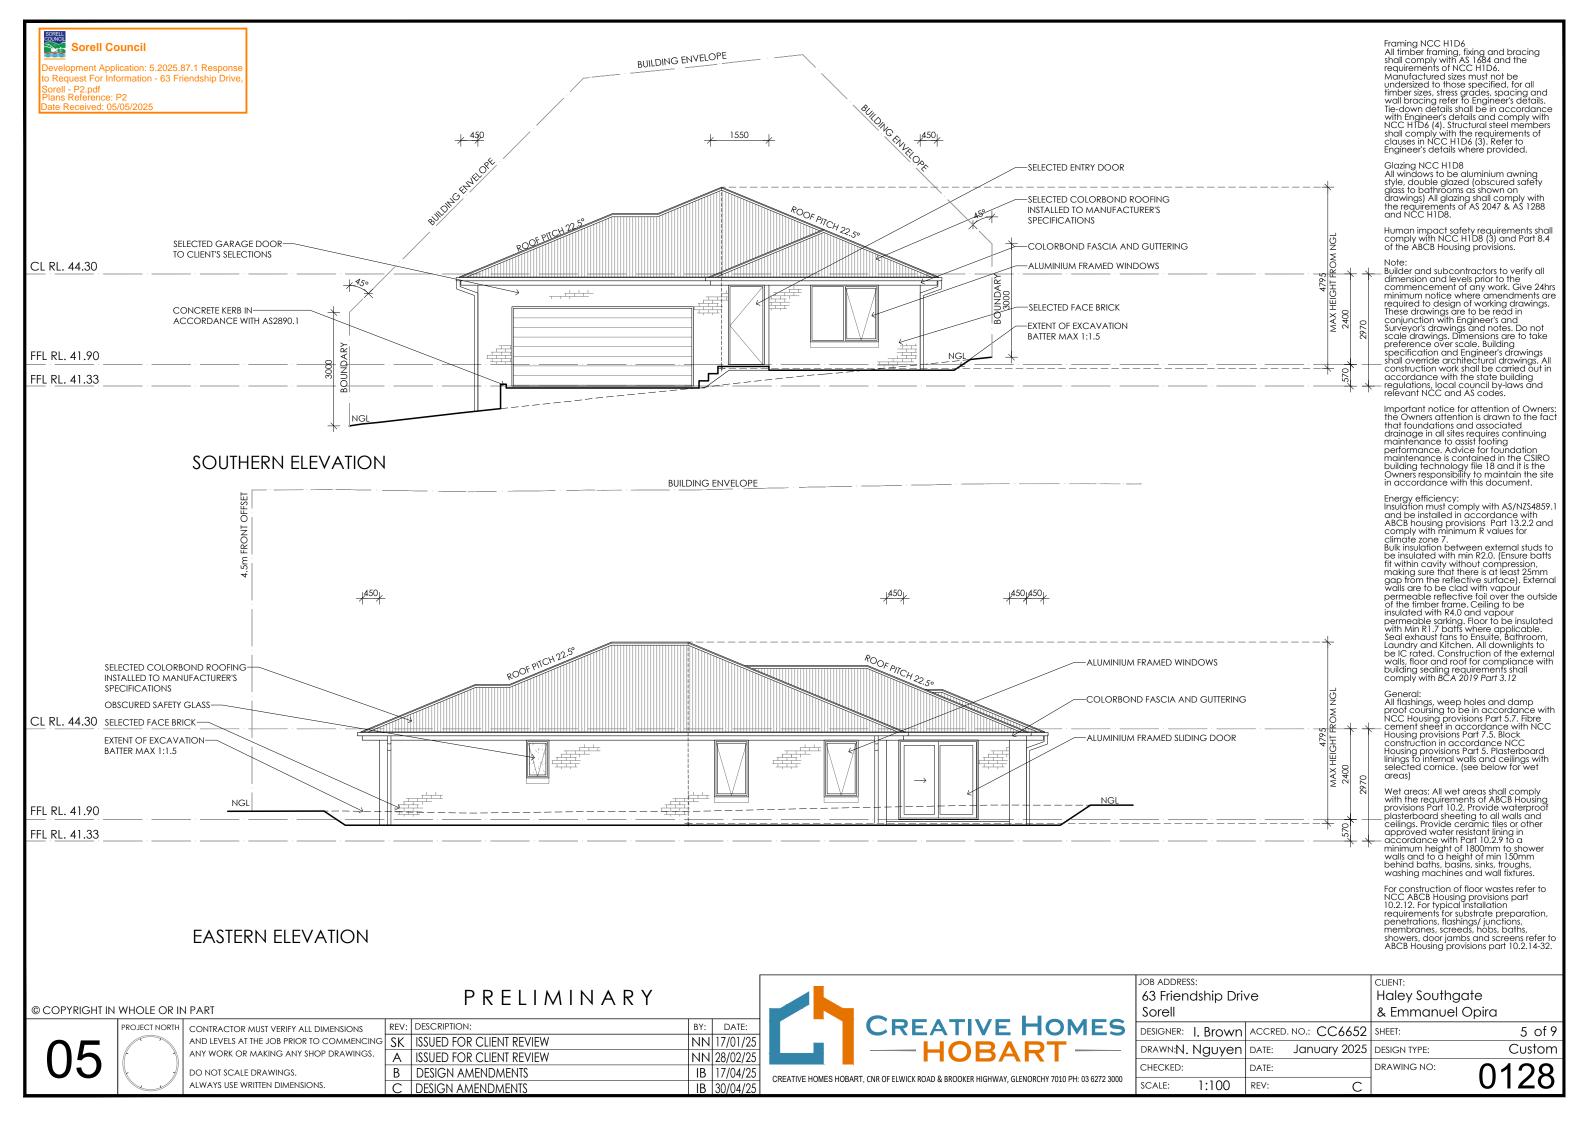

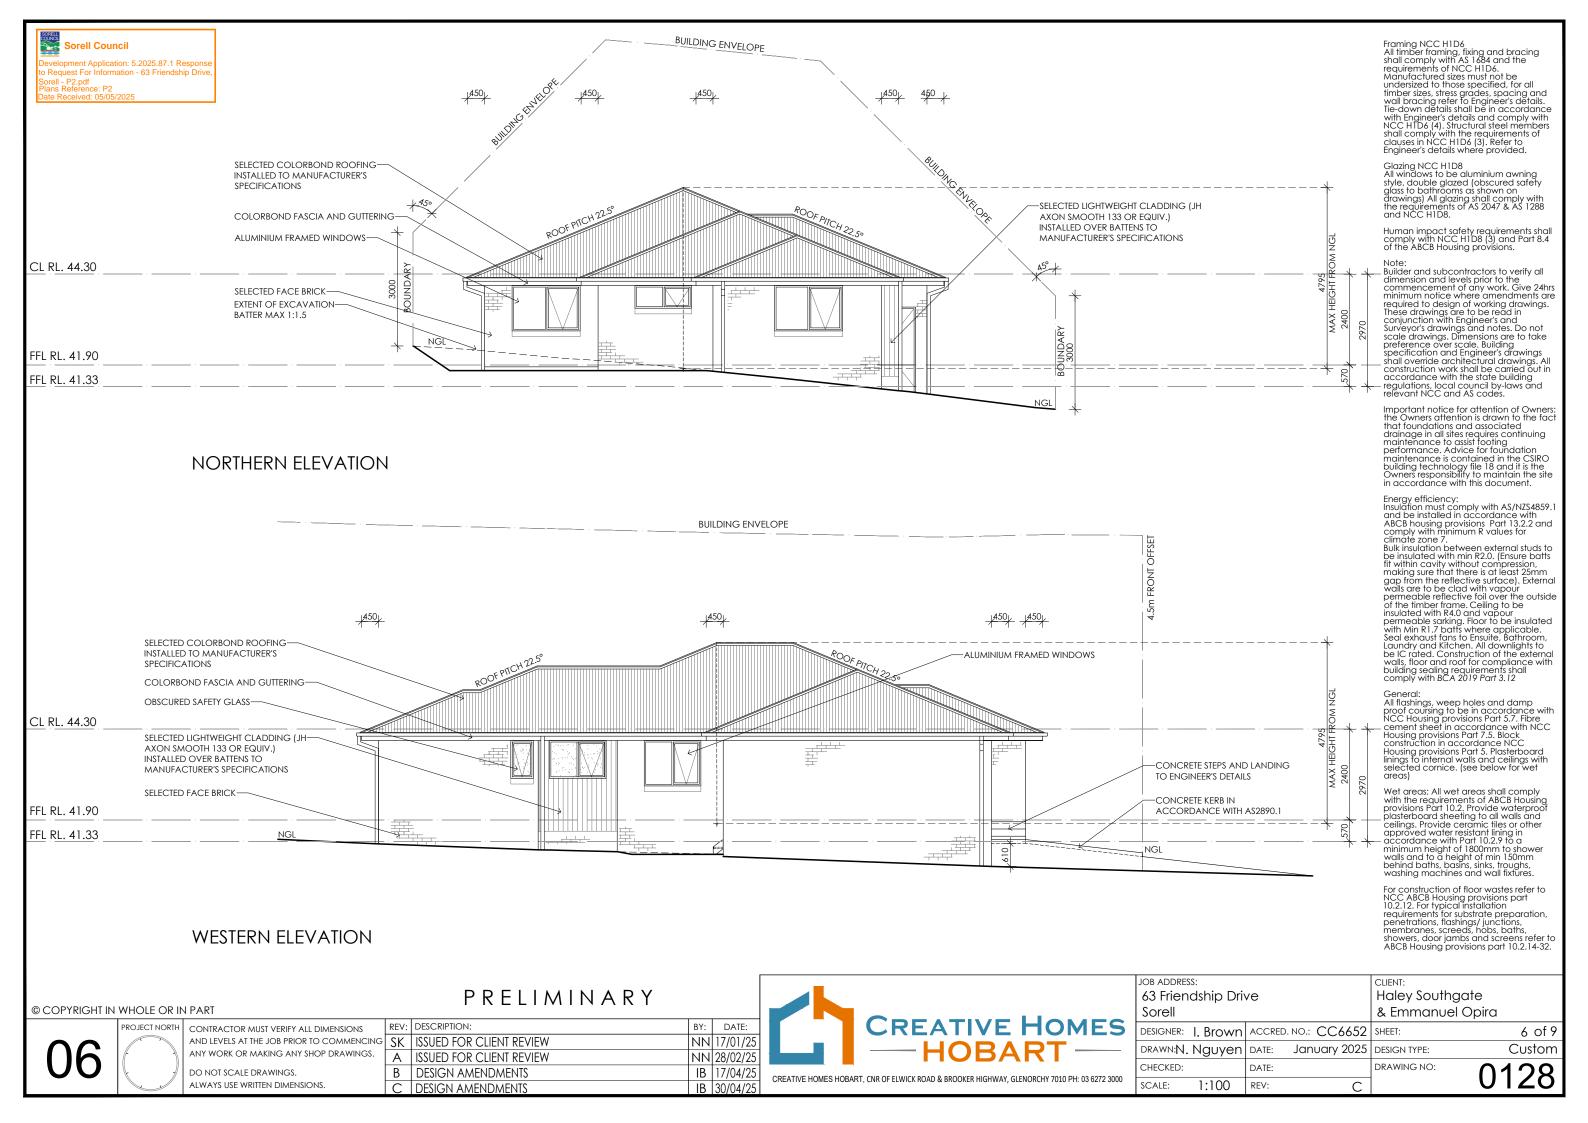

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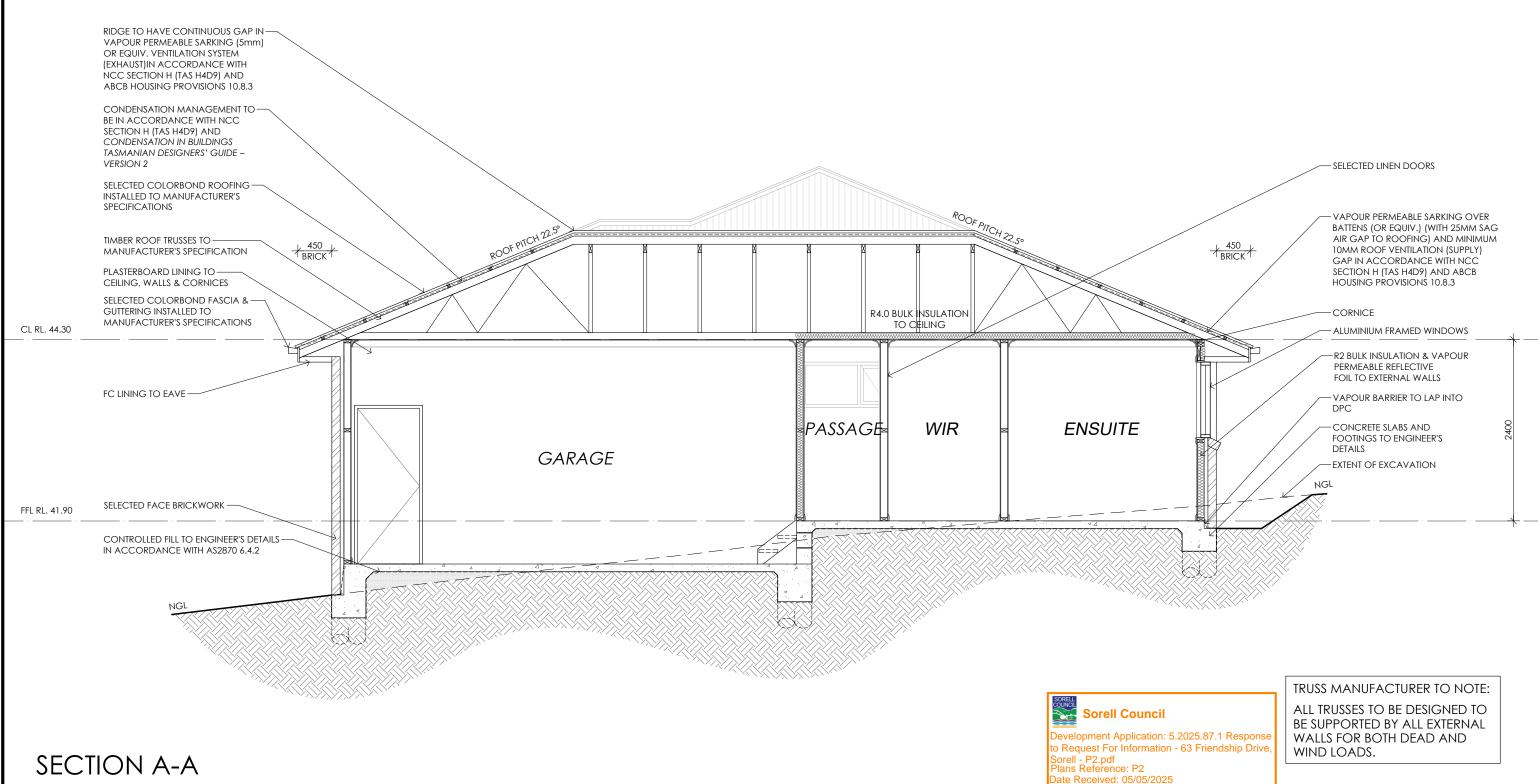
Energy efficiency:
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Bulk insulation between external studs to be insulated with min R2.0. (Ensure batts fit within cavity without compression, making sure that there is at least 25mm gap from the reflective surface). External walls are to be clad with vapour permeable reflective foil over the outside of the timber frame. Ceiling to be insulated with R4.0 and

vapour permeable sarking. Floor to be insulated with Min R1.7 batts where applicable. Seal exhaust fans to Ensuite, Bathroom, Laundry and Kitchen. All downlights to be IC rated. Construction of the external walls, floor and roof for compliance with building sealing requirements shall comply with BCA 2019 Part 3.12

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ANY WORK OR MAKING ANY SHOP DRAWINGS. DO NOT SCALE DRAWINGS. ALWAYS USE WRITTEN DIMENSIONS

CONTRACTOR MUST VERIFY ALL DIMENSIONS


REV: DESCRIPTION: DATE: BY: and levels at the job prior to commencing SK | ISSUED FOR CLIENT REVIEW NN 17/01/25 ISSUED FOR CLIENT REVIEW NN 28/02/25 B DESIGN AMENDMENTS IB 17/04/25 C DESIGN AMENDMENTS IB 30/04/25

PRELIMINARY




90	1: 05/05/2025		
	JOB ADDRESS: 63 Friendship Drive Sorell		CLIENT: Haley Southgate & Emmanuel Opira
	designer: I. Brown	ACCRED. NO.: CC6652	SHEET: 7 of 9
	DRAWN:N. Nguyen	DATE: January 2025	DESIGN TYPE: Custom
	CHECKED:	DATE:	DRAWING NO: 0128
	SCALE: 1:50	REV: C	0120

evelopment Application: 5.2025.87.1 Response to Request For Information - 63 Friendship Drive Sorell - P2.pdf Plans Reference: P2 Date Received: 05/05/2025

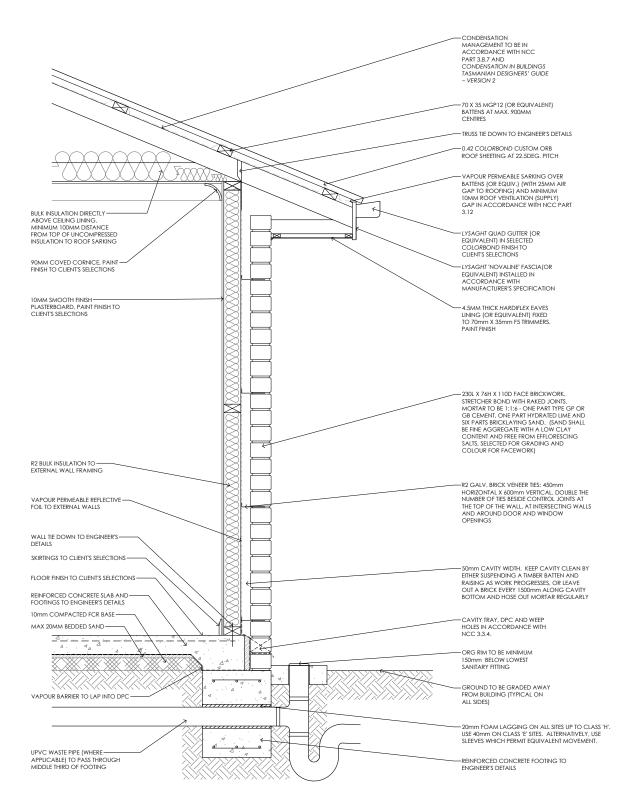

R2 BULK INSULATION TO EXTERNAL-WALL FRAMING VAPOUR PERMEABLE REFLECTIVE —R2 GALV. BRICK VENEER TIES: 450mm HORIZONTAL X 600mm VERTICAL. DOUBLE THE NUMBER OF TIES BESIDE CONTROL JOINTS AT THE TOP OF THE WALL, AT INTERSECTING WALLS AND AROUND DOOR AND WINDOW OPENINGS SELECTED ARCHITRAVE WITH TIMBER REVEAL -WEEP HOLES NOT MORE THAN 1200MM SPACING IN ACCORDANCE WITH NCC 3.3.4.

### WINDOW HEAD DETAIL SCALE 1:10

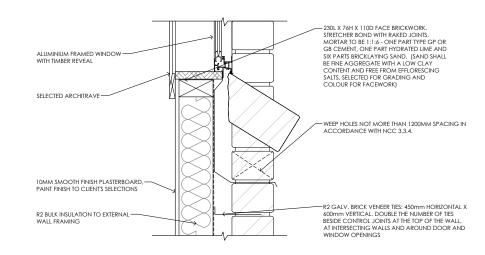

WINDOW SILL DETAIL SCALE 1:10

# FLOOR, WALL & ROOF DETAIL SCALE 1:20

# TYPICAL SECTION DETAILS

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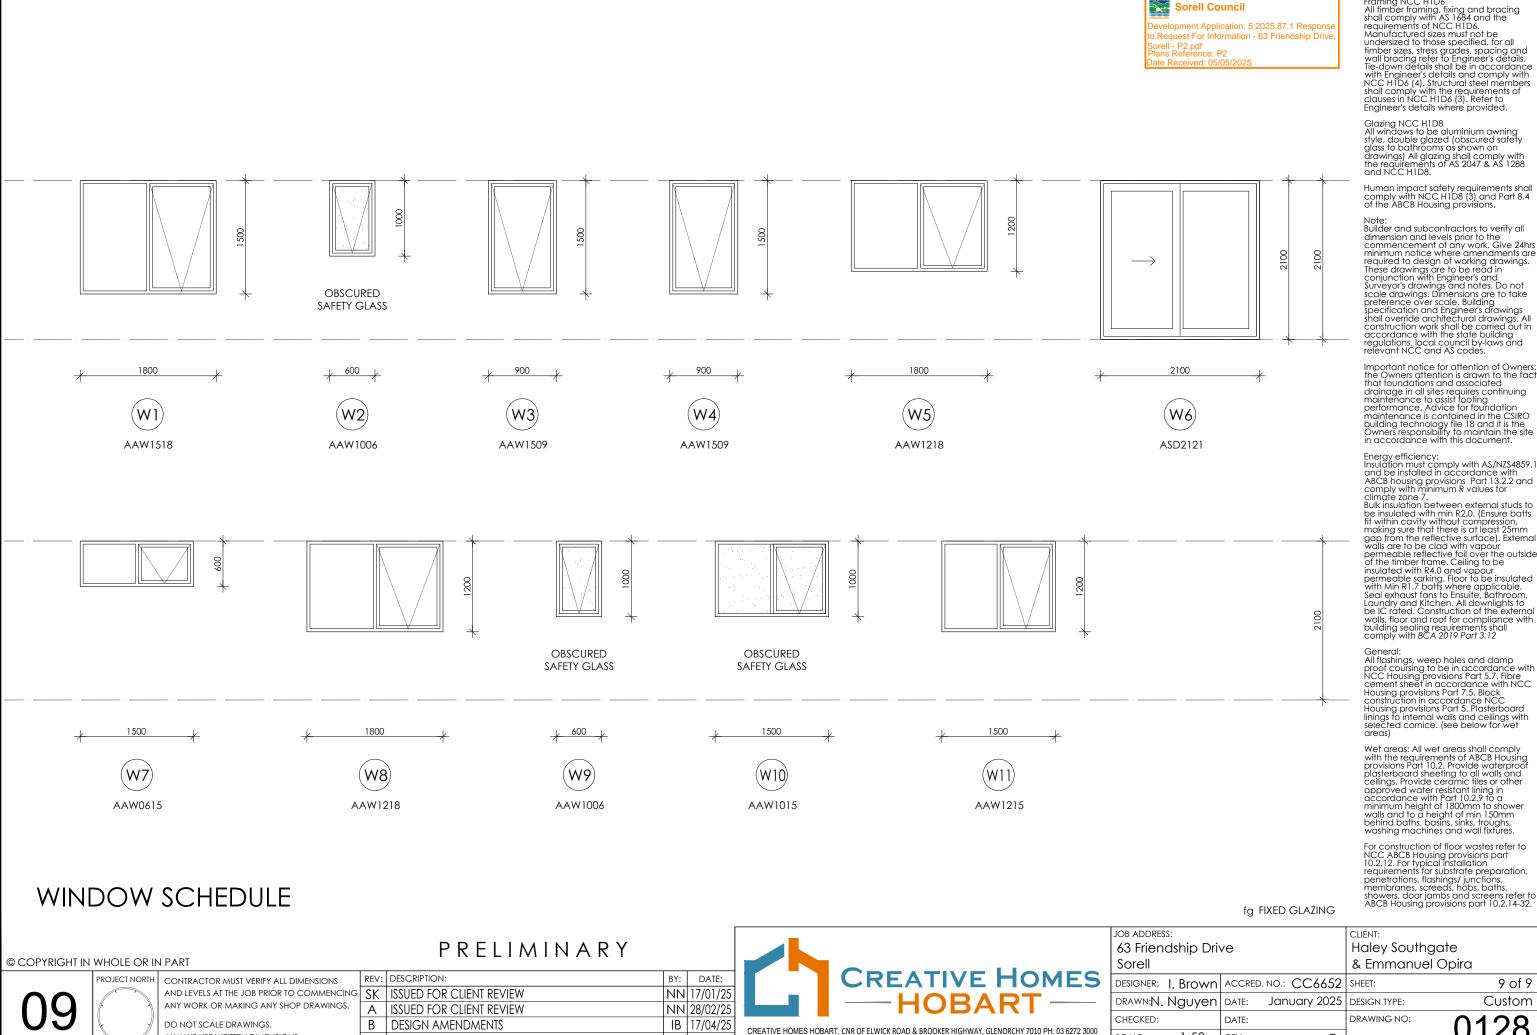
CONTRACTOR MUST VERIFY ALL DIMENSIONS

ANY WORK OR MAKING ANY SHOP DRAWINGS. DO NOT SCALE DRAWINGS. ALWAYS USE WRITTEN DIMENSIONS.

PRELIMINARY REV: DESCRIPTION: DATE: BY: AND LEVELS AT THE JOB PRIOR TO COMMENCING SK ISSUED FOR CLIENT REVIEW NN 17/01/25 A ISSUED FOR CLIENT REVIEW NN 28/02/25 B DESIGN AMENDMENTS IB 17/04/25 C DESIGN AMENDMENTS IB 30/04/25



JOB ADDRESS:		CLIENT:	
63 Friendship Driv	ve	Haley Southgate	
Sorell		& Emmanuel Opira	
designer: I. Brown	ACCRED. NO.: CC6652	SHEET: 8	of 9
DRAWN:N. Nguyen	DATE: January 2025	DESIGN TYPE: CU	stom
CHECKED:	DATE:	DRAWING NO:	Q
scale: AS SHOWN	REV: C	UIZ	20



IB | 30/04/25

ALWAYS USE WRITTEN DIMENSIONS

C DESIGN AMENDMENTS

Framing NCC H1D6
All timber framing, fixing and bracing shall comply with AS 1684 and the requirements of NCC H1D6.
Manufactured sizes must not be undersized to those specified, for all timber sizes stress grades spacing and timber sizes, stress grades, spacing and wall bracing refer to Engineer's details. Tie-down details shall be in accordance with Engineer's details and comply with NCC H1D6 (4). Structural steel members shall comply with the requirements of clauses in NCC H1D6 (3). Refer to Engineer's details where provided Engineer's details where provided.

Glazing NCC H1D8 All windows to be aluminium awning style, double glazed (obscured safety glass to bathrooms as shown on drawings) All glazing shall comply with the requirements of AS 2047 & AS 1288 and NCC H1D8.

Human impact safety requirements shall comply with NCC H1D8 (3) and Part 8.4 of the ABCB Housing provisions.

Builder and subcontractors to verify all Builder and subcontractors to verify all dimension and levels prior to the commencement of any work. Give 24hrs minimum notice where amendments are required to design of working drawings. These drawings are to be read in conjunction with Engineer's and Surveyor's drawings and notes. Do not scale drawings. Dimensions are to take preference over scale. Building specification and Engineer's drawings shall override architectural drawings. All construction work shall be carried out in accordance with the state building regulations, local council by-laws and relevant NCC and AS codes.

Important notice for attention of Owners the Owners attention is drawn to the fact that foundations and associated rada loundations and associated drainage in all sites requires continuing maintenance to assist footing performance. Advice for foundation maintenance is contained in the CSIRO building technology file 18 and it is the Owners responsibility to maintain the site in accordance with this document.

walls, floor and roof for compliance with building sealing requirements shall comply with BCA 2019 Part 3.12

General:
All flashings, weep holes and damp proof coursing to be in accordance with NCC Housing provisions Part 5.7. Fibre cement sheet in accordance with NCC Housing provisions Part 7.5. Block construction in accordance NCC Housing provisions Part 5. Plasterboard linings to internal walls and ceilings with selected comice. (see below for wet areas)

Wet areas: All wet areas shall comply with the requirements of ABCB Housing provisions Part 10.2, Provide waterproof plasterboard sheeting to all walls and ceilings. Provide ceramic tiles or other approved water resistant lining in accordance with Part 10.29 to a minimum height of 1800mm to shower walls and to a beight of 1810mm. walls and to a height of min 150mm behind baths, basins, sinks, troughs, washing machines and wall fixtures.

For construction of floor wastes refer to NCC ABCB Housing provisions part 10.2.12. For typical installation requirements for substrate preparation, penetrations, flashings/junctions, membranes, screeds, hobs, baths, showers, door jambs and screens refer transcript ABCB Housing provisions part 10.2.14-32.

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