

NOTICE OF PROPOSED DEVELOPMENT

Notice is hereby given that an application has been made for planning approval for the following development:

SITE: 31 Walker Street, Sorell

PROPOSED DEVELOPMENT:

THREE VISITOR ACCOMMODATION BUILDINGS, NEW OUTBUILDING & ADDITION TO EXISTING BUILDING

The relevant plans and documents can be inspected at the Council Offices at 47 Cole Street, Sorell during normal office hours, or the plans may be viewed on Council's website at www.sorell.tas.gov.au until **Monday 26th May 2025..**

Advertised in accordance with the Historic Cultural Act 1995

Any person may make representation in relation to the proposal by letter or electronic mail (sorell.council@sorell.tas.gov.au) addressed to the General Manager. Representations must be received no later than **Monday 26th May 2025.**

APPLICANT: Pooley'S Drafting Services

APPLICATION NO: DA 2023 / 310 1

DATE: 09 May 2025

Part B: Please note that Part B of this form is publicly exhibited.

Full description of Proposal:	Use: Commercial
	Development: Expansion to existing hotel accommodation, with the addition of 3x self contained units, + storage.
	<i>Large or complex proposals should be described in a letter or planning report.</i>
Design and construction cost of proposal:	\$ 500,000.00 (estimate)

Is all, or some the work already constructed:	No: <input checked="" type="checkbox"/> Yes: <input type="checkbox"/>
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Location of proposed works:	Street address: 31 Walker Street
	Suburb: Sorell, TAS Postcode: 7172
	Certificate of Title(s) Volume: 770657 Folio: 1

Current Use of Site	Commercial
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Current Owner/s:	Name(s) McGill & Aung PTY LTD
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Is the Property on the Tasmanian Heritage Register?	No: <input type="checkbox"/> Yes: <input checked="" type="checkbox"/>	<i>If yes, please provide written advice from Heritage Tasmania</i>
Is the proposal to be carried out in more than one stage?	No: <input checked="" type="checkbox"/> Yes: <input type="checkbox"/>	<i>If yes, please clearly describe in plans</i>
Have any potentially contaminating uses been undertaken on the site?	No: <input checked="" type="checkbox"/> Yes: <input type="checkbox"/>	<i>If yes, please complete the Additional Information for Non-Residential Use</i>
Is any vegetation proposed to be removed?	No: <input type="checkbox"/> Yes: <input checked="" type="checkbox"/>	<i>If yes, please ensure plans clearly show area to be impacted</i>
Does the proposal involve land administered or owned by either the Crown or Council?	No: <input checked="" type="checkbox"/> Yes: <input type="checkbox"/>	<i>If yes, please complete the Council or Crown land section on page 3</i>

If a new or upgraded vehicular crossing is required from Council to the front boundary please complete the Vehicular Crossing (and Associated Works) application form

<https://www.sorell.tas.gov.au/services/engineering/>




Sorell Council

Development Application: Development Application - 31 Walker Street, Sorell.pdf

Plans Reference: P1
Date Received: 7/11/2023

Part B continued: Please note that Part B of this form is publicly exhibited

Declarations and acknowledgements	
<ul style="list-style-type: none">• I/we confirm that the application does not contradict any easement, covenant or restriction specified in the Certificate of Title, Schedule of Easements or Part 5 Agreement for the land.• I/we consent to Council employees or consultants entering the site and have arranged permission and/or access for Council's representatives to enter the land at any time during normal business hours.• I/we authorise the provision of a copy of any documents relating to this application to any person for the purposes of assessment or public consultation and have permission of the copyright owner for such copies.• I/we declare that, in accordance with s52(1) of the <i>Land Use Planning and Approvals Act 1993</i>, that I have notified the owner(s) of the intention to make this application.• I/we declare that the information in this application is true and correct. <p><i>Details of how the Council manages personal information and how you can request access or corrections to it is outlined in Council's Privacy Policy available on the Council website.</i></p> <ul style="list-style-type: none">• I/we acknowledge that the documentation submitted in support of my application will become a public record held by Council and may be reproduced by Council in both electronic and hard copy format in order to facilitate the assessment process, for display purposes during public exhibition, and to fulfil its statutory obligations. I further acknowledge that following determination of my application, Council will store documentation relating to my application in electronic format only. <ul style="list-style-type: none">• Where the General Manager's consent is also required under s.14 of the <i>Urban Drainage Act 2013</i>, by making this application I/we also apply for that consent.	
Applicant Signature:	Signature:  Date: 07.11.2023

Crown or General Manager Land Owner Consent	
<p>If the land that is the subject of this application is owned or administered by either the Crown or Sorell Council, the consent of the relevant Minister or the Council General Manager whichever is applicable, must be included here. This consent should be completed and signed by either the General Manager, the Minister, or a delegate (as specified in s52 (1D-1G) of the <i>Land Use Planning and Approvals Act 1993</i>).</p> <p>Please note:</p> <ul style="list-style-type: none">• If General Manager consent is required, please first complete the General Manager consent application form available on our website www.sorell.tas.gov.au• If the application involves Crown land you will also need a letter of consent.• Any consent is for the purposes of making this application only and is not consent to undertaken work or take any other action with respect to the proposed use or development.	
<p>I _____ being responsible for the administration of land at _____ declare that I have given permission for the making of this application for _____</p>	
Signature of General Manager, Minister or Delegate:	Signature: _____ Date: _____



Sorell Council

Development Application: Development
Application - 31 Walker Street, Sorell.pdf

Plans Reference: P1
Date Received: 7/11/2023



Tel: 03 6237 0440

www.auswideconsulting.com.au

info@auswideconsulting.com.au

ABN 13 143 437 432



TRAFFIC AND PARKING ASSESSMENT

31 WALKER STREET, SORELL TAS 7172

CHANGE OF USE

Prepared for:	Chris Pooleys Drafting Services
Date Prepared:	April 2024
Revision:	1.0
LOCAL GOVERNMENT AREA Development Application:	TBA

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Restrictions on Use

This report has been prepared specifically for owners of 31 Walker Street, Sorell 7172 as the client. No part of this report may be referred to or quoted in any way without the written approval of the author. No party other than the owners of 31 Walker Street, Sorell 7172 may rely upon representation in this report for any purpose whatsoever, and the author accepts no liability for any such party relying upon this report.

Limits of Report

This report considers the particular instructions and requirements of our client. AusWide Consulting has taken care in the preparation of this report. However, it neither accepts liability nor responsibility whatsoever in respect of:

- Any use of this report by a third party,
- Any third party whose interests may be affected by any decision made regarding the contents of this report, and/or
- Any conclusion drawn resulting from omission or lack of full disclosure by the client, or the clients' consultants.

INTRODUCTION

AusWide Consulting has been engaged by Chris Pooleys Drafting Services to prepare a Traffic and Parking Assessment to expand the existing accommodation at 31 Walker Street, Sorell Tasmania 7172, with three self-contained cottages, and a storage shed, while extending the existing reception building as well as associated improvements to the driveway.

This report is to address points 1 and 2 from Sorell Council's request for information as follows:

1. Please provide an assessment discussing the traffic impact of the development, in particular stating the exact car parking deficiency (number) proposed with respect to the existing and proposed use. – C2.5.1 2.
2. Please detail dimensions for the proposed car parking spaces (bay width and lengths), and the combined access and manoeuvring width adjacent to parking spaces (aisle widths). – C2.6.1

BACKGROUND AND EXISTING CONDITIONS

The subject site is in a General Residential Zone with off-street parking and available on-street parking within the surrounding local access road network. **Figure 1** provides an overall view of the subject site and the general surrounding area.

Public Transport is provided via Carlton/Didges Ferry & Sorell to Hobart services. On route bus stops are within 5 min walk from the subject site, with park and ride facilities being a 10 min walk. These services provide access to services accessing the greater region and Hobart. **Figure 2** on the next page shows the Carlton/Didges Ferry & Sorell to Hobart services which are available from the subject site.

The current site has 5 fully furnished cottage style units and based on RTA Guide to Traffic Generating Developments, version 2.2, October 2002(RTA Guide), such accommodation generates 3 vehicle trips per unit, and 0.4 per unit for the evening peak hour. As such there is an existing traffic generation of 30 vehicles per day, and 4 vehicles per hour for the evening peak hour.

The subject site is accessible via a shared driveway easement with 6 residential properties behind the subject site. The RTA Guide provides a trip generation of 9 vehicle trips per dwelling and a weekday peak hour vehicle trip of 0.85 per building. Existing traffic generation is 70 vehicles per day, and 8.5 vehicles per hour for the evening peak hour.

Current traffic generated for the shared property access is in the order of 100 vehicles per day with an evening peak volume of 12.5 vehicles per hour.

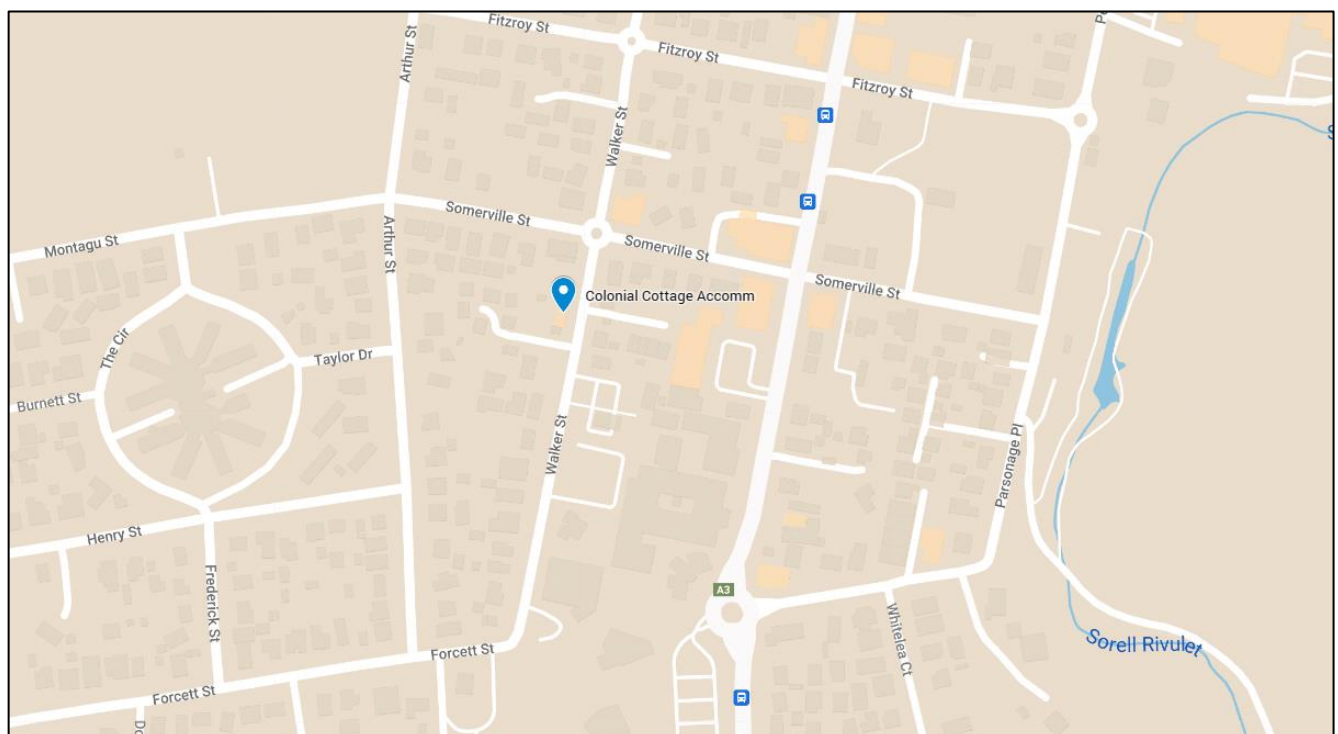


Figure 1 Site Location (Source: Google Maps)

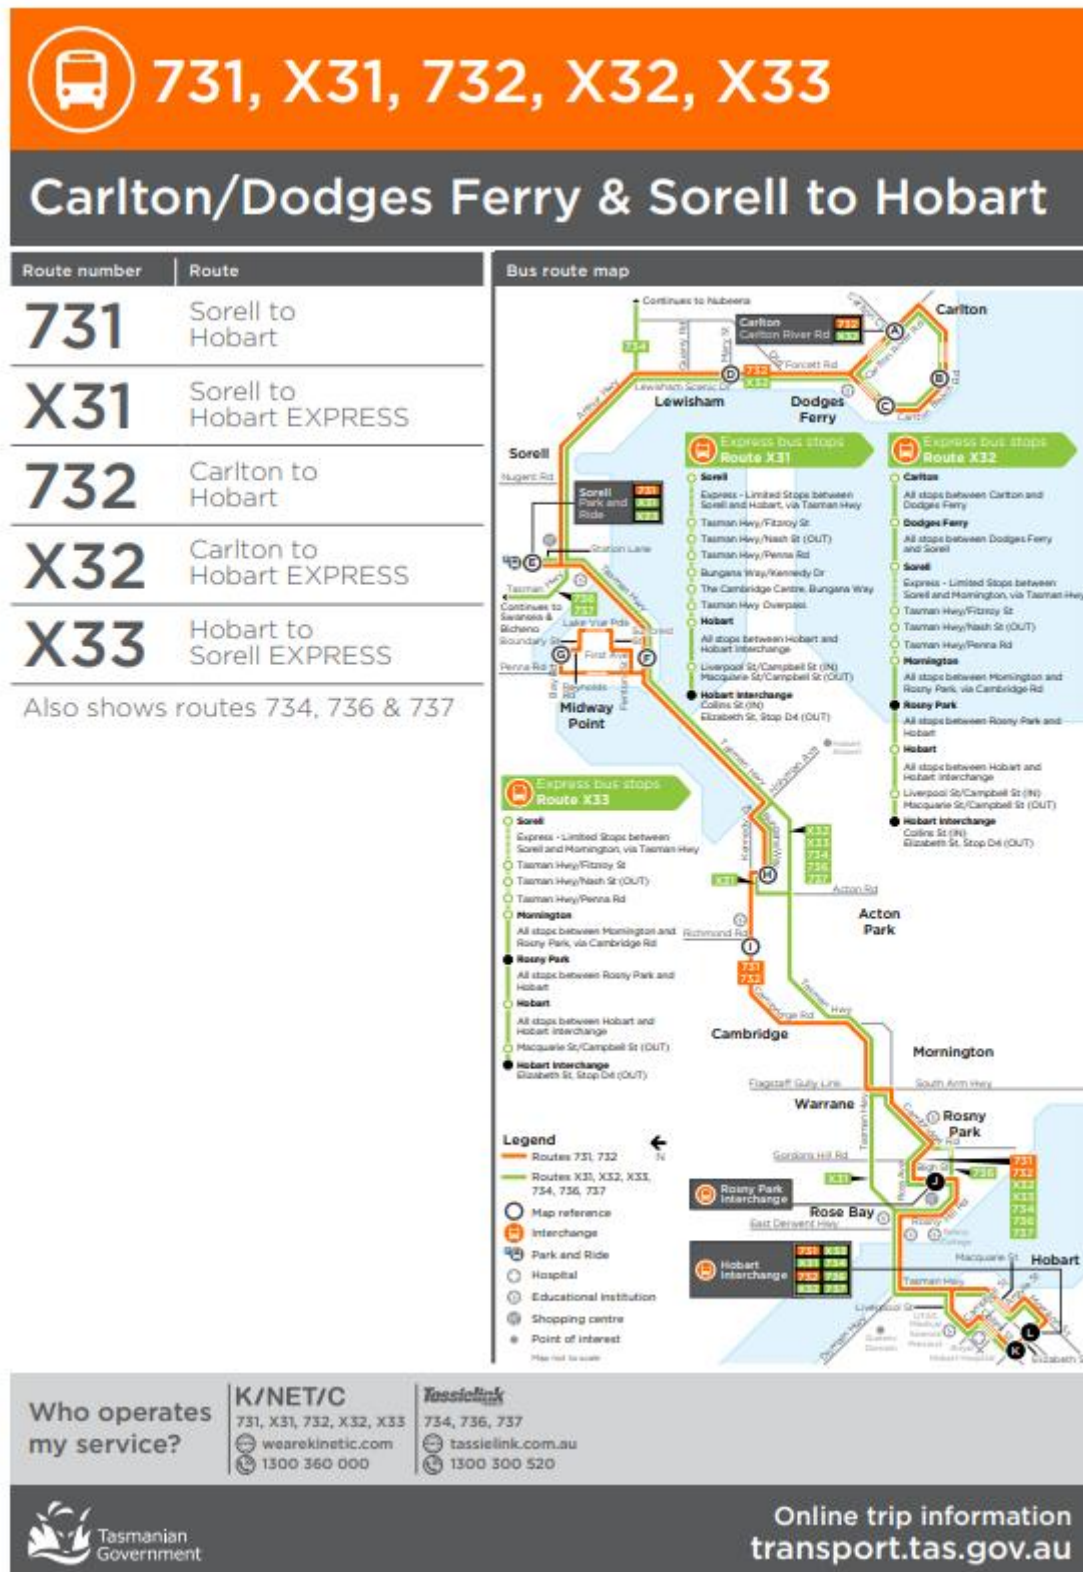


Figure 2 Transport Services (Source:

https://www.transport.tas.gov.au/public_transport/bus_timetables/south/carltondodges_ferry_and_sorell_to_hobart)

ROAD NETWORK

Walker Street follows a parallel connection with the Tasman Highway, linking the residential area to the South and West, with the General Business Zone to the East and North. There is no specific directional priority, with the intersections of Somerville Street and Fitzroy Street being controlled by roundabouts. Due to its connection, linking the state road network and General Business Zones, Walker Street functions at a minor collector level of function.

Traffic Volume

An estimation of current volumes for Walker Street, between Arthur Street and Somerville Street, based on RTA Guide, and factoring a non-local traffic factor of 30% due to its collector road nature based on the following has been performed:

- Approximate collection of 110 properties at 9 vehicle trips per day, accessing Walker Street = Average Daily Total 1980 vpd.
- South East Trade Training Centre, Sorell Campus and Sorell School, assume 500 student average. AM trips at 0.52 vehicle trips, PM trips at 0.42 vehicle trips. 50% directional split = ADT 238 vpd.¹
- 15% Non-local traffic = ADT 333 vpd.
- Peak hour factor = 12%.

Existing traffic volume on Walker Street, between Arthur Street and Somerville Street is estimated at ADT 2551 vpd, with a peak hour volume of 306 vph.

Future Development traffic Generation

The subject site proposes the construction of 3 cottages and thus will increase traffic generation by 18 vehicles per day, with 1.2 vehicles per hour during the evening peak hour. The storage shed and extension to the reception is not considered to factor into traffic generation.

Intersection Performance - Walker Street and Somerville Street Roundabout

The intersection of Walker Street and Somerville Street is the limiting extent of influence for the subject site. Visitors using the accommodation are likely to approach from the Tasman Highway, via Somerville Street and Walker Street.

SIDRA analysis has been performed based on the following assumptions:

- The assumption of relatively consistent and equivalent approach volumes has been assumed for the intersection, with a 50% split on all approaches = 176 veh/hr approach volumes on all legs. 10% heavy vehicles are assumed for the analysis.

Table 1 on page 9 details the movement summary of the intersection.

¹ Roads and Maritime Services Trip Generation Surveys Schools Analysis Report.

MOVEMENT SUMMARY

 Site: 101 [Walker Street and Somerville Street Intersection]

New Site
Site Category: (None)
Roundabout

Movement Performance - Vehicles

Mov ID	Turn	Demand Flows Total veh/h	HV %	Deg Satn v/c	Average Delay sec	Level of Service	95% Back of Queue Vehicles veh	Distance m	Prop. Queued	Effective Stop Rate	Aver. No. Cycles	Average Speed km/h
South: Walker Street												
1	L2	35	10.0	0.323	8.4	LOS A	1.6	11.9	0.48	0.72	0.48	41.6
2	T1	53	10.0	0.323	7.9	LOS A	1.6	11.9	0.48	0.72	0.48	42.2
3	R2	88	10.0	0.323	10.5	LOS B	1.6	11.9	0.48	0.72	0.48	41.9
Approach		176	10.0	0.323	9.3	LOS A	1.6	11.9	0.48	0.72	0.48	41.9
East: Somerville Street												
4	L2	53	10.0	0.332	8.7	LOS A	1.6	12.4	0.51	0.74	0.51	41.5
5	T1	35	10.0	0.332	8.2	LOS A	1.6	12.4	0.51	0.74	0.51	36.9
6	R2	88	10.0	0.332	10.9	LOS B	1.6	12.4	0.51	0.74	0.51	35.4
Approach		176	10.0	0.332	9.7	LOS A	1.6	12.4	0.51	0.74	0.51	37.9
North: Walker Street												
7	L2	35	10.0	0.350	9.4	LOS A	1.7	13.1	0.55	0.76	0.55	34.7
8	T1	88	10.0	0.350	8.9	LOS A	1.7	13.1	0.55	0.76	0.55	41.7
9	R2	53	10.0	0.350	11.6	LOS B	1.7	13.1	0.55	0.76	0.55	35.0
Approach		176	10.0	0.350	9.8	LOS A	1.7	13.1	0.55	0.76	0.55	38.7
West: Somerville Street												
10	L2	35	10.0	0.349	9.4	LOS A	1.7	12.9	0.55	0.76	0.55	34.9
11	T1	88	10.0	0.349	8.9	LOS A	1.7	12.9	0.55	0.76	0.55	36.7
12	R2	53	10.0	0.349	11.6	LOS B	1.7	12.9	0.55	0.76	0.55	40.3
Approach		176	10.0	0.349	9.8	LOS A	1.7	12.9	0.55	0.76	0.55	37.7
All Vehicles		703	10.0	0.350	9.7	LOS A	1.7	13.1	0.52	0.75	0.52	39.2

Site Level of Service (LOS) Method: Delay (SIDRA). Site LOS Method is specified in the Parameter Settings dialog (Site tab).
Roundabout LOS Method: SIDRA Roundabout LOS.
Vehicle movement LOS values are based on average delay per movement.
Intersection and Approach LOS values are based on average delay for all vehicle movements.
Roundabout Capacity Model: SIDRA Standard.
SIDRA Standard Delay Model is used. Control Delay includes Geometric Delay.
Gap-Acceptance Capacity: SIDRA Standard (Accel/M3D).
HV (%) values are calculated for All Movement Classes of All Heavy Vehicle Model Designation.

Table 1 Movement Summary

The current intersection has significant capacity to meet the negligible increase in traffic volumes due the development.

Level of Service

The roundabout of Walker Street and Somerville Street currently operates at a Level of Service A, with no change to level of service due to the increased traffic volume attributed to the proposed development.

Crash History

A search of crash history for Walker Street and the roundabout with Somerville Street reveals 2 recorded crashes at the roundabout and 7 crashes occurring on Walker Street, between Arthur Street and Somerville since 2009. It is noted that there are no crash clusters identified. While crashes do occur, the instances of crashes are relatively random with no identifiable major contributor to crashes.²

IMPACT ON TRANSPORT NETWORK

Overall, the subject site is consistent with land use characteristics and is of modest size and increase in current use. Due to current site constraints, there is insufficient capacity for significant growth likely to reduce the service life of the surrounding transport infrastructure. As such, the impact on of the development on the surrounding transport network is insignificant.

ACTIVE AND PUBLIC TRANSPORT

A search of the walkability of the subject site has revealed a walk score of 58 out of 100.³ This means that the location is somewhat walkable and that some errands can be accomplished on foot. However, it is noted that a significant proportion of the business and residential zones are within a 15 min walk from the subject site, as can be seen in **Figure 3** below.

As such, the option of active travel for staff commutes and visiting guests is very convenient.

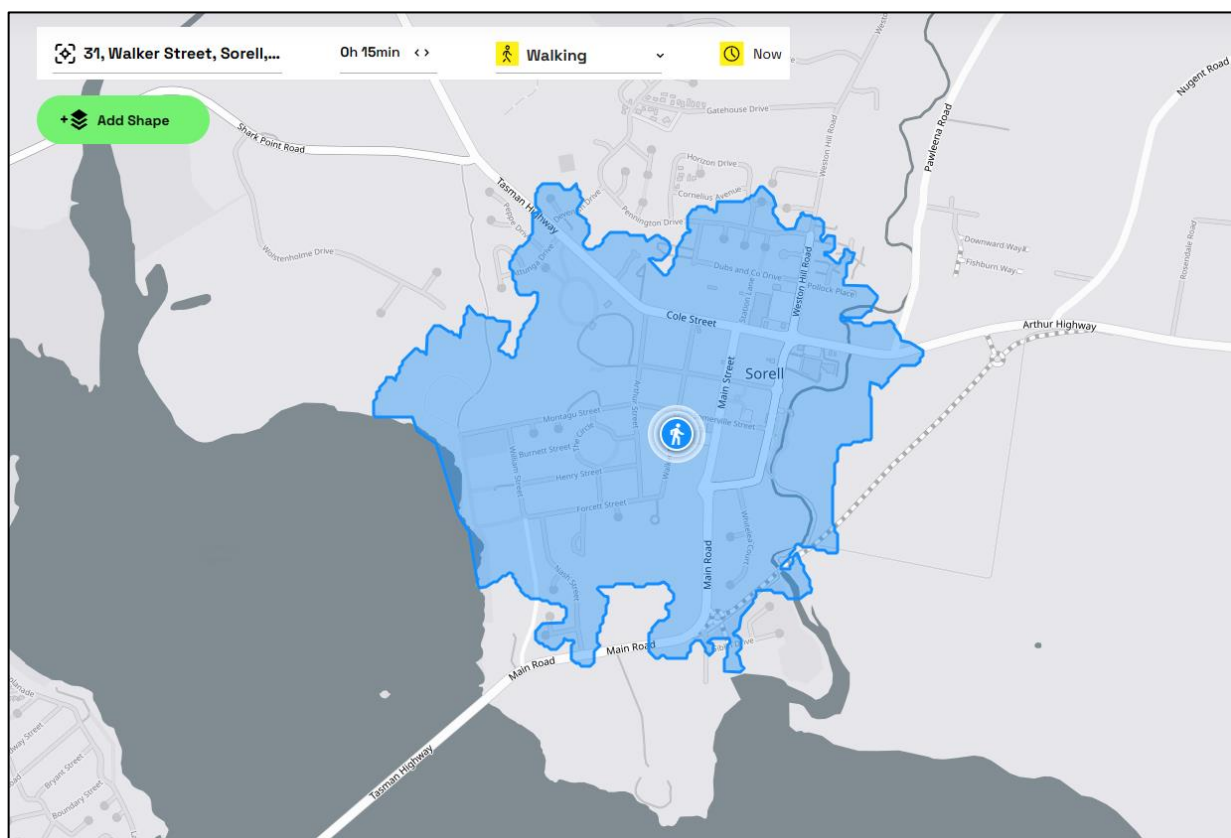


Figure 3 Travel Time Map (Source: <https://app.traveltime.com/search/0-lng=147.55990&0-tt=15&0-mode=ferry&0-title=31%2C%20Walker%20Street%2C%20Sorell%2C%20Hobart%2C%20Sorell%2C%20Tasmania%2C%207172%2C%20Australia&0-lat=-42.78467>)

Public Transport is relatively limited in the local area. This is likely due to the size of Sorell being roughly a 15 min walk to cover the urban area. However, there is good provision of public

³ <https://www.walkscore.com/score/31-walker-st-sorell-tas-australia>

transport providing services to regional and metropolitan extents from the Carlton/Didges Ferry & Sorell to Hobart services.

PARKING DEMAND

The subject site is classes as Visitor Accommodation, according to Tasmanian Planning Scheme – State Planning Provisions, Table C2.1 Parking Space Requirements. See **TABLE 2** below:

Use	Parking Space Requirements	
	Car	Bicycles
Visitor Accommodation	1 Space per self-contained accommodation unit, allocated tent or caravan space, or 1 space per 4 beds, whichever is the greater.	No requirement

Table 2 Visitor Accommodation Parking Space Requirements

The existing land use currently accommodates 5 cottage style units, with the proposed change of use to include another 3 cottage style units, totalling 8 cottage style units. A total of 8 parking spaces is required for the subject site.

A total of 8 parking bays are detailed on the proposed site plan, and as such there is appropriate off-street provided for the proposed development.

OFF-STREET PARKING LAYOUT

The proposed parking layout consists of nine, 90 degree angle parking spaces, along a parking isle. Parking modules are based on user class 2 car parking facilities according to AS/NZS 2890.1, Table 1.1. The following minimum parking dimensions are required:

- Isle Width = 5.8m.
- Bay Width = 2.5m.
- Bay Length = 5.4m (No overhang) = 4.8m (With overhang).

Dimension reviewed form the proposed site plan are as follows:

- Bay 1 to 3 requires minimum 5.4m bay length and this is achieved.
- Bay 4 to 8 allows for overhang, allowing bay length of 4.8m and this is achieved.
- Minimum isle width of 5.8 is required and this is achieved with existing minimum width of 11m from parking bay 4 to 8, providing 6.2m isle width. Exceeding minimum isle width required.
- Bay width = 2.6m and exceeds minimum 2.5m bay width.

The off-street parking layout dimensions are compatible with AS/NZS 2890.1. **Figure 4** on page 12 shows general dimensions.

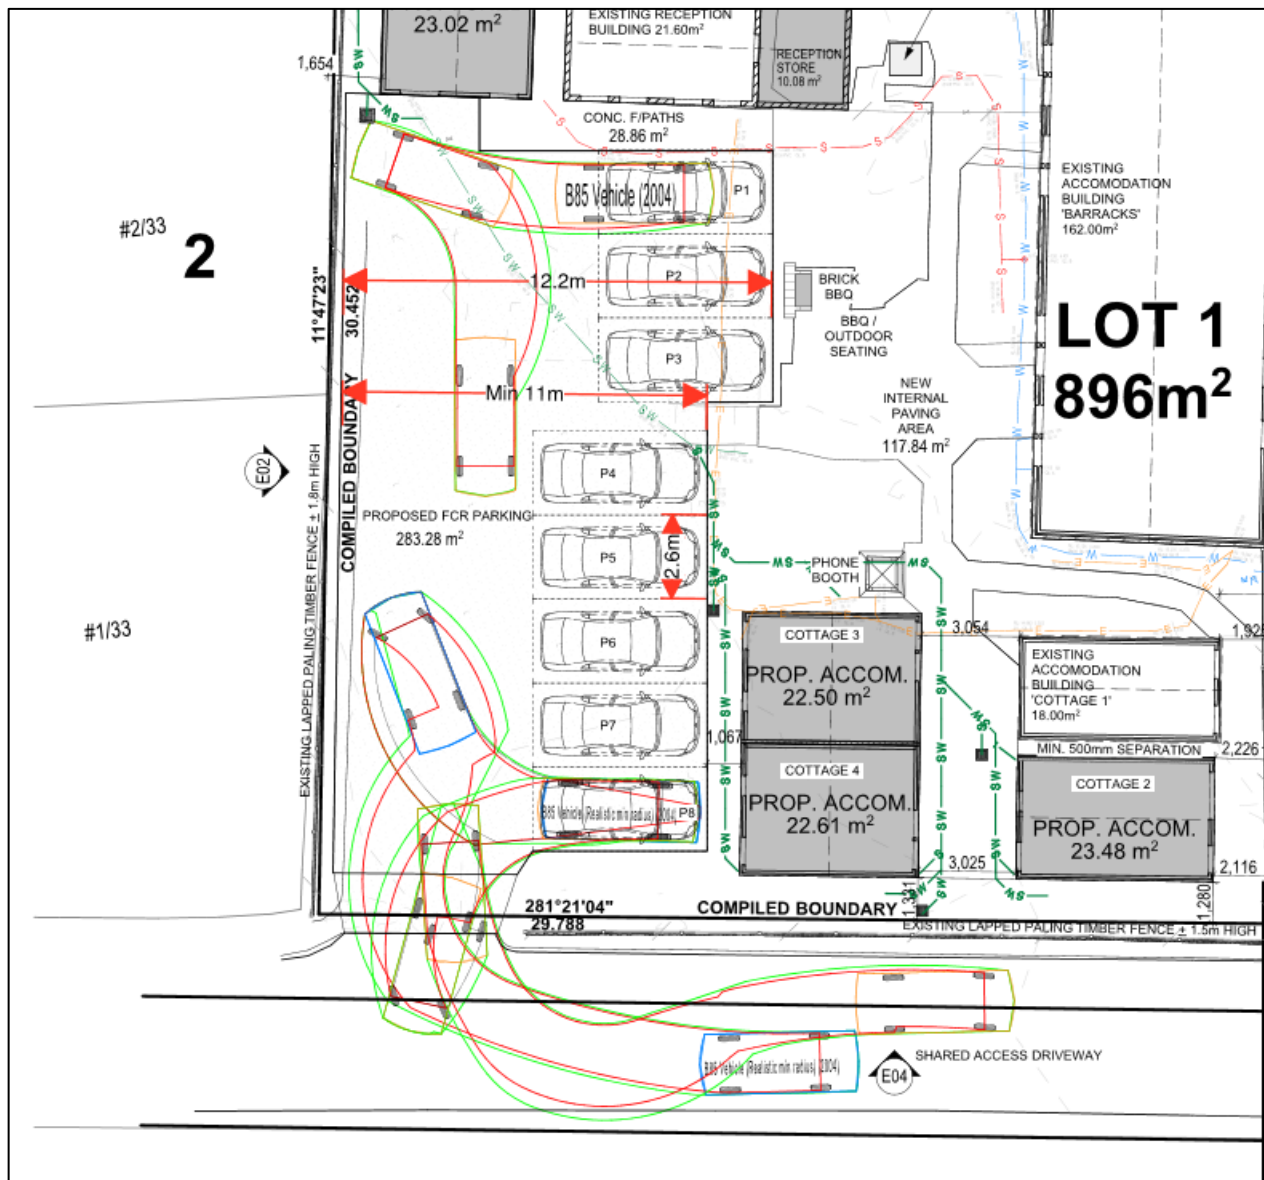


Figure 4 General Dimensions of Car Park


CONCLUSIONS

Based on the assessment presented in this report, it is considered that:

- The proposed development is consistent with land use zoning;
- Traffic generated by the proposed development is unremarkable;
- Level of Service for the roundabout of Walker Street and Somerville Street remains unchanged at LOS A, with increased traffic volumes generated by the proposed development;
- Existing crash history shows no indication of environmental factors contributing to crashes, that would be affected by the proposed development;
- The minimum off-street parking required for the proposed development is provided;
- Proposed off-street parking area provides sufficient space for compliance with AS/NZS 2890.1;

In conclusion, this report indicates the proposed change in land use is not envisaged to have adverse impacts on the surrounding traffic or parking conditions. Therefore, the proposal should be supported on traffic and parking grounds.

Appendix A – PROPOSED SITE PLAN

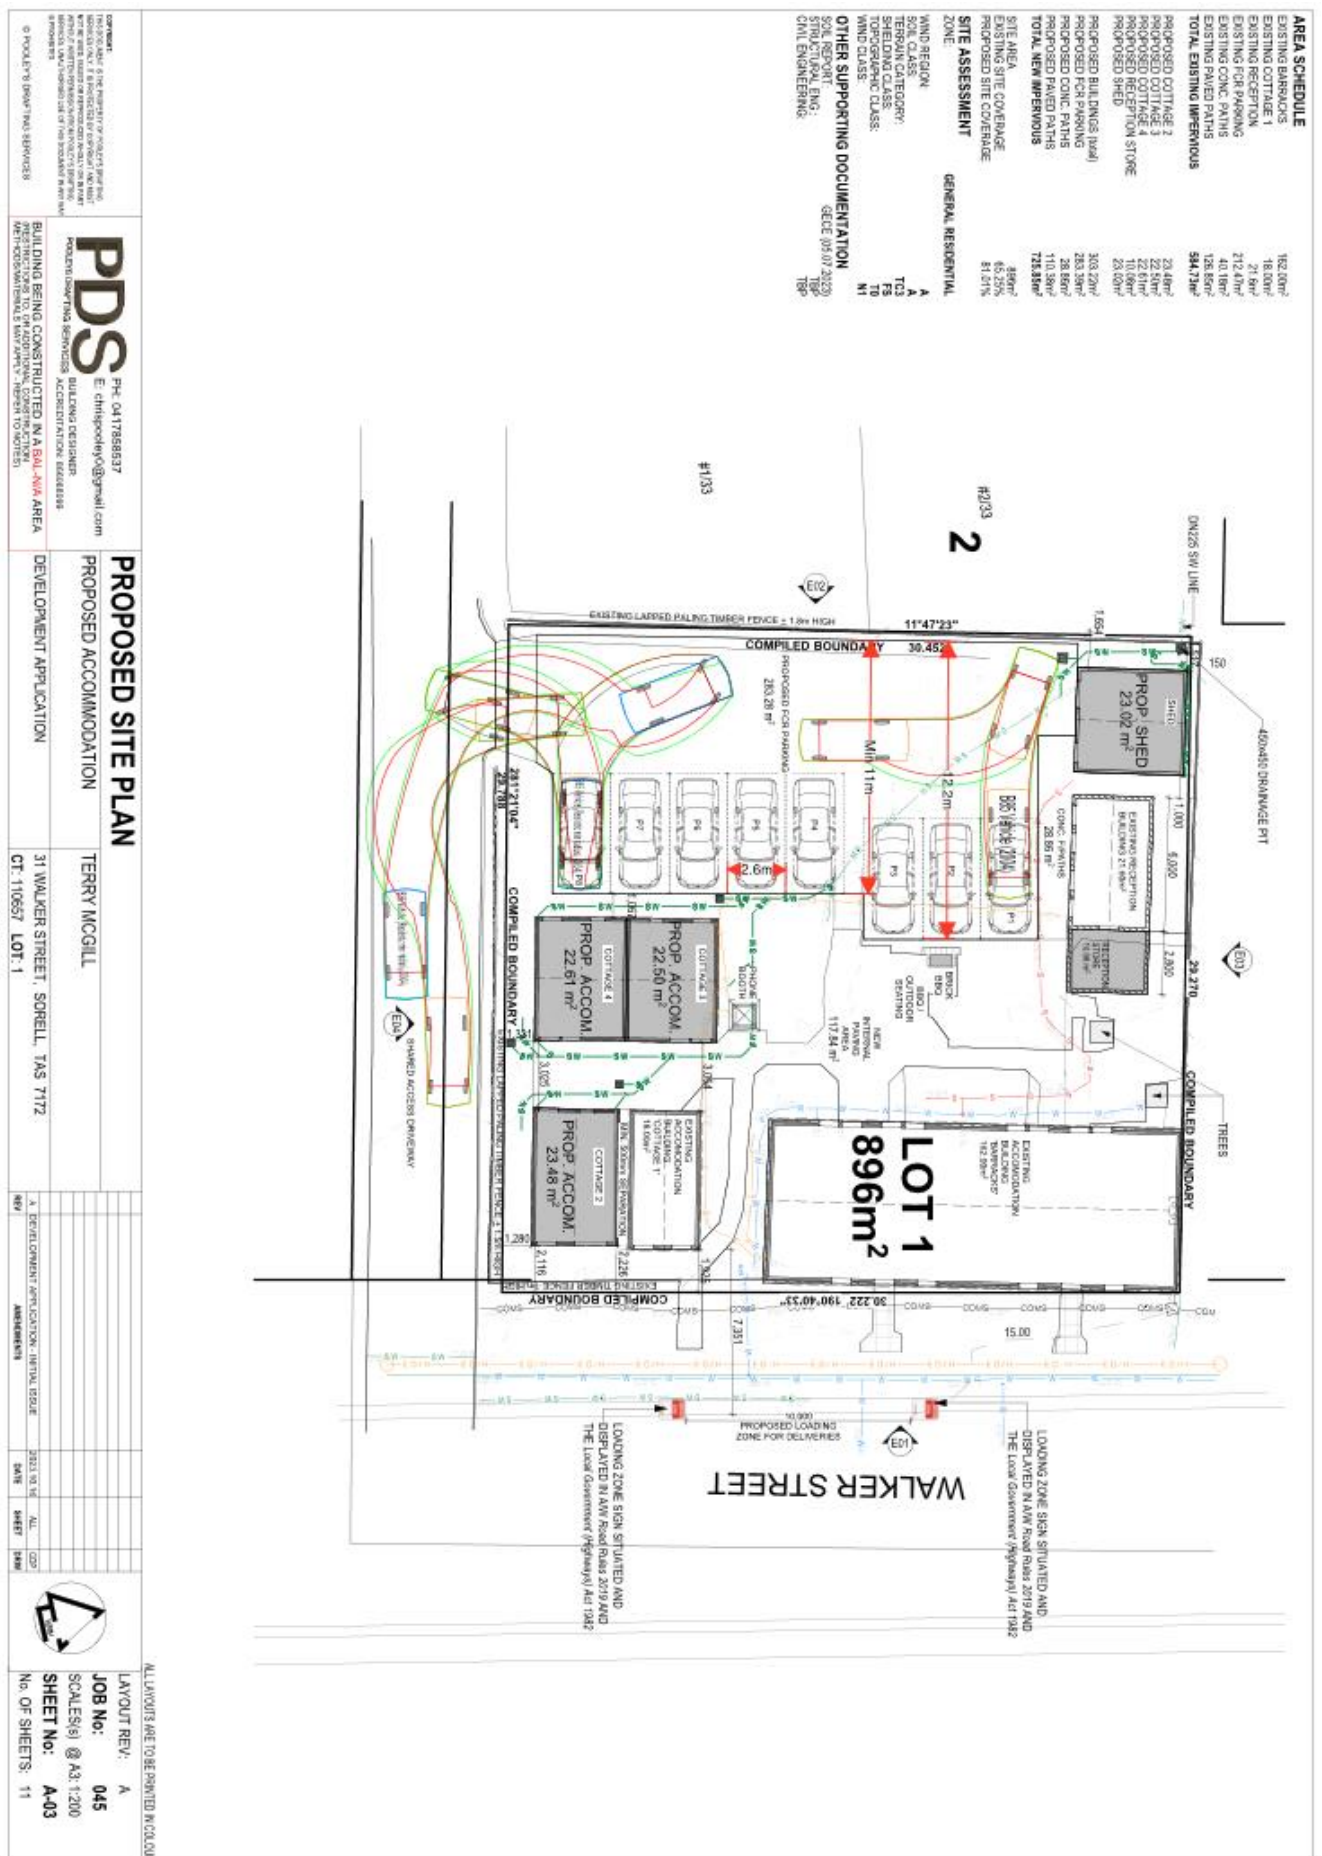


31 WALKER ST, SORELL, TAS 7172

CIVIL ENGINEERING DRAWINGS

DRAWINGS CONTENTS LIST

C00	GECE COVER SHEET
C01	NOTES
C02	GENERAL ARRANGEMENT
C03	PARKING PLAN
C04	DRIVEWAY SWEPT PATHS - IN
C05	DRIVEWAY SWEPT PATHS - OUT
C06	DRIVEWAY CONSTRUCTION DETAILS
C07	KERB DETAILS

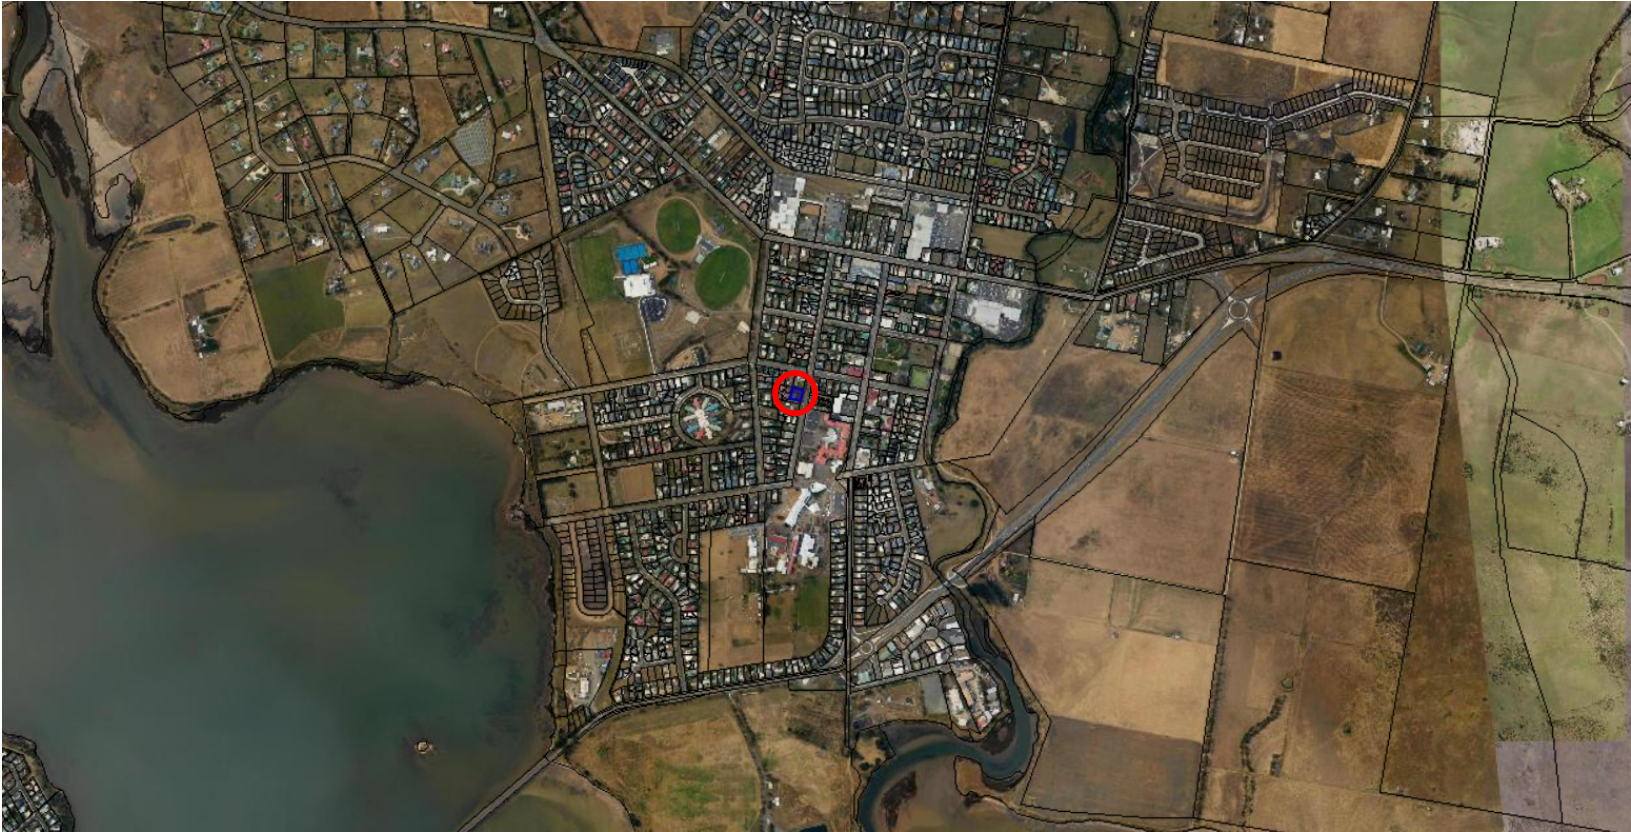

LOCATION PLAN

SCALE: 1:20000

**Sorell Council**

Development Application: 5.2023.310.1 -
Response to Request For Information - 31
Walker Street, Soress - P2.pdf
Plans Reference: P2
Date received: 28/04/2025

NOTE: THIS SET OF DRAWINGS SHOULD ALWAYSBE PRINTED IN COLOUR.

					<div><div><div><div><div>GE</div></div><div>CONSULTING ENGINEERS</div></div><div>+ CIVIL + STRUCTURAL</div><div><div>gcece.com.au</div></div></div><div><div>ABN64 629 573 897 ACN 629 573 897 42 SANDY BAY ROAD BATTERY POINT, TAS 7005 ADMIN@GECE.COM.AU 0412 705 240</div></div></div>	© copyright GE CONSULTING ENGINEERS	ENGINEER: A.G-E.	SCALE: 1:20000	PROJECT: 31 WALKER ST, SORELL, TAS 7172	DRAWING TITLE: GECE COVER SHEET	
							DRAFTER: CP	SIZE: A3		PROJECT No. 045	DWG No. C00
00	ISSUED FOR CONSTRUCTION		CP	A.G-E.	30.09.2024						
REV	ISSUE DESCRIPTION		ISSUE DRAWN BY	CHK	DATE		STATUS: BUILDING APPLICATION			REVISION: 00	

CIVIL NOTES

GENERAL

1. ALL WORKS TO BE CARRIED OUT IN ACCORDANCE WITH IPWEA STANDARD DRAWINGS AND SPECIFICATIONS, AND TO THE SATISFACTION OF COUNCIL'S DEVELOPMENT ENGINEER.
2. ALL EXISTING SERVICES TO BE LOCATED ON SITE PRIOR TO THE COMMENCEMENT OF WORKS.
3. ALL WORKS TO BE UNDERTAKEN IN ACCORDANCE WITH THE WHS ACT 2012.
4. ALL WORKS TO BE UNDERTAKEN IN ACCORDANCE WITH THE ISSUED PLANNING PERMIT.
5. ALL WORKS TO BE UNDERTAKEN TO THE APPROPRIATE AUSTRALIAN STANDARDS, BEST PRACTICE GUIDELINES AND THE DERWENT ESTUARY SITE MANAGEMENT GUIDELINES.
6. ALL EARTHWORKS TO BE UNDERTAKEN IN ACCORDANCE WITH THE EARTHWORKS STANDARD AS3798. FOR PRIVATE LAND AND EITHER LGAT SPECIFICATIONS OR STATE GROWTH SPECIFICATIONS FOR PUBLIC LAND WHERE APPLICABLE.
7. FURTHER TO THE EARTHWORKS SPECIFICATION FOR EMBANKMENT CONSTRUCTION, THE EMBANKMENT SHALL BE INSTALLED OVERWIDTH AND CUT BACK TO ENSURE CONSISTENT COMPACTION ON THE BATTERS PRIOR TO TOPSOIL PLACEMENT.
8. WHEN BATTERS ARE CUT BACK THEY SHAL BE CUT BACK WITH A GP BUCKET AND SCORED HORIZONTAL / DIAGONAL TO HELP TOPSOIL REMAIN ON THE BATTER AND ASSIST IN GRASS GERMINATION AND GROWTH AND REDUCE THE LIKLYHOOD OF TOPSOIL LOSS.
9. THE TOPSOIL AND GRASS SEEDING SHALL BE UNDERTAKEN AS SOON AS POSSIBLE TO PREVENT / REDUCE EROSION AND WATERED AS PER THE MANUFACTURERS RECCOMENDATIONS FOR THE LOCAL ENVIRONMENT AND SEASON.

DRIVEWAY

1. DRIVEWAY SUBGRADE SHALL BE INSPECTED PRIOR TO PLACING OF GRAVEL.
2. ALL FILL BENEATH DRIVEWAY TO BE SUB BASE 1 - 40MM FCR.
3. CONCRETE & REINFORCING STEEL TO BE SUPPLIED AND INSTALLED IN ACCORDANCE WITH AS3600 AND MANUFACTURERS RECOMMENDATIONS.
4. CONCRETE STRENGTH AT 28DAYS IS TO BE 25MPa.
5. ALL GRAVEL SHALL BE SUPPLIED AND PLACED IN ACCORDANCE WITH PREVIOUS STATEGROWTH SPECIFICATION R40 UNLESS APPROVED OTHERWISE.
6. ALL GRAVELS SHALL BE COMPACTED IN MAXIMUM 150MM LAYERS USING A 2.5T ROLLER OR 300+KG FORWARD REVERSE PLATE.
7. TOLERENCE OF FINISHED SURFACE; +/- 50MM FROM DESIGN LEVEL, +/- 10MM DEVIATION WHEN MEASURING AGAINST 3M STRAIGHT EDGE.
8. SAW CUTS SHALL BE UNDERTAKEN WITHIN 24HOURS AND CUT DIRECTLY ABOVE THE CRACK INDUCERS.
9. ALL DRIVEWAY EDGES SHALL BE ROUNDED USING EDGING TOOL.
10. JOINTS SHALL BE PLACED TO THE LOCATIONS SPECIFIED.

STORMWATER

1. ALL WORKS TO BE CARRIED OUT IN ACCORDANCE WITH AS 3500.3:2021, IPWEA(TAS) MUNICIPAL STANDARD DRAWINGS AND SPECIFICATION AND TO THE SATISFACTION OF COUNCILS MUNICIPAL ENGINEER.
2. ALL EXISTING SERVICES TO BE LOCATED ON SITE PRIOR TO THE COMMENCEMENT OF WORKS.
3. GENERAL MATERIALS, INSTALLATION & TESTING SHALL COMPLY WITH ANY APPLICABLE COUNCIL PERMIT CONDITIONS, AS3500.3:2021 & TASMANIAN MUNICIPAL STANDARD DRAWINGS.
4. ALL PIPE WORK UNDER TRAFFICABLE AREAS, INCLUDING DRIVEWAYS IS TO BE BACKFILLED WITH FCR IN ACCORDANCE WITH THE DETAILS PROVIDED.
5. LOT CONNECTION TO BE DN150 uPVC INCORPORATE AN INSPECTION OPENING RAISED TO THE SURFACE U.N.O.
6. MINIMUM PIPE CLASS TO BE CLASS SN8.
7. ALL PITS LOCATED WITHIN THE TRAFFICABLE AREAS SHALL BE DRIVEABLE CLASS D.

WATER NOTES

1. THE PIPE ALIGNMENT AND EXISTING SERVICES SHALL BE FULLY LOCATED IN CONSIDERATION WITH ARCHITECTS PLANS PRIOR TO COMMENCEMENT TO ENSURE NO CLASHES EXISTS WITH OTHER SERVICES. CONFIRM FINAL LOCATION WITH SURVEYOR PRIOR TO START.
2. ALL WORKS SHALL BE UNDERTAKEN IN ACCORDANCE WITH TASWATER WATER SUPPLIMENT TO WSA 03-2011-3.1 MRWA v2.0 AND TW STANDARD DRAWINGS ON THE TASWATER DEVELOPMENT PORTAL, AS3500.1 WATER SERVICES AND TO THE SATISFACTION OF TASWATER'S DEVELOPMENT ENGINEER AND THE COUNCIL PLUMBING INSPECTOR FOR THEIR RESPECTIVE AREAS OF COMPLIANCE.
3. ALL PIPEWORK SHALL MEET THE WSA PS-215 & 216 SPECIFICATION.
4. ALL PIPEWORK SHALL BE PE100 CLASS PN16. A CONTINUOUS RUN, NO JOINS SHALL EXIST BETWEEN THE MANIFOLD AND THE DWELLING CONNECTION POINT (DCP_. REFER TO THE ARCHIETCURAL PLANS FOR THE EXACT LOCATION OF THE DCP.
5. LINEWORK SHOWN IS NOT EXACT AND MAY VARY TO WITH WITH SITE CONSTRAINTS.
6. MINIMUM COVER IS 500mm. LOCATOR TAPE SHALL BE PROVIDED OVER THE TOP OF THE TRENCH OF EACH SERVICE LINE. MINIMUM SEPERATION WITH OTHER SERVICES IS 300mm. WATER PIPE SPACING OF MIN. 100mm IS REQUIRED AND ALL PIPES SHALL HAVE A MIN. 100mm OF CLEAN 7mm BLUE METAL GRAVEL AROUND THEM.
7. ALL PIPEWORKS AND LAID PIPE SHALL BE PRESSURE TESTED IN ACCORDANCE WITH AS3500.1 AND TW GUIDELINES.
8. ALL WATER WORKS TO BE TASWATER AND COUNCIL APPROVED WORKS. CONTRACTOR TO ARRANGE FOR INSPECTIONS AND APPROVALS.

SEWER NOTES


1. THE PIPE ALIGNMENT AND EXISTING SERVICES SHALL BE FULLY LOCATED IN CONSIDERATION WITH ARCHITECTS PLANS PRIOR TO COMMENCEMENT TO ENSURE NO CLASHES EXISTS WITH OTHER SERVICES. CONFIRM FINAL LOCATION WITH SURVEYOR PRIOR TO START.
2. ALL WORKS SHALL BE UNDERTAKEN IN ACCORDANCE WITH TASWATER SEWER SUPPLIMENT TO WSA 02-2014-3.1 V2 AND TW STANDARD DRAWINGS ON THE TASWATER DEVELOPMENT PORTAL, AS3500.2:2021 SANITARY PLUMBING AND SRAINAGE AND TO THE SATISFACTION OF TASWATER'S DEVELOPMENT ENGINEER AND THE COUNCIL PLUMBING INSPECTOR FOR THEIR RESPECTIVE AREAS OF COMPLIANCE.
3. ALL PIPEWORK AND FITTINGS SHALL BE DN100 UPVC DWV SN8, JOINS SHALL BE SCJ INSPECTION OPENINGS SHALL BE LOCATED AS SHOWN.
4. NO 90 DEGREE BENDS ALLOWED WITHOUT APPROVAL (INCLUDING FOR INSPECTION OPENINGS).
5. MINIMUM COVER IS 600mm
6. MINIMUM FALL IS 2%
7. COUNCIL'S PLUMBING INSPECTOR SHALL BE CONTACTED PRIOR TO BACKFILL OF MAIN.
8. THE MAIN SHALL BE BEDDED ON 100mm OF 7mm CLEAN METAL, IN A MINIMUM 300mm WIDE TRENCH AND SHALL BE COVERED WITH A MINIMUM OF 100mm THICK 7mm CLEAN AGGREGATE. LOCATOR TAPE SHALL BE PLACED OVER THE MAIN.
9. ALL PIPEWORK SHALL BE PRESSURE TESTED IN ACCORDANCE WITH AS3500.2 AND TW GUIDELINES.
10. IF NEW CONNECTION REQUIRED AT REAR OF PROPERTY THE CONNECTION SHALL BE UNDERTAKEN AS PER MRWA-S-104A BY TASWATER APPROVED CONTRACTOR PLUMBER LISTED ON THEIR WEBSITE.
11. ALL WATER WORKS TO BE TASWATER AND COUNCIL APPROVED WORKS. CONTRACTOR TO ARRANGE FOR INSPECTIONS AND APPROVALS.



Sorell Council

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Walker Street, Sorell - P2.pdf
Plans Reference: P2
Date received: 28/04/2025

NOTE: THIS SET OF DRAWINGS SHOULD ALWAYSBE PRINTED IN COLOUR.

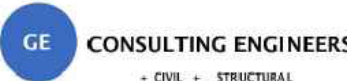					<div><div><div><div></div><div><div>ABN64 629 573 897 ACN 629 573 897 42 SANDY BAY ROAD BATTERY POINT, TAS 7005 ADMIN@GECE.COM.AU 0412 705 240</div></div></div></div><div><div>© copyright GE CONSULTING ENGINEERS</div><div>GE CONSULTING ENGINEERS RETAINS THE INTELLECTUAL PROPERTY RIGHTS OF THESE DRAWINGS, DESIGNS AND CONTENT. THESE DRAWINGS CAN NOT BE RESOLD, REPRODUCED, COPIED OR ADAPTED IN ANYWAY WITHOUT WRITTEN CONSENT OF GE CONSULTING ENGINEERS.</div><div>DIMENSIONS TO BE CHECKED ON SITE.</div><div>DO NOT SCALE OFF DRAWINGS.</div><div>DESCREANCIES TO BE NOTIFIED VIA EMAIL TO GE CONSULTING ENGINEERS.</div></div></div>	<div>ENGINEER: A.G-E.</div> <div>DRAFTER: CP</div> <div>STATUS: BUILDING APPLICATION</div>	<div>SCALE:</div> <div>SIZE: A3</div>	<div>PROJECT: 31 WALKER ST, SORELL, TAS 7172</div>	<div>DRAWING TITLE: NOTES</div>	
00	ISSUED FOR CONSTRUCTION	CP	A.G-E.	30.09.2024						
REV	ISSUE DESCRIPTION	ISSUE DRAWN BY	CHK	DATE						

LEGEND

EXISTING BOUNDARY

—EXW—EXW—

EXISTING WATER INFRASTRUCTURE

—W—W—

PROPOSED WATER INFRASTRUCTURE

—E—E—

EXISTING POWER INFRASTRUCTURE

—E—E—

PROPOSED POWER INFRASTRUCTURE

—EXSW—EXSW—

EXISTING STORM WATER INFRASTRUCTURE

—SW—SW—

PROPOSED STORM WATER INFRASTRUCTURE

—EXS—EXS—

EXISTING SEWER INFRASTRUCTURE

—S—S—

PROPOSED SEWER INFRASTRUCTURE

—CO/H—CO,

EXISTING TELSTRA (OR COMMUNICATIONS) INFRASTRUCTURE

—CO/H—CO,

PROPOSED TELSTRA (OR COMMUNICATIONS) INFRASTRUCTURE

POWER POLES

POWER CONNECTION POINT

FIRE PLUG

DN25 WATER METER

EXISTING WATER METER

COMMUNICATIONS LOT CONNECTIONS

IO

IO

IO

SEWER LOT CONNECTION

IO

IO

IO

STORM WATER LOT CONNECTION

GS1

NATURAL FINISHED CONC. 150mm THICK, 25Mpa SL82 WITH 30mm COVER. REFER TO PAVEMENT SECTION FOR FURTHER DETAIL

MIN COVER:
NON-TRAFFICABLE
450mm
TRAFFICABLE
600mm

The diagram is a detailed site plan for Walker Street. It shows a proposed building extension and several existing buildings. Key features include:
- **Proposed Building Extension:** Located at the top center, with a height of 29.270.
- **Existing Buildings:** Several rectangular structures labeled 'EX. BUILDING'.
- **Proposed Buildings:** Two rectangular structures labeled 'PROPOSED BUILDING' at the bottom center.
- **Infrastructure:** Includes an 'EXISTING SW OUTLET DN150 - 750mm TO INLET', 'EX 450 PIT', 'DN150 SN8', and various 'COMS' (communications) points.
- **Boundaries:** 'COMPILED BOUNDARY' lines are shown with dimensions like 30.452, 11.47.23, 281.21.04, and 29.788.
- **Streets:** 'WALKER STREET' is on the right, and 'EXISTING SEALED SHARED ACCESS DRIVEWAY' is at the bottom.
- **Notes:** 'MIN. 1% FALLS' is indicated in several areas. A note on the right says: 'REVIEW QUALITY AND COVER OF EXISTING SW PIPE AND REPLACE EXISTING SW PIPE WITH NEW DN150 SN8 WHERE NECCESARY. MIN SIZE 150mm DIA'.
- **Other:** 'KERB TYPE BK' and 'KERB TYPE KC' are labeled. A north arrow is in the bottom right corner.

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Development Application: 5.2023.310.1 - Response to Request For Information - 31 Walker Street, Sorell - P2.pdf Plans Reference: P2 Date received: 28/04/2025

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					<div><div><div><div>GE CONSULTING ENGINEERS</div><div>+ CIVIL + STRUCTURAL</div><div>gce.com.au</div></div><div><div>ABN64 629 573 897 ACN 629 573 897 42 SANDY BAY ROAD BATTERY POINT, TAS 7005 ADMIN@GCE.COM.AU 0412 705 240</div></div></div><div><div>© copyright GE CONSULTING ENGINEERS</div><div>GE CONSULTING ENGINEERS RETAINS THE INTELLECTUAL PROPERTY RIGHTS OF THESE DRAWINGS, DESIGNS AND CONTENT. THESE DRAWINGS CAN NOT BE RESOLD, REPRODUCED, COPIED OR ADAPTED IN ANYWAY WITHOUT WRITTEN CONSENT OF GE CONSULTING ENGINEERS.</div><div>DIMENSIONS TO BE CHECKED ON SITE.</div><div>DO NOT SCALE OFF DRAWINGS.</div><div>DESCREANCIES TO BE NOTIFIED VIA EMAIL TO GE CONSULTING ENGINEERS.</div></div><div><div>ENGINEER: A.G-E.</div><div>DRAFTER: CP</div><div>STATUS: BUILDING APPLICATION</div></div><div><div>SCALE: 1:250</div><div>SIZE: A3</div></div><div><div>PROJECT: 31 WALKER ST, SORELL, TAS 7172</div></div><div><div>DRAWING TITLE: GENERAL ARRANGEMENT</div><div><div>PROJECT No. 045</div><div>DWG No. C02</div></div><div><div>REVISION: 00</div></div></div></div>	
00	ISSUED FOR CONSTRUCTION	CP	A.G-E.	30.09.2024		
REV	ISSUE DESCRIPTION	ISSUE DRAWN BY	CHK	DATE		

LEGEND

- VEHICLE BODY - START AND FINISH POSITION
- VEHICLE BODY - INTERMEDIATE MANOEUVRE POSITION
- WHEEL PATH - OUTSIDE EDGE
- VEHICLE BODY PATH - OUTSIDE EDGE



SWEPT PATHS - IN

1:200





Sorell Council


Development Application: 5.2023.310.1 -
Response to Request For Information - 31
Walker Street, Sorell - P2.pdf
Plans Reference: P2
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00	ISSUED FOR CONSTRUCTION	CP	A.G-E.	30.09.2024							
REV	ISSUE DESCRIPTION	ISSUE DRAWN BY	CHK	DATE							

LEGEND


	VEHICLE BODY - START AND FINISH POSITION
	VEHICLE BODY - INTERMEDIATE MANOEUVRE POSITION
	WHEEL PATH - OUTSIDE EDGE
	VEHICLE BODY PATH - OUTSIDE EDGE



SWEPT PATHS - OUT

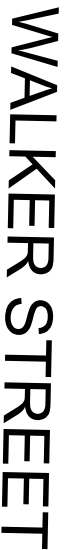[illegible]

NOTE: THIS SET OF DRAWINGS SHOULD ALWAYS BE PRINTED IN COLOUR.

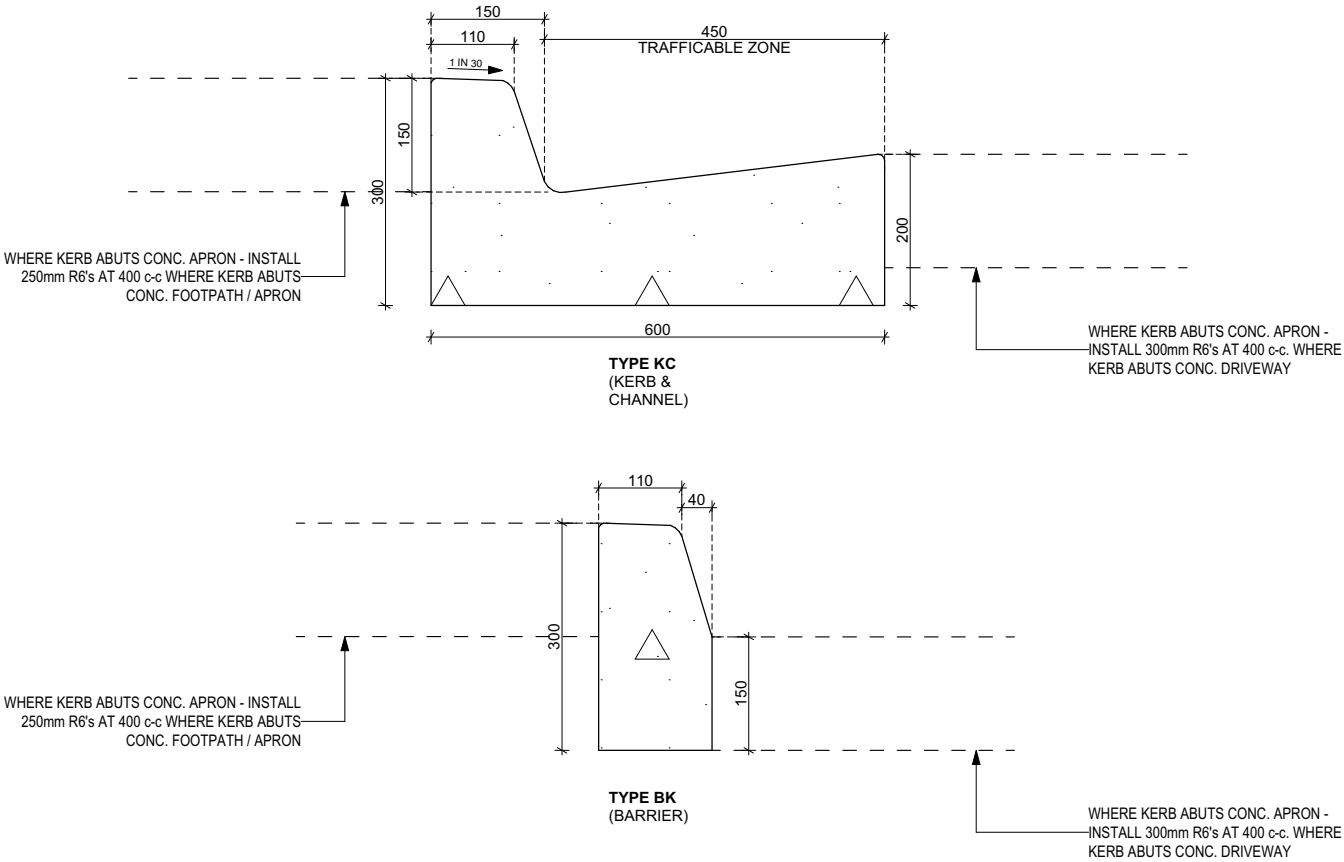

DETAIL 3: DRIVEWAY KERB DETAILS
SCALE: 1:10

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							A.G-E.	1:10			
							DRAFTER:	SIZE:			
							CP	A3			
							STATUS:				
00	ISSUED FOR CONSTRUCTION	CP	A.G-E.	30.09.2024						PROJECT No. 045	DWG No. C07
REV	ISSUE DESCRIPTION	ISSUE DRAWN BY	CHK	DATE							REVISION: 00





Sorell Council

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PROPOSED ACCOMODATION

31 WALKER ST, SORELL, TAS 7172

CLIENT: TERRY MCGILL

STAGE: DEVELOPMENT APPLICATION

COUNCIL: SORELL

TITLE REF: 110657 / 1

JOB No.: 045

B	ADDRESS RFI'S (COUNCIL, HERRITAGE)	28.04.2025	ALL	CDP
A	DEVELOPMENT APPLICATION - INITIAL ISSUE	2023.10.16	ALL	CDP
REV	AMENDMENTS	DATE	SHEET	DRW

REVISION SCHEDULE

AREA SCHEDULE

EXISTING BARRACKS	162.00m ²
EXISTING COTTAGE 1	18.00m ²
EXISTING RECEPTION	21.6m ²
EXISTING FCR PARKING	212.47m ²
EXISTING CONC. PATHS	40.18m ²
EXISTING PAVED PATHS	126.85m ²
TOTAL EXISTING IMPERVIOUS	584.73m ²

PROPOSED COTTAGE 2	23.48m ²
PROPOSED COTTAGE 3	22.50m ²
PROPOSED COTTAGE 4	22.61m ²
PROPOSED RECEPTION STORE	10.08m ²
PROPOSED SHED	23.02m ²

PROPOSED BUILDINGS (total)	303.22m ²
PROPOSED FCR PARKING	283.39m ²
PROPOSED CONC. PATHS	28.86m ²
PROPOSED PAVED PATHS	110.38m ²
TOTAL NEW IMPERVIOUS	725.85m ²

SITE AREA	896m ²
EXISTING SITE COVERAGE	65.25%
PROPOSED SITE COVERAGE	81.01%

SITE ASSESSMENT

ZONE: GENERAL RESIDENTIAL

WIND REGION:	A
SOIL CLASS:	A
TERRAIN CATEGORY:	TC3
SHIELDING CLASS:	FS
TOPOGRAPHIC CLASS:	T0
WIND CLASS:	N1


OTHER SUPPORTING DOCUMENTATION

SOIL REPORT:	GECE (05.07.2023)
STRUCTURAL ENG.:	TBP
CIVIL ENGINEERING:	GECE (30.09.2024)
TRAFFIC IMPACT ASSESSMENT	AUSWIDE (04.2024)

SHEET LIST

No.	SHEET NAME
A-01	COVER SHEET
A-02	EXISTING SITE PLAN
A-03	PROPOSED SITE PLAN
A-04	CONCEPT SITE DRAINAGE PLAN
A-05	COTTAGE FLOOR PLANS
A-06	SHED AND STORE FLOOR PLANS
A-07	SITE ELEVATIONS
A-08	SITE ELEVATIONS
A-09	COTTAGE ELEVATIONS 1
A-10	COTTAGE ELEVATIONS 2
A-11	3D PERSPECTIVE VIEWS
A-12	COTTAGE ELECTRICAL PLAN
A-13	COTTAGE FLOOR COVERINGS

SHEET	REV.
B	
B	
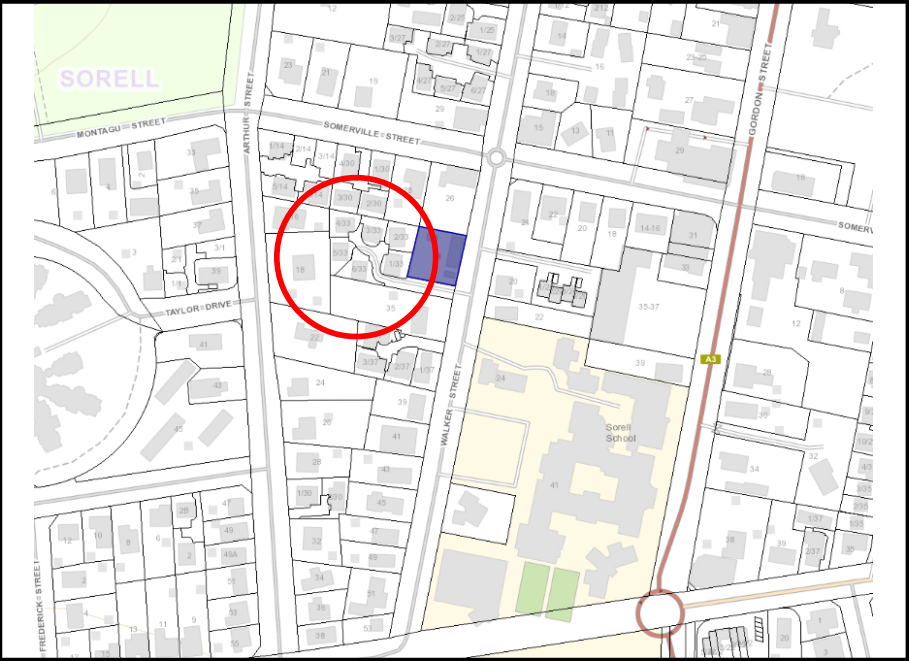

SITE LOCATION

PH: 0417858537
E: chrispooley0@gmail.com
BUILDING DESIGNER ACCREDITATION:
866088099




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JOB No: 045
 SCALES(s) @ A3: 1:200
SHEET No: A-02
 No. OF SHEETS: 13


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ZONE: GENERAL RESIDENTIAL

WIND REGION:	A
SOIL CLASS:	A
TERRAIN CATEGORY:	TC3
SHIELDING CLASS:	FS
TOPOGRAPHIC CLASS:	T0
WIND CLASS:	N1

OTHER SUPPORTING DOCUMENTATION	
SOIL REPORT:	GECE (05.07.2023)
STRUCTURAL ENG.:	TBP
CIVIL ENGINEERING:	GECE (30.09.2024)
TRAFFIC IMPACT ASSESSMENT	AUSWIDE (04.2024)

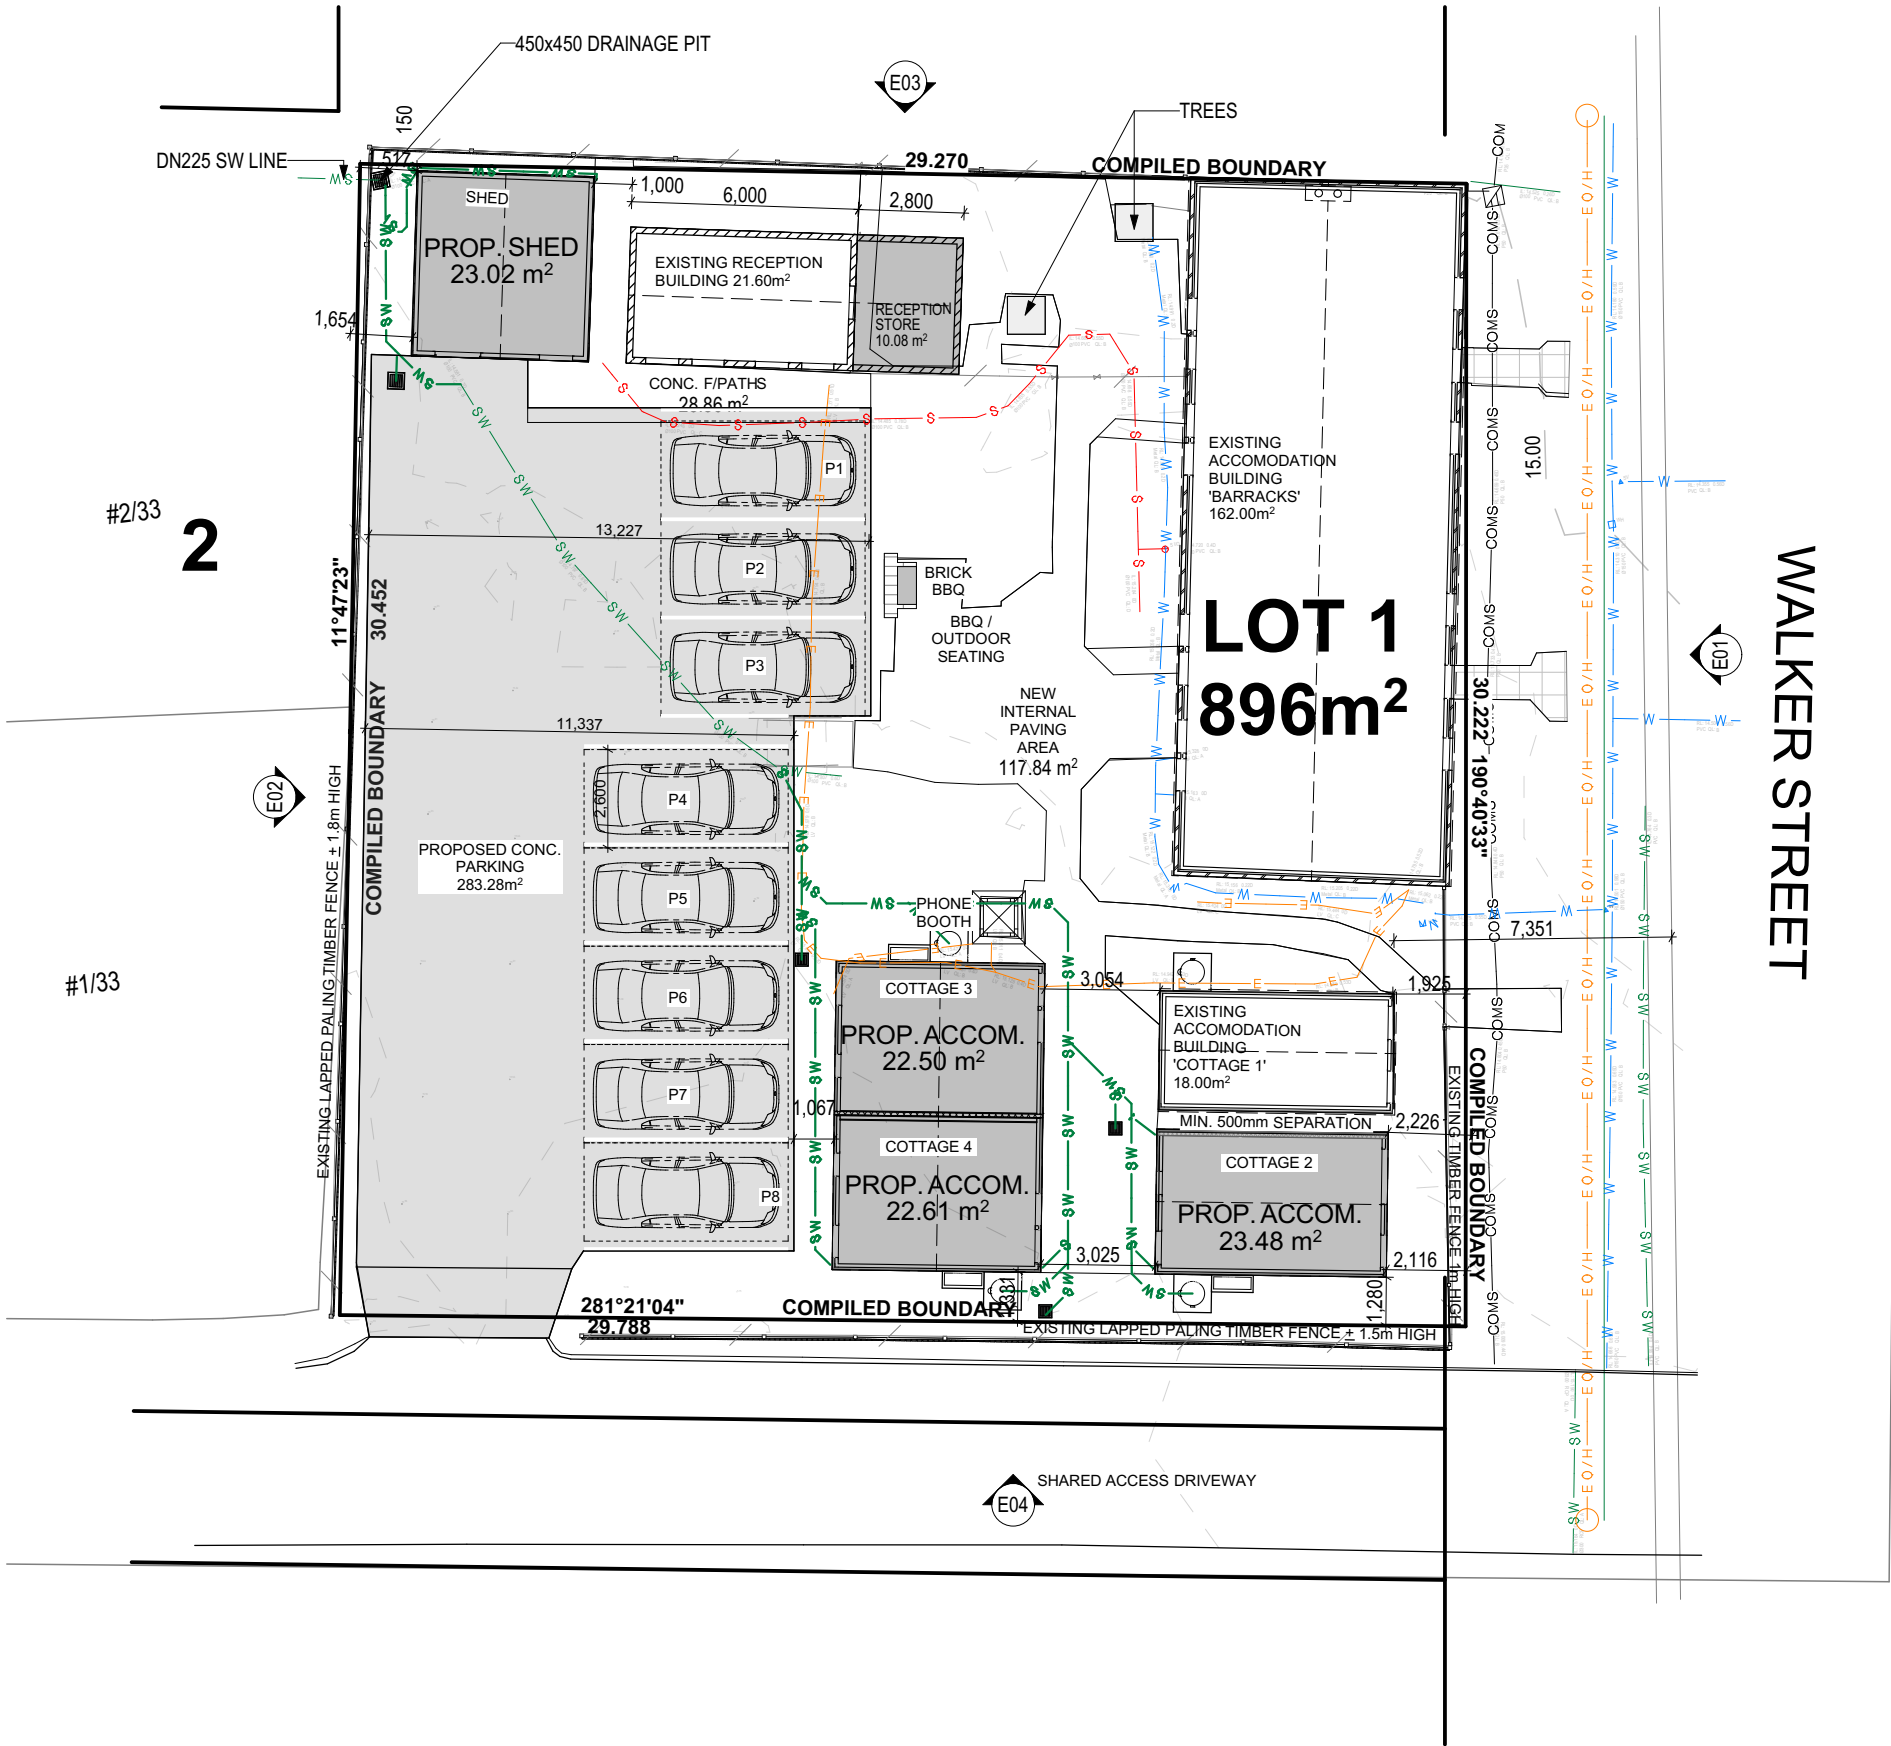

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PDS

POOLEY'S DRAFTING SERVICES

PH: 0417858537
E: chrispooley0@gmail.com

BUILDING DESIGNER
ACCREDITATION: 866088099

BUILDING BEING CONSTRUCTED IN A BAL-N/A AREA
(RESTRICTIONS TO, OR ADDITIONAL CONSTRUCTION METHODS/
MATERIALS MAY APPLY - REFER TO NOTES)

PROPOSED SITE PLAN

PROPOSED ACCOMODATION	TERRY MCGILL
DEVELOPMENT APPLICATION	31 WALKER ST, SORELL, TAS 7172 CT: 110657 LOT: 1


B	ADDRESS RFI'S (COUNCIL, HERRITAGE)	28.04.2025	ALL	CDP	
A	DEVELOPMENT APPLICATION - INITIAL ISSUE	2023.10.16	ALL	CDP	
REV	AMENDMENTS	DATE	SHEET	DRW	

ALL LAYOUTS ARE TO BE PRINTED IN COLOUR







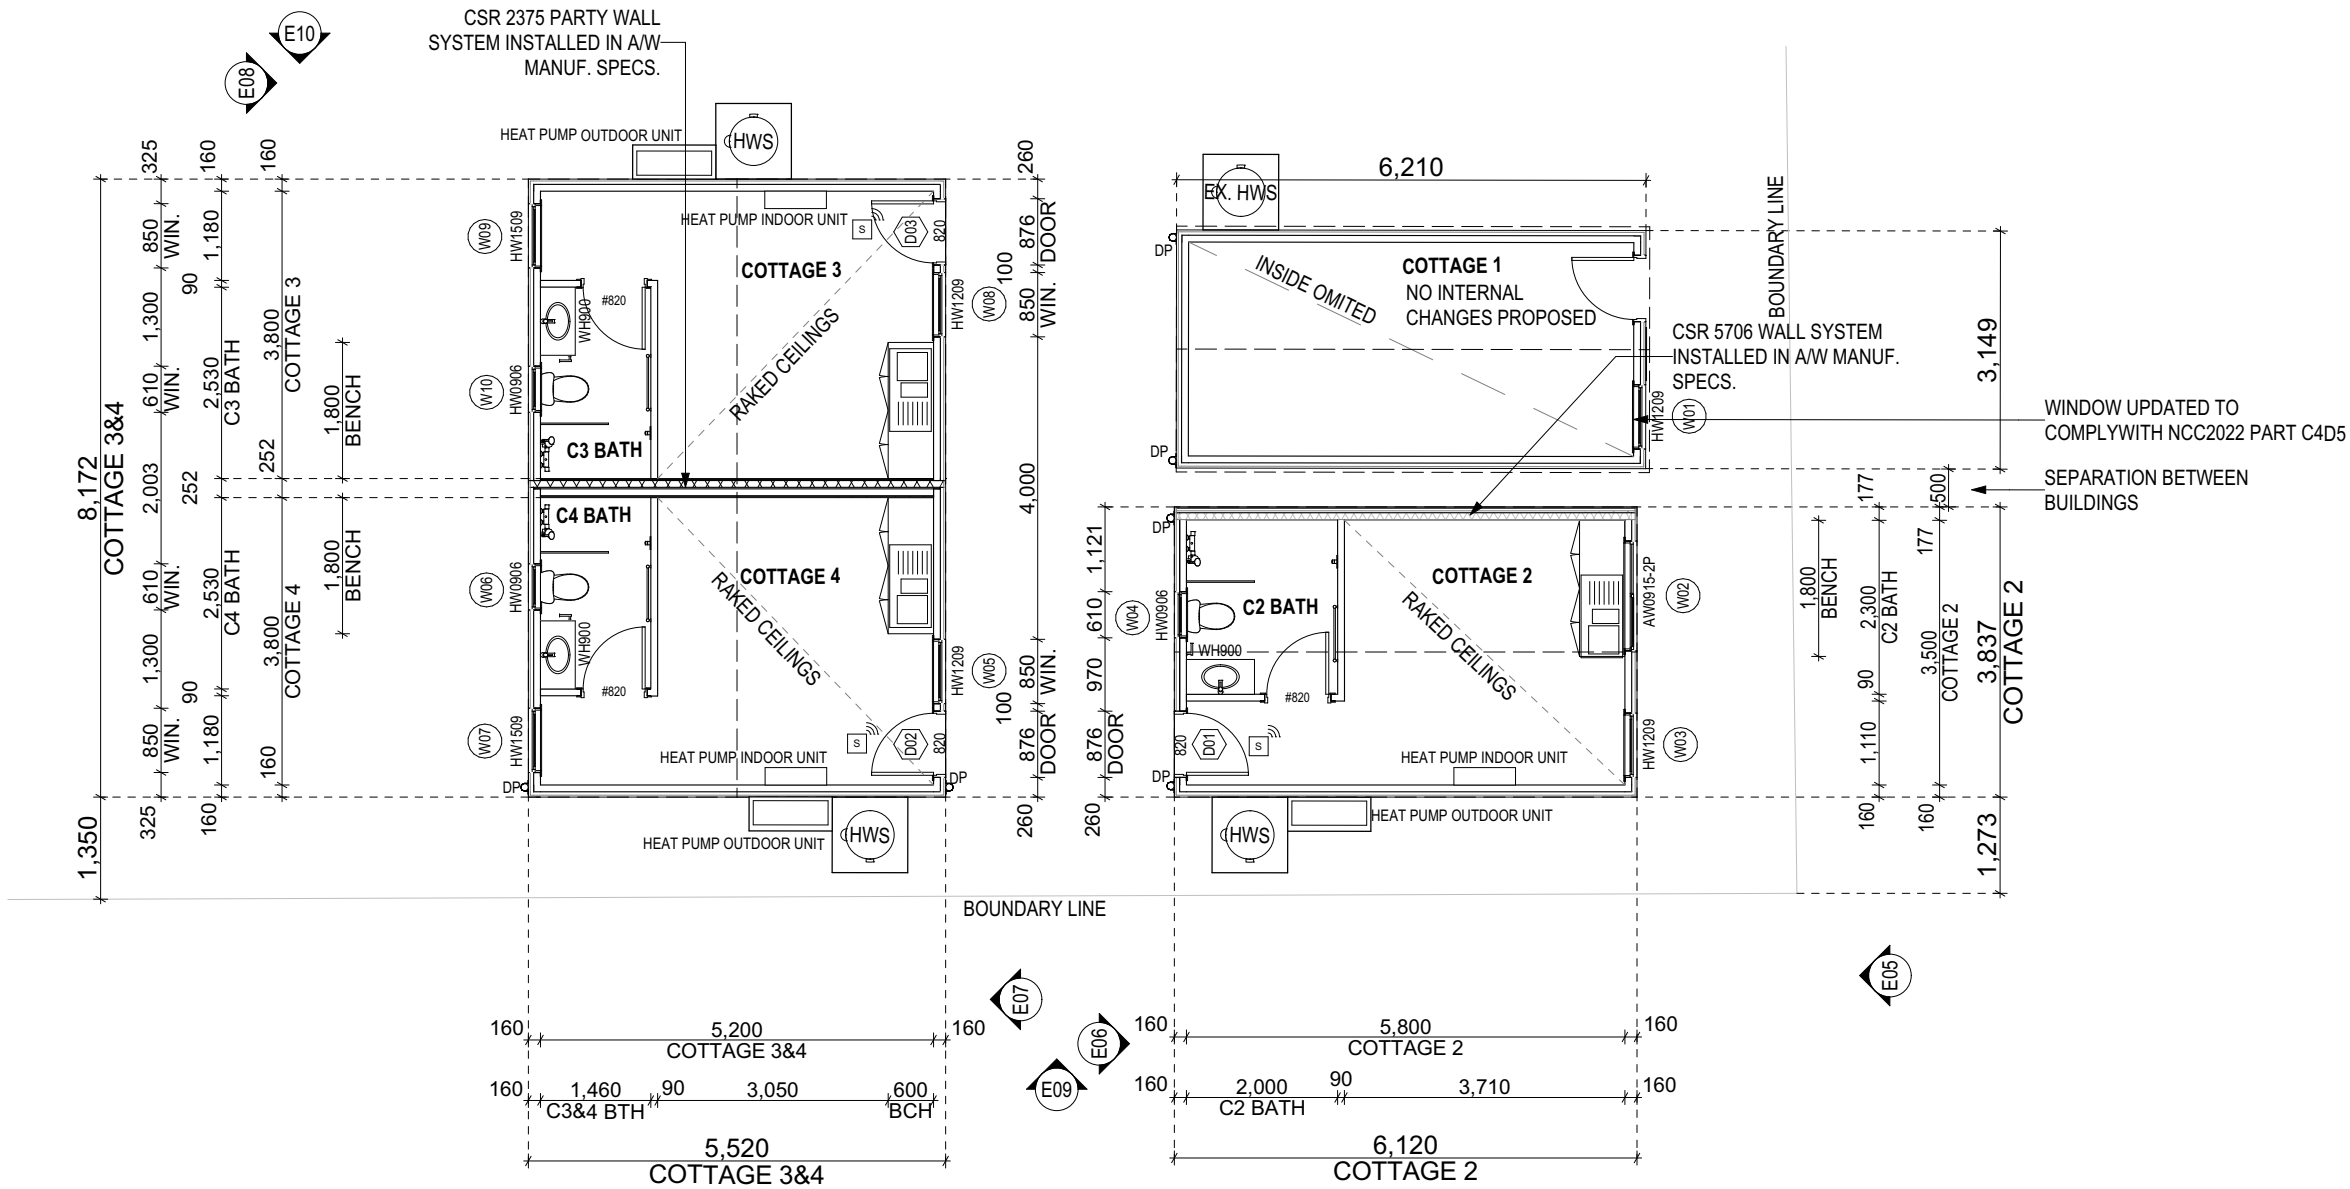





LAYOUT REV: B
JOB No: 045
SCALES(s) @ A3: 1:200
SHEET No: A-03
No. OF SHEETS: 13

1. PLUMBER TO CONFIRM TO CONFIRM THE EXISTING ON-SITE SERVICES PRIOR TO COMMENCEMENT OF ANY EXCAVATIONS.
2. ALL PLUMBING WORKS TO BE IN ACCORDANCE WITH COUNCIL REGULATIONS, THE DIRECTORS DETERMINATION & AS3500.
3. REFER TO DESIGNERS DRAWINGS AND FIXTURE AND EQUIPMENT TECHNICAL SPECIFICATIONS FOR PIPEWORK CONNECTIONS.
4. MAKE GOOD ALL DISTURBED SURFACES TO MATCH EXISTING.
5. REMOVE ALL EXCESS SOIL AND SURPLUS MATERIALS FROM THE SITE.
6. ALL PLUMBING TO BE INSTALLED BY A LICENCED PLUMBER.
7. INSTALL INSPECTION OPENINGS AT MAJOR BENDS AND ALL LOW POINTS OF DOWNPIPES.

NEW BUILDINGS FLOOR AREA SCHEDULE	
AREA NAME	MEASURED AREA
COTTAGE 2	23.48
COTTAGE 3	22.50
COTTAGE 4	22.61
RECEPTION STORE	10.08
SHED	22.98
	101.65 m ²



LEGEND

- | | |
|---|---|
|  | EXTERIOR WALL - LIGHTWEIGHT CLADDING
SHOWN GENERALLY @ 160mm |
|  | EXTERIOR WALL - BRICK VENEER |
|  | FIRE RATED PARTITION WALL
DIMENSIONED VALUE = OUTSIDE FACE OF
WALL SYSTEM |
|  | INTERNAL STUD WALL |
|  | INTERNAL STUD WALL (INSULATION) |
|  | SMOKE ALARM - INTERCONNECTED WHERE
THERE IS MORE THAN 1 |
|  | MECHANICAL EXHAUST FAN - DUCTED
EXTERNALLY |
|  | LIFT OFF HINGES TO DOOR |
|  | YARD TAP WITH ORG |
|  | YARD TAP |
|  | CHARGED DOWNPIPE /
STANDARD DOWNPIPE |
|  | FLOOR WASTE GULLY |



NOTE: ALL DIMENSIONS ARE FRAME DIMENSIONS U.N.O.

ALL LAYOUTS ARE TO BE PRINTED IN COLOUR

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POOLEYS DRAFTING SERVICES

PH: 0417858537
E: chrispooley0@gmail.com

BUILDING DESIGNER
ACCREDITATION: 866088099

PH: 0417858537
E: chrispooley0@gmail.com

BUILDING DESIGNER
ACCREDITATION: 866088099

BUILDING BEING CONSTRUCTED IN A BAL-N/A AREA
(RESTRICTIONS TO, OR ADDITIONAL CONSTRUCTION METHODS/
MATERIALS MAY APPLY - REFER TO NOTES)

COTTAGE FLOOR PLANS

PROPOSED ACCOMODATION

TERRY MCGILL

DEVELOPMENT APPLICATION


31 WALKER ST, SORELL, TAS 7172
CT: 110657 LOT: 1

B	ADDRESS RFI'S (COUNCIL, HERRITAGE)	28.04.2025	ALL	CDP
A	DEVELOPMENT APPLICATION - INITIAL ISSUE	2023.10.16	ALL	CDP
REV	AMENDMENTS	DATE	SHEET	DRW



LAYOUT REV: B
JOB No: 045
 SCALES(s) @ A3: 1:100
SHEET No: A-05
 No. OF SHEETS: 13

NEW BUILDINGS FLOOR AREA SCHEDULE	
AREA NAME	MEASURED AREA
COTTAGE 2	23.48
COTTAGE 3	22.50
COTTAGE 4	22.61
RECEPTION STORE	10.08
SHED	22.98
	101.65 m²

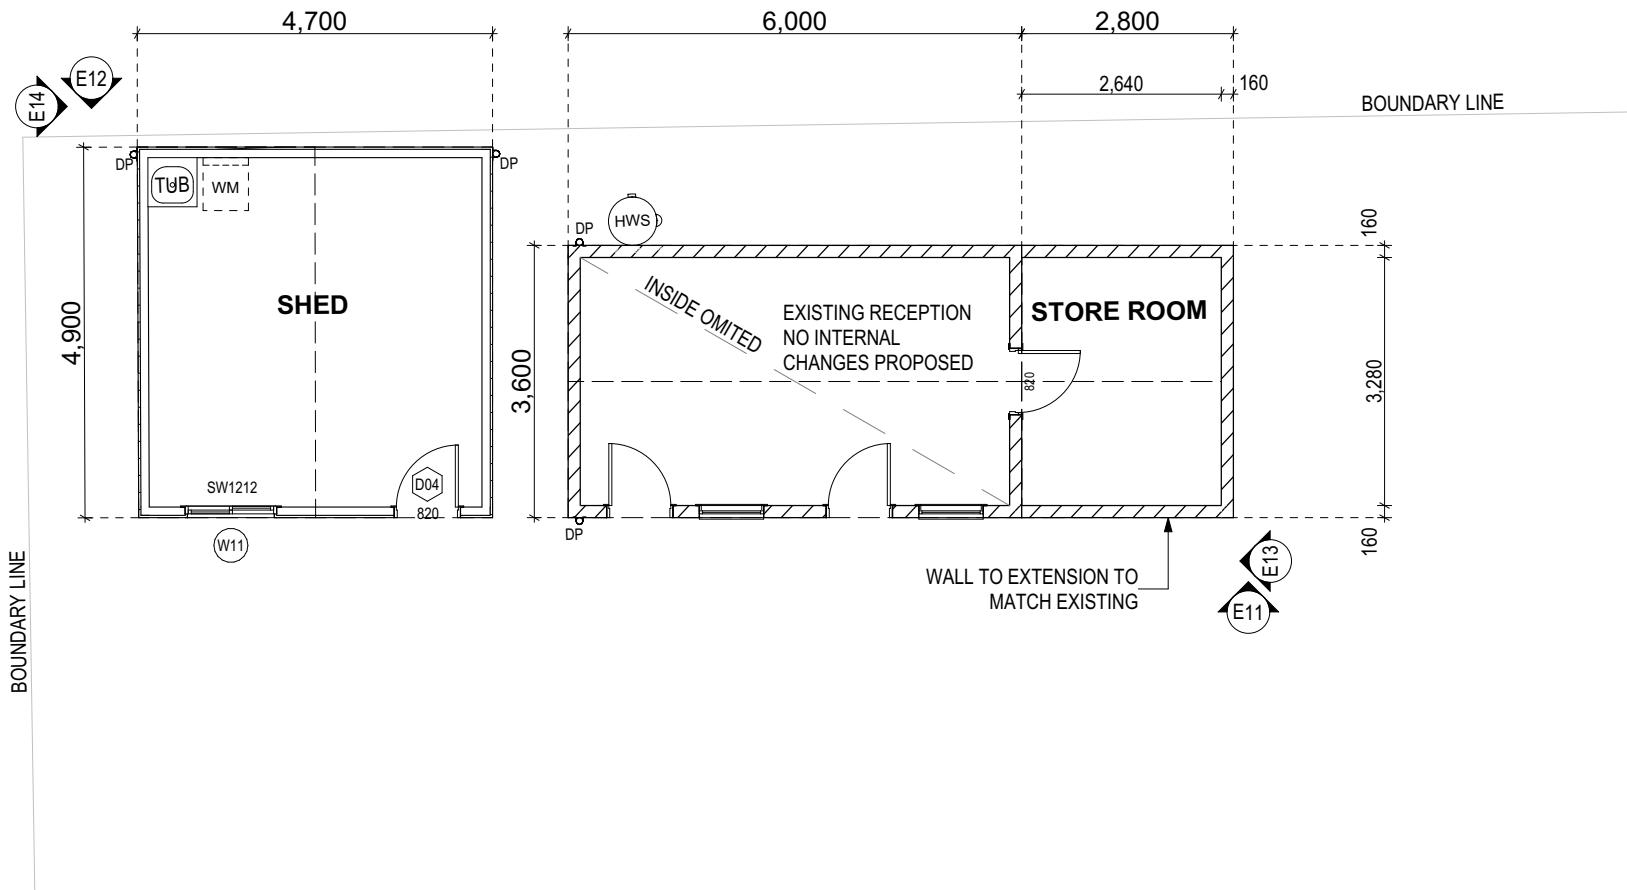

LEGEND

EXTERIOR WALL - LIGHTWEIGHT CLADDING
SHOWN GENERALLY @ 160mm

EXTERIOR WALL - BRICK VENEER

FIRE RATED PARTITION WALL
DIMENSIONED VALUE = OUTSIDE FACE OF
WALL SYSTEM

INTERNAL STUD WALL

INTERNAL STUD WALL (INSULATION)

SMOKE ALARM - INTERCONNECTED WHERE
THERE IS MORE THAN 1

MECHANICAL EXHAUST FAN - DUCTED
EXTERNALLY

#

LIFT OFF HINGES TO DOOR

YARD TAP WITH ORG

+

YARD TAP

CDPSPD

CHARGED DOWNPIPE /
STANDARD DOWNPIPE

FW

FLOOR WASTE GULLY

SORELL COUNCIL

Development Application: 5.2023.310.1 -
Response to Request For Information - 31
Walker Street, Sorell - P2.pdf
Plans Reference: P2
Date received: 28/04/2025

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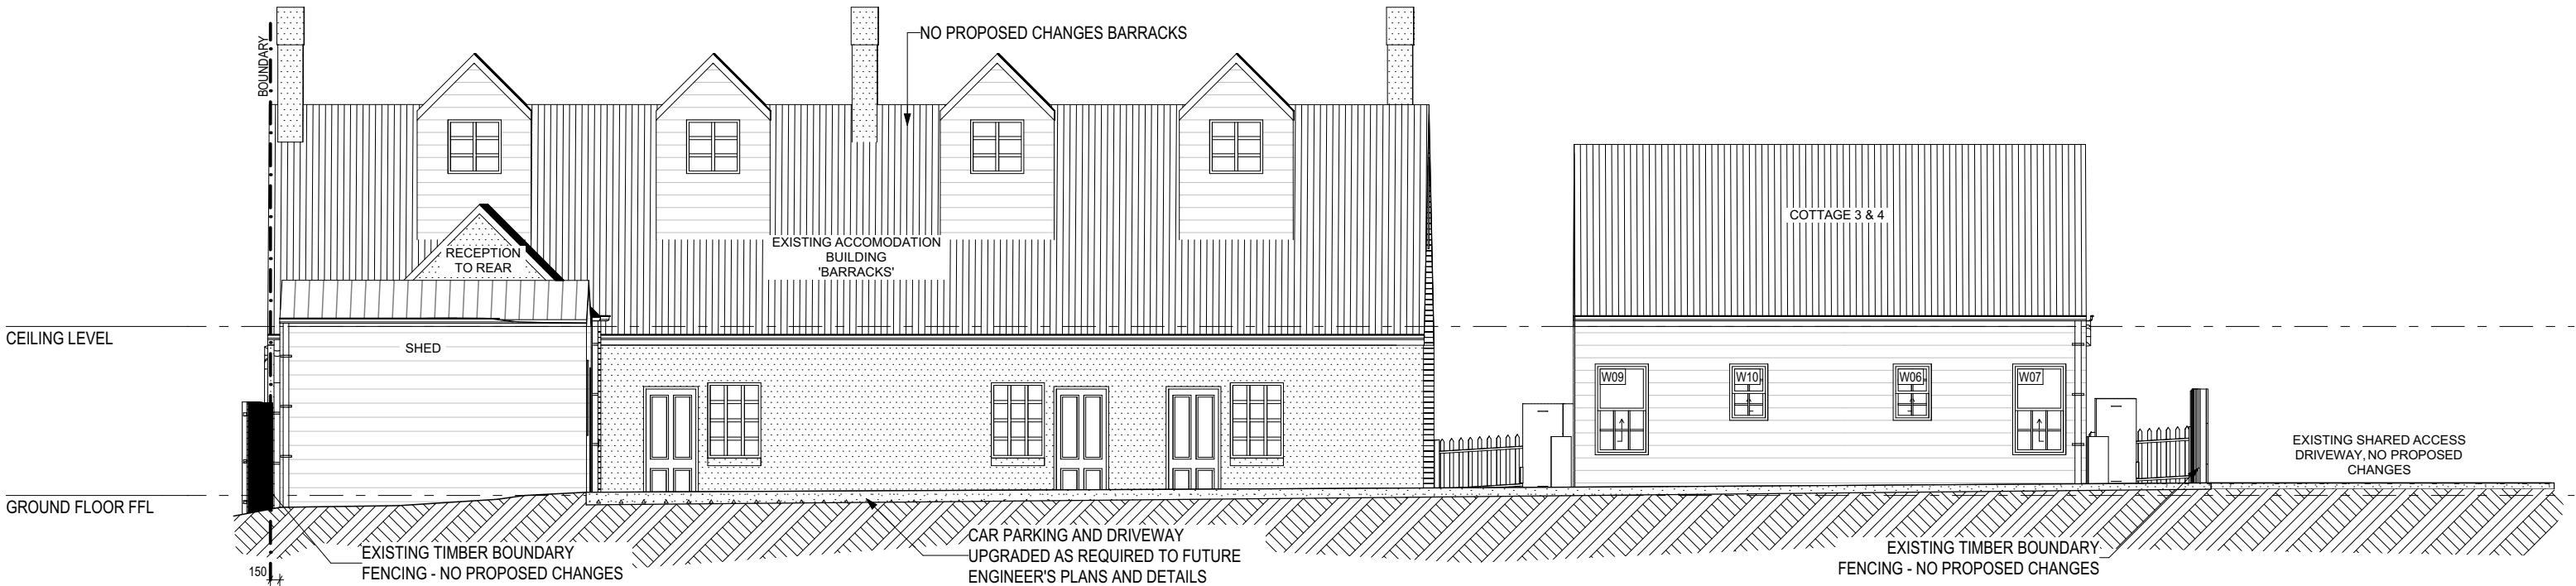
SHED AND STORE FLOOR PLANS

PROPOSED ACCOMODATION	TERRY MCGILL
DEVELOPMENT APPLICATION	31 WALKER ST, SORELL, TAS 7172 CT: 110657 LOT: 1

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REV	AMENDMENTS	DATE	SHEET	DRW	

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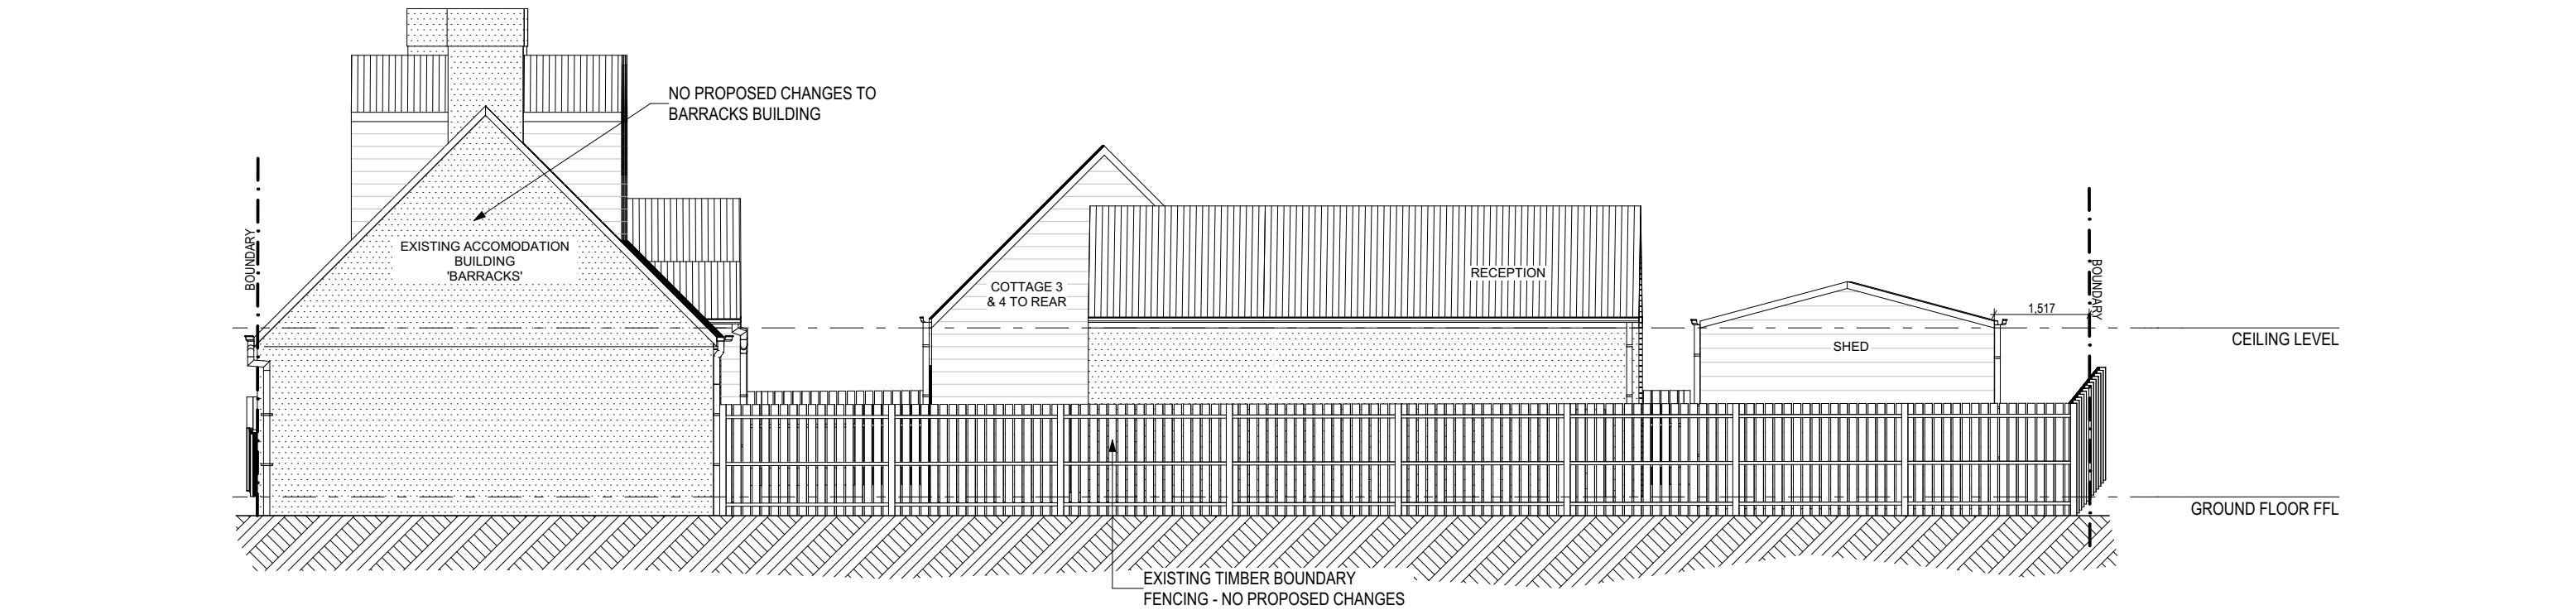
LAYOUT REV: B
JOB No: 045
SCALES(s) @ A3: 1:100
SHEET No: A-06
No. OF SHEETS: 13



E02

SITE REAR (WEST) ELEVATION

1:100



E03


SITE SIDE (NORTH) ELEVATION


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



Sorell Council
Development Application: 5.2023.310.1 -
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Walker Street, Sorell - P2.pdf
Plans Reference: P2
Date received: 28/04/2025


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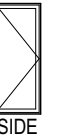
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
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
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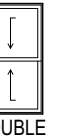
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
WINDOW TYPE LEGEND


 SIDE HUNG


 AWNING

 HUNG WINDOW

 DOUBLE HUNG


 FIXED

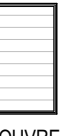 LOUVRE

 SLIDING

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PH: 0417858537
E: chrispooley0@gmail.com

BUILDING DESIGNER
ACCREDITATION: 866088099

BUILDING BEING CONSTRUCTED IN A BAL-N/A AREA
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SITE ELEVATIONS

PROPOSED ACCOMODATION

TERRY MCGILL

DEVELOPMENT APPLICATION

31 WALKER ST, SORELL, TAS 7172
CT: 110657 LOT: 1

B	ADDRESS RFI'S (COUNCIL, HERRITAGE)	28.04.2025	ALL	CDP	
A	DEVELOPMENT APPLICATION - INITIAL ISSUE	2023.10.16	ALL	CDP	
REV	AMENDMENTS	DATE	SHEET	DRW	

LAYOUT REV: B

JOB No: 045

SCALES(s) @ A3: 1:100


SHEET No: A-08

No. OF SHEETS: 13

ALL LAYOUTS ARE TO BE PRINTED IN COLOUR

CODE	SURFACE MATERIAL	FINISH COLOUR
A	EX. CORRUGATED SHEET METAL ROOFING	MANOR RED (NO CHANGE TO EXISTING)
B	EX. DOOR AND WINDOW TIMBER TRIMS	HERITAGE GREEN (NO CHANGE TO EXISTING)
C	EX. TIMBER FASCIA BOARD AND METAL GUTTER	GUTTER = HERITAGE GREEN (NO CHANGE) FASCIA = HERITAGE GREEN (NO CHANGE)
D	EX. RENDER MASONRY WALL	WHITE* (NO CHANGE TO EXISTING)
E	EX. TIMBER WEATHERBOARD WALL	WHITE* (NO CHANGE TO EXISTING)
F	EX. PVC DOWNPIPE	WHITE* (NO CHANGE TO EXISTING)
G	EX. TIMBER DOOR	HERITAGE GREEN (NO CHANGE TO EXISTING)
H	RENDERED CONCRETE BLOCK	MATCH EXISTING ON SITE (WHITE*)
I	CEMINTEL STREET STYLE BALMORAL FC WB'S	DULUX LIME WHITE
J	PVC DOWNPIPE	DULUX LIME WHITE
K	TIMBER DOOR	HERITAGE GREEN
L	DOOR AND WINDOW ALUMINIUM TRIMS	HERITAGE GREEN
M	FOLDED METAL FASCIA AND METAL GUTTER	GUTTER = HERITAGE GREEN FASCIA = HERITAGE GREEN
N	CORRUGATED SHEET METAL ROOFING	MANOR RED

NOTES:
 * COLOUR NOT MATCHED OR CONFIRMED - PROFESSIONAL PAINTER / BUILDER TO CONFIRM COLOUR THROUGH MATCHING ON SITE PRIOR TO PURCHASING PAINTS AND / OR APPLYING PAINT. WHERE THE EXISTING IS TO BE TOUCHED UP, THE NEW PAINT IS TO MATCH THE EXISTING.
 FC = FIBRE CEMENT - WB = WEATHERBOARD

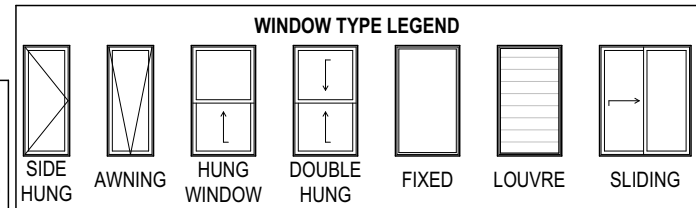

LAYOUT REV: B
JOB No: 045
 SCALES(s) @ A3: 1:100
SHEET No: A-09
 No. OF SHEETS: 13

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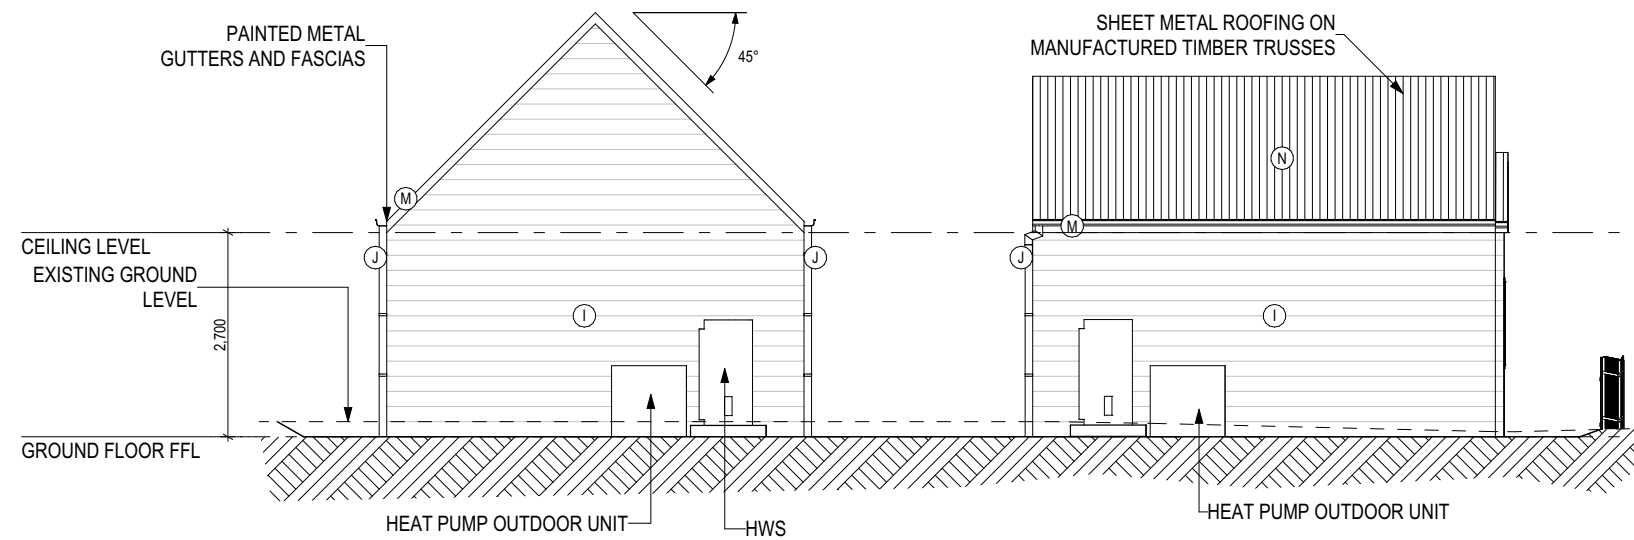
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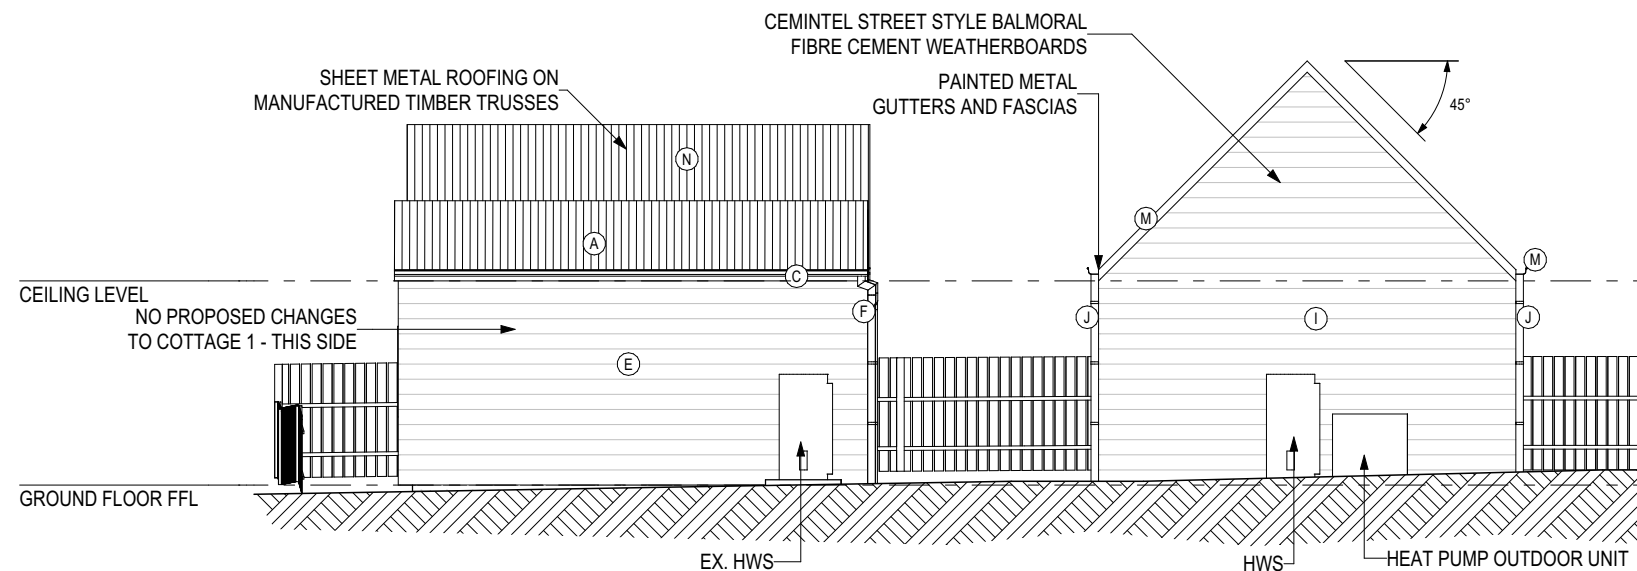
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CODE	SURFACE MATERIAL	FINISH COLOUR
A	EX. CORRUGATED SHEET METAL ROOFING	MANOR RED (NO CHANGE TO EXISTING)
B	EX. DOOR AND WINDOW TIMBER TRIMS	HERITAGE GREEN (NO CHANGE TO EXISTING)
C	EX. TIMBER FASCIA BOARD AND METAL GUTTER	GUTTER = HERITAGE GREEN (NO CHANGE) FASCIA = HERITAGE GREEN (NO CHANGE)
D	EX. RENDER MASONRY WALL	WHITE* (NO CHANGE TO EXISTING)
E	EX. TIMBER WEATHERBOARD WALL	WHITE* (NO CHANGE TO EXISTING)
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G	EX. TIMBER DOOR	HERITAGE GREEN (NO CHANGE TO EXISTING)
H	RENDERED CONCRETE BLOCK	MATCH EXISTING ON SITE (WHITE*)
I	CEMINTEL STREET STYLE BALMORAL FC WB'S	DULUX LIME WHITE
J	PVC DOWNPIPE	DULUX LIME WHITE
K	TIMBER DOOR	HERITAGE GREEN
L	DOOR AND WINDOW ALUMINIUM TRIMS	HERITAGE GREEN
M	FOLDED METAL FASCIA AND METAL GUTTER	GUTTER = HERITAGE GREEN FASCIA = HERITAGE GREEN
N	CORRUGATED SHEET METAL ROOFING	MANOR RED

NOTES:
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 FC = FIBRE CEMENT - WB = WEATHERBOARD



E09	COTTAGE SIDE (SOUTH) ELEVATION	1:100
-----	--------------------------------	-------



E10 COTTAGE SIDE (NORTH) ELEVATION 1:100



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JOB No: 045
 SCALES(s) @ A3: 1:100
SHEET No: A-10
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POOLEYS DRAFTING SERVICES

PH: 0417858537
E: chrispooley0@gmail.com

BUILDING DESIGNER
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COTTAGE ELEVATIONS 2

PROPOSED ACCOMODATION

TERRY MCGILL

DEVELOPMENT APPLICATION

31 WALKER ST, SORELL, TAS 7172
CT: 110657 LOT: 1

B	ADDRESS RFI'S (COUNCIL, HERRITAGE)	28.04.2025	ALL	CDP
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BUILDING BEING CONSTRUCTED IN A BAL-N/A AREA
(RESTRICTIONS TO, OR ADDITIONAL CONSTRUCTION METHODS/
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3D PERSPECTIVE VIEWS

PROPOSED ACCOMMODATION

TERRY MCGILL

DEVELOPMENT APPLICATION

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LEGEND

CEILING LIGHT (FLUSH) - 30W

LEDlux STARLIGHT DOWN LIGHT - 3.5W

WALL MOUNTED LIGHT - 30W

TASTIC - 8W (CENTRAL LIGHT)

PENDANT LIGHT FITTING

SINGLE TUBE LIGHT

LIGHT SWITCH POINT

MULTI GANG LIGHT SWITCH POINT *x
DENOTES NO. OF SWITCHES

LIGHT SWITCH CONNECTION *2 DENOTES
MULTI WAY SWITCH

SMOKE ALARM

MECHANICAL EXHAUST FAN

DGPO

SINGLE GPO

OUTDOOR DGPO

USB POINT

TV POINT

NBN POINT

DATA SOCKET (CAT 5 OR 6)

CEILING FAN

LIGHT SENSOR

PRE-WIRE ONLY

SPOTLIGHT, SINGLE HEAD




SPOTLIGHT, DOUBLE HEAD

NOTES:

- WATTAGES SHOWN ARE AN ESTIMATE ONLY FOR CALCULATION PURPOSES, REF. TO SPECIFICATION FOR PRODUCT SPECIFIC WATTAGES.
- PROVIDE SINGLE GPO TO MWS, REF SPACE, RANGE HOOD & DWS, UNLESS SPECIFICALLY NOTED NOT TO.
- ALL GPOs, TV POINTS, DATA SOCKETS AND NBN TO BE 300mm ABOVE FFL UNLESS NOTED OTHERWISE.
- SMOKE ALARMS TO BE INTERCONNECTED WHERE THERE IS MORE THAN ONE AND TO BE MAINS POWERED.

POWERPOINTS, LIGHT SWITCHES, TV POINT, NBN POINT, ETC ARE SHOWN NOMINALLY ONLY AND NUMBERS AND LOCATIONS CAN BE ADJUSTED, AND SHOULD BE CONFIRMED WITH THE OWNER PRIOR TO QUOTING OR INSTALLATION. HOWEVER, IF LIGHT TYPE OR QUANTITY ARE CHANGED THE DESIGNER NEEDS TO BE NOTIFIED SO ARTIFICIAL LIGHTING CALCULATIONS AND COMPLIANCE CAN BE CONFIRMED.

DOWNLIGHTS ARE IC RATED GENERALLY, WITH 90mm DIA CUTOUTS. REFER TO BUILDERS SPECIFICATION FOR SELECTION DETAILS.

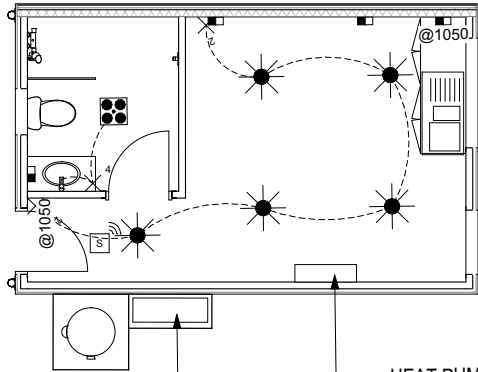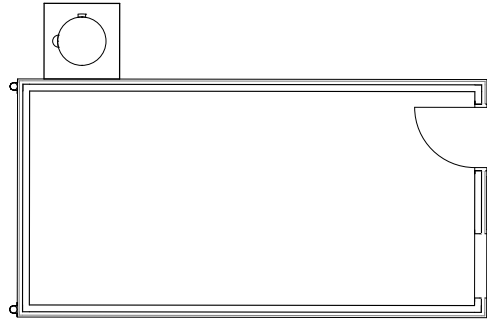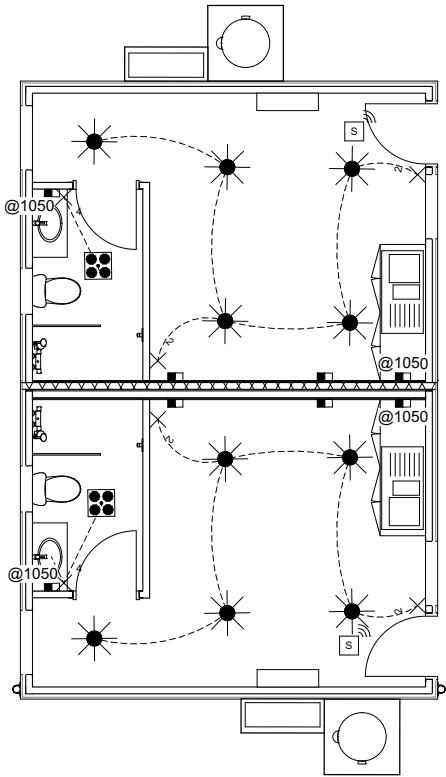

HEAT PUMP INDOOR UNIT
HEAT PUMP OUTDOOR UNIT

Sorell Council

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Walker Street, Sorell - P2.pdf
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E: chrispooley0@gmail.com

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BUILDING BEING CONSTRUCTED IN A **BAL-N/A** AREA (RESTRICTIONS TO, OR ADDITIONAL CONSTRUCTION METHODS/ MATERIALS MAY APPLY - REFER TO NOTES)

COTTAGE ELECTRICAL PLAN

PROPOSED ACCOMODATION TERRY MCGILL




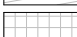




DEVELOPMENT APPLICATION 31 WALKER ST, SORELL, TAS 7172
CT: 110657 LOT: 1

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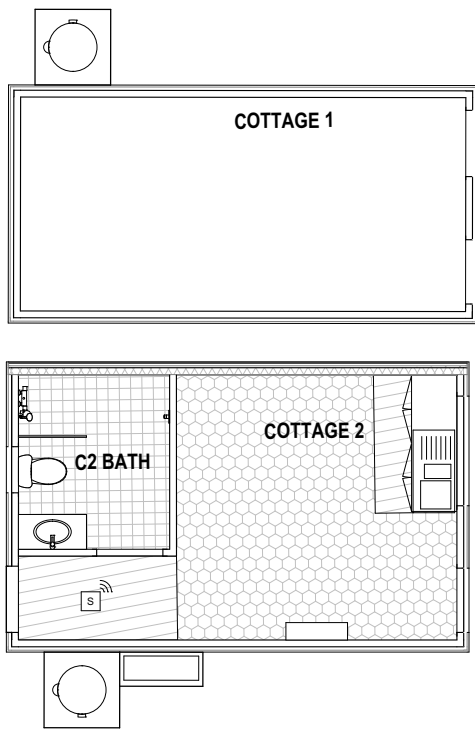
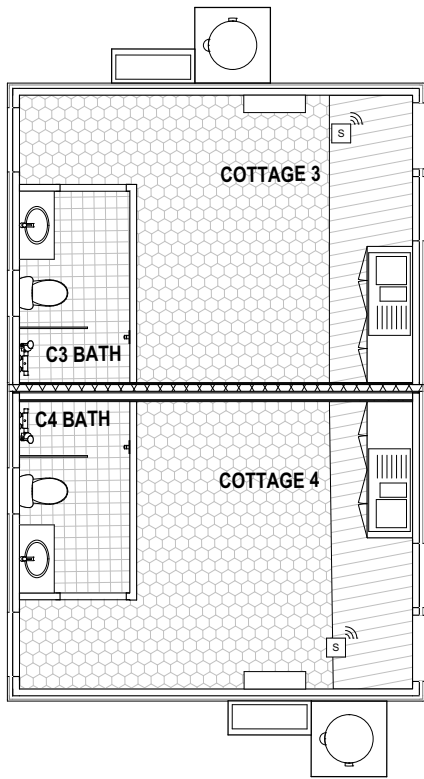
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LAYOUT REV: B
JOB No: 045
SCALES(s) @ A3: 1:100
SHEET No: A-12
No. OF SHEETS: 13

LEGEND

	NO COVERING
	CARPET
	TIMBER / LAMINATE FLOORBOARDS
	FLOOR TILES
	FEATURE TILES
	POLISHED CONCRETE
	CONCRETE
	TIMBER DECKING

TILES SHOWN ON PLAN DO NOT INDICATE THE SIZE OR JOINT LOCATIONS OF THE ACTUAL TILES.

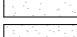
Sorell Council

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PDS
POOLEYS DRAFTING SERVICES

PH: 0417858537
E: chrispooley0@gmail.com

BUILDING DESIGNER
ACCREDITATION: 866088099

PH: 0417858537
E: chrispooley0@gmail.com
BUILDING DESIGNER
ACCREDITATION: 866088099

COTTAGE FLOOR COVERINGS

PROPOSED ACCOMMODATION

TERRY MCGILL

DEVELOPMENT APPLICATION

31 WALKER ST, SORELL, TAS 7172
CT: 110657 LOT: 1

B A	ADDRESS RFI'S (COUNCIL, HERRITAGE) DEVELOPMENT APPLICATION - INITIAL ISSUE	28.04.2025 2023.10.16	ALL ALL	CDP CDP
REV	AMENDMENTS	DATE	SHEET	DRW

LAYOUT REV: B
JOB No: 045
SCALES(s) @ A3: 1:100
SHEET No: A-13
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