

# NOTICE OF PROPOSED DEVELOPMENT

Notice is hereby given that an application has been made for planning approval for the following development:

# SITE: 31 Walker Street, Sorell

# PROPOSED DEVELOPMENT: THREE VISITOR ACCOMMODATION BUILDINGS, NEW OUTBUILDING & ADDITION TO EXISTING BUILDING

The relevant plans and documents can be inspected at the Council Offices at 47 Cole Street, Sorell during normal office hours, or the plans may be viewed on Council's website at <u>www.sorell.tas.gov.au</u> until **Monday 26th May 2025.**.

# Advertised in accordance with the Historic Cultural Act 1995

Any person may make representation in relation to the proposal by letter or electronic mail (<u>sorell.council@sorell.tas.gov.au</u>) addressed to the General Manager. Representations must be received no later than **Monday 26th May 2025**.

APPLICANT: Pooley'S Drafting Services

APPLICATION NO: DA 2023 / 310 1 DATE: 09 May 2025

## Part B: Please note that Part B of this form is publicly exhibited.

Full description of Proposal:	Use: Commercial Development: Expansion to existing hotel accommodation, with the						
	Large or complex proposals should be described in a letter or planning report.						
	Design and const	truction cost of proposal:	\$ 500,000.00 (estimate)				

Is all, or some the work already constructed:

No: 🗹 Yes: 🗖

Location of	Street address:
and the second	Suburb: Sorell, TAS Postcode: 7172
	Certificate of Title(s) Volume: 770657 Folio: 1

Current Use of Site	Commercial
------------------------	------------

Current Owner/s: McGill & Aung PTY LTD
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Is the Property on the Tasmanian Heritage Register?	No: 🗖 Yes: 🗹	lf yes, please provide written advice from Heritage Tasmania				
Is the proposal to be carried out in more than one stage?	No: 🗹 Yes: 🗖	If yes, please clearly describe in plans				
Have any potentially contaminating uses been undertaken on the site?	No: 🗹 Yes: 🗖	If yes, please complete the Additional Information for Non-Residential Use				
Is any vegetation proposed to be removed?	No: 🔲 Yes: 🗹	If yes, please ensure plans clearly show area to be impacted				
Does the proposal involve land administered or owned by either the Crown or Council?	No: 🗹 Yes: 🗖	If yes, please complete the Council or Crown land section on page 3				
If a new or upgraded vehicular crossing is required from Council to the front boundary please						
complete the Vehicular Crossing (and Associa	ted Works) applie	cation form				
https://www.sorell.tas.gov.au/services/engin	eering/					

Development Application: Development Application - 31 Walker Street, Sorell.pdf

Plans Reference:P1 Date Received:7/11/2023

PA V1: December 2022

#### Part B continued: Please note that Part B of this form is publicly exhibited

#### Declarations and acknowledgements

- I/we confirm that the application does not contradict any easement, covenant or restriction specified in the Certificate of Title, Schedule of Easements or Part 5 Agreement for the land.
- I/we consent to Council employees or consultants entering the site and have arranged permission and/or access for Council's representatives to enter the land at any time during normal business hours.
- I/we authorise the provision of a copy of any documents relating to this application to any person for the purposes of assessment or public consultation and have permission of the copyright owner for such copies.
- I/we declare that, in accordance with s52(1) of the Land Use Planning and Approvals Act 1993, that I have notified the owner(s) of the intention to make this application.
- I/we declare that the information in this application is true and correct.

Details of how the Council manages personal information and how you can request access or corrections to it is outlined in Council's Privacy Policy available on the Council website.

- I/we acknowledge that the documentation submitted in support of my application will become a public record held by Council and may be reproduced by Council in both electronic and hard copy format in order to facilitate the assessment process, for display purposes during public exhibition, and to fulfil its statutory obligations. I further acknowledge that following determination of my application, Council will store documentation relating to my application in electronic format only.
- Where the General Manager's consent is also required under s.14 of the *Urban Drainage Act 2013*, by making this application I/we also apply for that consent.

**Applicant Signature:** 

Signature:

	Crown or General Manager Land Owner Cons	ent
	his application is owned or administered by	
	ster or the Council General Manager whiche	
	npleted and signed by either the General Ma	
(as specified in \$52 (1D-1G) of th	e Land Use Planning and Approvals Act 1993	).
Please note:		
	f required, please first complete the General	Manager consent application
form available on our websit		
	own land you will also need a letter of conser	nt.
• Any consent is for the purpos	ses of making this application only and is not	consent to undertaken work or
take any other action with re	spect to the proposed use or development.	
5		
		being responsible for the
administration of land at		
declare that I have given nermiss	ion for the making of this application for	Development Application: Development Application - 31 Walker Street, Sorell.pdf
decidie that make grien permis.	source the making of this application for	
		Plans Reference:P1 Date Received:7/11/2023
Signature of General Manager,		
Minister or Delegate:	Signature:	Date:

PA V1: December 2022



# Tel: 03 6237 0440

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ABN 13 143 437 432



Development Application: 5.2023.310.1 -Response to Request For Information - 31 Walker Street, Sorell - P2.pdf Plans Reference: P2 Date received: 28/04/2025

# **TRAFFIC AND PARKING ASSESSMENT**

# **31 WALKER STREET, SORELL TAS 7172**

**CHANGE OF USE** 

Prepared for:	Chris Pooleys Drafting Services		
Date Prepared:	April 2024		
Revision:	1.0		
LOCAL GOVERNMENT AREA Development Application:	ТВА		



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# **Restrictions on Use**

This report has been prepared specifically for owners of 31 Walker Street, Sorell 7172 as the client. No part of this report may be referred to or quoted in any way without the written approval of the author. No party other than the owners of 31 Walker Street, Sorell 7172 may rely upon representation in this report for any purpose whatsoever, and the author accepts no liability for any such party relying upon this report.

# Limits of Report

This report considers the particular instructions and requirements of our client. AusWide Consulting has taken care in the preparation of this report. However, it neither accepts liability nor responsibility whatsoever in respect of:

- Any use of this report by a third party,
- Any third party whose interests may be affected by any decision made regarding the contents of this report, and/or
- Any conclusion drawn resulting from omission or lack of full disclosure by the client, or the clients' consultants.



# INTRODUCTION

AusWide Consulting has been engaged by Chris Pooleys Drafting Services to prepare a Traffic and Parking Assessment to expand the existing accommodation at 31 Walker Street, Sorell Tasmania 7172, with three self-contained cottages, and a storage shed, while extending the existing reception building as well as associated improvements to the driveway.

This report is to address points 1 and 2 from Sorell Council's request for information as follows:

- 1. Please provide an assessment discussing the traffic impact of the development, in particular stating the exact car parking deficiency (number) proposed with respect to the existing and proposed use. C2.5.1 2.
- Please detail dimensions for the proposed car parking spaces (bay width and lengths), and the combined access and manoeuvring width adjacent to parking spaces (aisle widths). – C2.6.1



# **BACKGROUND AND EXISTING CONDITIONS**

The subject site is in a General Residential Zone with off-street parking and available on-street parking within the surrounding local access road network. **Figure 1** provides an overall view of the subject site and the general surrounding area.

Public Transport is provided via Carlton/Didges Ferry & Sorell to Hobart services. On route bus stops are within 5 min walk form the subject site, with park and ride facilities being a 10 min walk. These services provide access to services accessing the greater region and Hobart. **Figure 2** on the next page shows the Carlton/Didges Ferry & Sorell to Hobart services which are available from the subject site.

The current site has 5 fully furnished cottage style units and based on RTA Guide to Traffic Generating Developments, version 2.2, October 2002(RTA Guide), such accommodation generates 3 vehicle trips per unit, and 0.4 per unit for the evening peak hour. As such there is an existing traffic generation of 30 vehicles per day, and 4 vehicles per hour for the evening peak hour.

The subject site is accessible via a shared driveway easement with 6 residential properties behind the subject site. The RTA Guide provides a trip generation of 9 vehicle trips per dwelling and a weekday peak hour vehicle trip of 0.85 per building. Existing traffic generation is 70 vehicles per day, and 8.5 vehicles per hour for the evening peak hour.

Current traffic generated for the shared property access is in the order of 100 vehicles per day with an evening peak volume of 12.5 vehicles per hour.


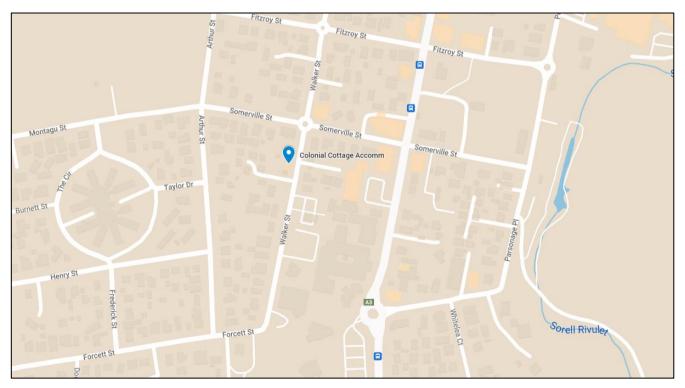


Figure 1 Site Location (Source: Google Maps)



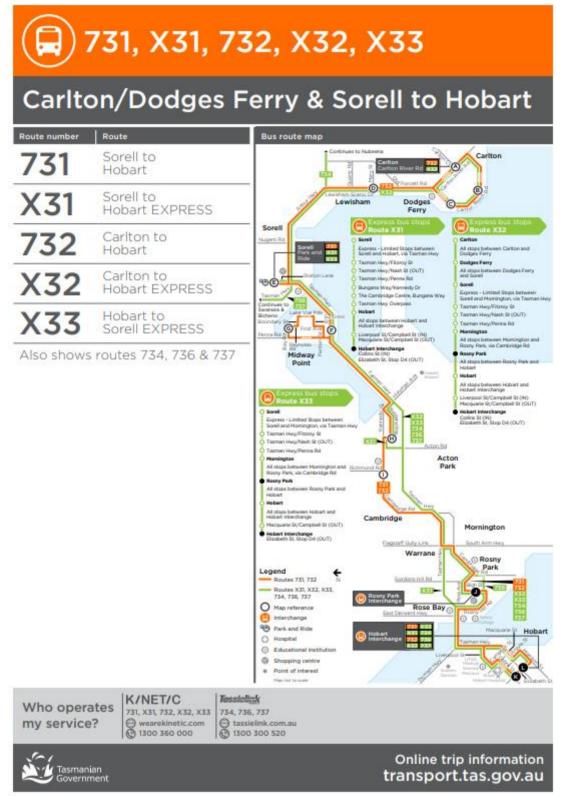

#### Figure 2 Transport Services (Source:

https://www.transport.tas.gov.au/public\_transport/bus\_timetables/south/carltondodges\_ferry\_and\_sorell\_to\_hobart)



# **ROAD NETWORK**

Walker Street follows a parallel connection with the Tasman Highway, linking the residential area to the South and West, with the General Business Zone to the East and North. There is no specific directional priority, with the intersections of Somerville Street and Fitzroy Street being controlled by roundabouts. Due to its connection, linking the state road network and General Business Zones, Walker Street functions at a minor collector level of function.

# Traffic Volume

An estimation of current volumes for Walker Street, between Arthur Street and Somerville Street, based on RTA Guide, and factoring a non-local traffic factor of 30% due to its collector road nature based on the following has been performed:

- Approximate collection of 110 properties at 9 vehicle trips per day, accessing Walker Street = Average Daily Total 1980 vpd.
- South East Trade Training Centre, Sorell Campus and Sorell School, assume 500 student average. AM trips at 0.52 vehicle trips, PM trips at 0.42 vehicle trips. 50% directional split = ADT 238 vpd.<sup>1</sup>
- 15% Non-local traffic = ADT 333 vpd.
- Peak hour factor = 12%.

Existing traffic volume on Walker Street, between Arthur Street and Somerville Street is estimated at ADT 2551 vpd, with a peak hour volume of 306 vph.

# Future Development traffic Generation

The subject site proposes the construction of 3 cottages and thus will increase traffic generation by 18 vehicles per day, with 1.2 vehicles per hour during the evening peak hour. The storage shed and extension to the reception is not considered to factor into traffic generation.

# Intersection Performance - Walker Street and Somerville Street Roundabout

The intersection of Walker Street and Somerville Street is the limiting extent of influence for the subject site. Visitors using the accommodation are likely to approach form the Tasman Highway, via Somerville Street and Walker Street.

SIDRA analysis has been performed based on the following assumptions:

• The assumption of relatively consistent and equivalent approach volumes has been assumed for the intersection, with a 50% split on all approaches = 176 veh/hr approach volumes on all legs. 10% heavy vehicles are assumed for the analysis.

**Table 1** on page 9 details the movement summary of the intersection.

<sup>&</sup>lt;sup>1</sup> Roads and Maritime Services Trip Generation Surveys Schools Analysis Report.



#### MOVEMENT SUMMARY

#### Site: 101 [Walker Street and Somerville Street Intersection]

New Site Site Category: (None) Roundabout

Mov	Turn	Dema	nd Flows	Deg.	Average	Level of	95% Back of (	Jueue	Prop.	Effective	Aver. No.	Average
	Tun	Total	HV	Satu	Delay	Service	Vehicles	Distance	Queued	Stop Rate	Cycles	Speed
		veh/h	%	v/c	sec		veh	m				km/h
South: W	alker Street											
1	L2	35	10.0	0.323	8.4	LOS A	1.6	11.9	0.48	0.72	0.48	41.
2	T1	53	10.0	0.323	7.9	LOS A	1.6	11.9	0.48	0.72	0.48	42.3
3	R2	88	10.0	0.323	10.5	LOS B	1.6	11.9	0.48	0.72	0.48	41.9
Approach		176	10.0	0.323	9.3	LOS A	1.6	11.9	0.48	0.72	0.48	41.
East: Son	nerville Street											
4	L2	53	10.0	0.332	8.7	LOS A	1.6	12.4	0.51	0.74	0.51	41.
5	T1	35	10.0	0.332	8.2	LOS A	1.6	12.4	0.51	0.74	0.51	36.
6	R2	88	10.0	0.332	10.9	LOS B	1.6	12.4	0.51	0.74	0.51	35.
Approach		176	10.0	0.332	9.7	LOS A	1.6	12.4	0.51	0.74	0.51	37.
North: Wa	alker Street											
7	L2	35	10.0	0.350	9.4	LOS A	1.7	13.1	0.55	0.76	0.55	34.
8	T1	88	10.0	0.350	8.9	LOS A	1.7	13.1	0.55	0.76	0.55	41.
9	R2	53	10.0	0.350	11.6	LOS B	1.7	13.1	0.55	0.76	0.55	35.
Approach		176	10.0	0.350	9.8	LOS A	1.7	13.1	0.55	0.76	0.55	38.
West: So	merville Street											
10	L2	35	10.0	0.349	9.4	LOS A	1.7	12.9	0.55	0.76	0.55	34.
11	T1	88	10.0	0.349	8.9	LOS A	1.7	12.9	0.55	0.76	0.55	36.
12	R2	53	10.0	0.349	11.6	LOS B	1.7	12.9	0.55	0.76	0.55	40.
\pproach		176	10.0	0.349	9.8	LOS A	1.7	12.9	0.55	0.76	0.55	37.
All Vehicle	es	703	10.0	0.350	9.7	LOS A	1.7	13.1	0.52	0.75	0.52	39.

Roundabout LOS Method: SIDRA Roundabout LOS. Vehicle movement LOS values are based on average delay per movement

Intersection and Approach LOS values are based on average delay for all vehicle movements.

Roundabout Capacity Model: SIDRA Standard. SIDRA Standard Delay Model is used. Control Delay includes Geometric Delay.

Gap-Acceptance Capacity: SIDRA Standard (<u>Akcelik</u> M3D). HV (%) values are calculated for All Movement Classes of All Heavy Vehicle Model Designation.

#### **Table 1 Movement Summary**

The current intersection has significant capacity to meet the negligible increase in traffic volumes due the development.

#### Level of Service

The roundabout of Walker Street and Somerville Street currently operates at a Level of Service A, with no change to level of service due to the increased traffic volume attributed to the proposed development.

### **Crash History**

A search of crash history for Walker Street and the roundabout with Somerville Street reveals 2 recorded crashes at the roundabout and 7 crashes occurring on Walker Street, between Arthur Street and Somerville since 2009. It is noted that there are no crash clusters identified. While crashes do occur, the instances of crashes are relatively random with no identifiable major contributor to crashes.<sup>2</sup>

2

https://www.arcgis.com/apps/mapviewer/index.html?url=https://data.stategrowth.tas.gov.au/ags/rest/services/P UBLIC/CDM CRASH/MapServer




# **IMPACT ON TRANSPORT NETWORK**

Overall, the subject site is consistent with land use characteristics and is of modest size and increase in current use. Due to current site constraints, there is insufficient capacity for significant growth likely to reduce the service life of the surrounding transport infrastructure. As such, the impact on of the development on the surrounding transport network is insignificant.

# ACTIVE AND PUBLIC TRANSPORT

A search of the walkability of the subject site has revealed a walk score of 58 out of 100.<sup>3</sup> This means that the location is somewhat walkable and that some errands can be accomplished on foot. However, it is noted that a significant proportion of the business and residential zones are with a 15 min walk form the subject site, as can be seen in **Figure 3** below.

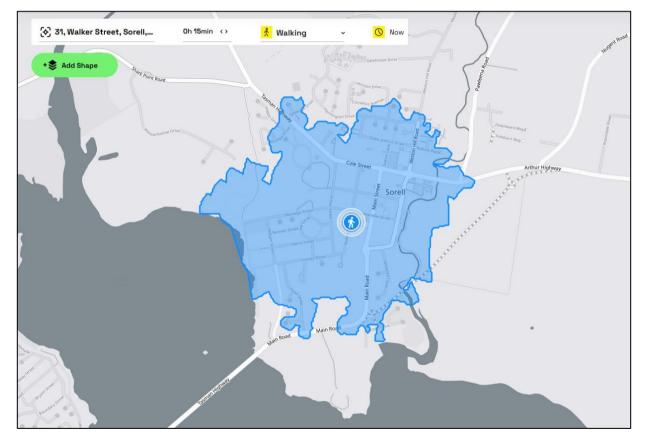

As such, the option of active travel for staff commutes and visiting guests is very convenient.

Figure 3 Travel Time Map (Source: https://app.traveltime.com/search/0-lng=147.55990&0-tt=15&0-mode=ferry&0title=31%2C%20Walker%20Street%2C%20Sorell%2C%20Hobart%2C%20Sorell%2C%20Tasmania%2C%207172%2C%20Austr alia&0-lat=-42.78467)

Public Transport is relatively limited in the local area. This is likely due to the size of Sorell being roughly a 15 min walk to cover the urban area. However, there is good provision of public

<sup>&</sup>lt;sup>3</sup> <u>https://www.walkscore.com/score/31-walker-st-sorell-tas-australia</u>



transport providing services to regional and metropolitan extents from the Carlton/Didges Ferry & Sorell to Hobart services.

# **PARKING DEMAND**

The subject site is classes as Visitor Accommodation, according to Tasmanian Planning Scheme – State Planning Provisions, Table C2.1 Parking Space Requirements. See **TABLE 2** below:

Use	Parking Space Requirements					
	Car	Bicycles				
Visitor Accommodation	1 Space per self-contained accommodation unit, allocated tent or caravan space, or 1 space per 4 beds, whichever is the greater.	No requirement				

Table 2 Visitor Accommodation Parking Space Requirements

The existing land use currently accommodates 5 cottage style units, with the proposed change of use to include another 3 cottage style units, totalling 8 cottage style units. A total of 8 parking spaces is required for the subject site.

A total of 8 parking bays are detailed on the proposed site plan, and as such there is appropriate off-street provided for the proposed development.

# **OFF-STREET PARKING LAYOUT**

The proposed parking layout consists of nine, 90 degree angle parking spaces, along a parking isle. Parking modules are based on user class 2 car parking facilities according to AS/NZS 2890.1, Table 1.1. The following minimum parking dimensions are required:

- Isle Width = 5.8m.
- Bay Width = 2.5m.
- Bay Length = 5.4m (No overhang) = 4.8m (With overhang).

Dimension reviewed form the proposed site plan are as follows:

- Bay 1 to 3 requires minimum 5.4m bay length and this is achieved.
- Bay 4 to 8 allows for overhang, allowing bay length of 4.8m and this is achieved.
- Minimum isle width of 5.8 is required and this is achieved with existing minimum width of 11m from parking bay 4 to 8, providing 6.2m isle width. Exceeding minimum isle width required.
- Bay width = 2.6m and exceeds minimum 2.5m bay width.

The off-street parking layout dimensions are compatible with AS/NZS 2890.1. **Figure 4** on page 12 shows general dimensions.



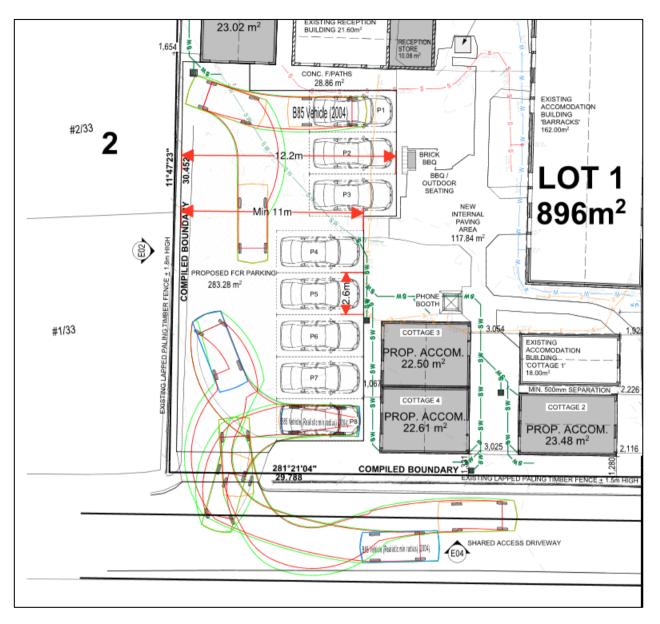


Figure 4 General Dimensions of Car Park



# CONCLUSIONS


Based on the assessment presented in this report, it is considered that:

- The proposed development is consistent with land use zoning;
- Traffic generated by the proposed development is unremarkable;
- Level of Service for the roundabout of Walker Street and Somerville Street remains unchanged at LOS A, with increased traffic volumes generated by the proposed development;
- Existing crash history shows no indication of environmental factors contributing to crashes, that would be affected by the proposed development;
- The minimum off-street parking required for the proposed development is provided;
- Proposed off-street parking area provides sufficient space for compliance with AS/NZS 2890.1;

In conclusion, this report indicates the proposed change in land use in not envisaged to have adverse impacts on the surrounding traffic or parking conditions. Therefore, the proposal should be supported on traffic and parking grounds.



# **Appendix A – PROPOSED SITE PLAN**

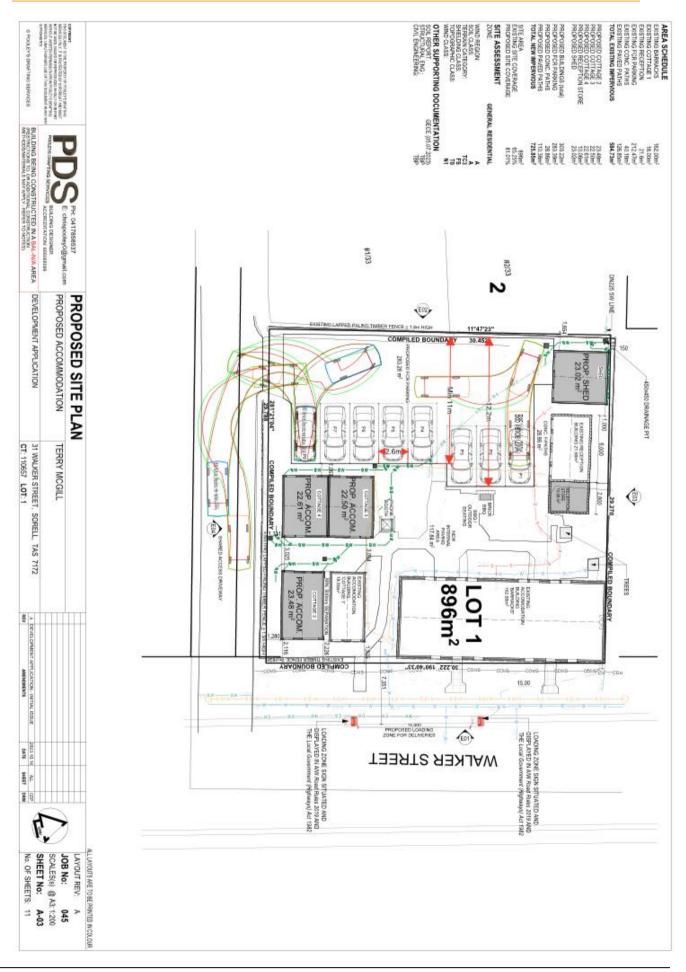

# 31 WALKER ST, SORELL, TAS 7172

# **CIVIL ENGINEERING DRAWINGS**



# LOCATION PLAN

SCALE: 1:20000

#### rell Council

plication: 5.2023.310.1 e to Request For Information - 31 eet, Sorell - P2.pdf

					GE CONSULTING ENGINEERS	© copyright GE CONSULTING ENGINEERS GE CONSULTING ENGINEERS RETAINS THE INTELLECTUAL PROPERTY RIGHTS OF THESE DRAWINGS, DESIGNS AND	ENGINEER: A.G-E.	SCALE: 1:20000	PROJECT: 31 WALKER
					+ CIVIL + STRUCTURAL	CONTENT THESE DRAWINGS CAN NOT BÉ RESOLD, REPRODUCED, COPIED OR ADAPTED IN ANYWAY WITHOUT WRITTEN CONSENT OF GE CONSULTING ENGINEERS. DIMENSIONS TO BE CHECKED ON SITE. DO NOT SCALE OFF DRAWINGS.	DRAFTER: CP	SIZE: A3	
00 REV	ISSUED FOR CONSTRUCTION	CP ISSUE DRAWN BY	A.G-E. CHK	30.09.2024 DATE	ABN64 629 573 897 ACN 629 573 897 42 SANDY BAY ROAD BATTERY POINT, TAS 7005 ADMINIGECE.COM AU	DESCREPANCIES TO BE NOTIFIED VIA EMAIL TO GE CONSULTING ENGINEERS.	STATUS: BUILDING APPI	LICATION	
		ISSUE DRAWN BT	GIR	DATE	0412 705 240				

### DRAWINGS CONTENTS LIST

C00	GECE COVER S
C01	NOTES
C02	GENERAL ARRA
C03	PARKING PLAN
C04	DRIVEWAY SWE
C05	DRIVEWAY SWE
C06	DRIVEWAY CON
C07	KERB DETAILS

SHEET

RANGEMENT VEPT PATHS - IN VEPT PATHS - OUT **NSTRUCTION DETAILS** 

R ST, SORELL, TAS 7172	DRAWING TITLE: GECE COVER SHEET	
	PROJECT No. 045	DWG No. C00
		REVISION: 00

# CIVIL NOTES

#### <u>GENERAL</u>

- 1. ALL WORKS TO BE CARRIED OUT IN ACCORDANCE WITH IPWEA STANDARD DRAWINGS AND SPECIFICATIONS, AND TO THE SATISFACTION OF COUNCIL'S DEVELOPMENT ENGINEER.
- 2. ALL EXISTING SERVICES TO BE LOCATED ON SITE PRIOR TO THE COMMENCEMENT OF WORKS.
- 3. ALL WORKS TO BE UNDERTAKEN IN ACCORDANCE WITH THE WHS ACT 2012.
- 4. ALL WORKS TO BE UNDERTAKEN IN ACCORDANCE WITH THE ISSUED PLANNING PERMIT.
- 5. ALL WORKS TO BE UNDERTAKEN TO THE APPROPRIATE AUSTRALIAN STANDARDS, BEST PRACTICE GUIDELINES AND THE DERWENT ESTUARY SITE MANAGEMENT GUIDELINES.
- 6. ALL EARTHWORKS TO BE UNDERTAKEN IN ACCORDANCE WITH THE EARTHWORKS STANDARD AS3798. FOR PRIVATE LAND AND EITHER LGAT SPECIFICATIONS OR STATE GROWTH SPECIFICATIONS FOR PUBLIC LAND WHERE APPLICABLE.
- FURTHER TO THE EARTHWORKS SPECIFICATION FOR EMBANKMENT CONSTRUCTION, THE EMBANKMENT SHALL BE INSTALLED OVERWIDTH AND CUT BACK TO ENSURE CONSISTENT COMPACTION ON THE BATTERS PRIOR TO TOPSOIL PLACEMENT.
- 8. WHEN BATTERS ARE CUT BACK THEY SHAL BE CUT BACK WITH A GP BUCKET AND SCORED HORIZONTAL / DIAGONAL TO HELP TOPSOIL REMAIN ON THE BATTER AND ASSIST IN GRASS GERMINATION AND GROWTH AND REDUCE THE LIKLYHOOD OF TOPSOIL LOSS.
- 9. THE TOPSOIL AND GRASS SEEDING SHALL BE UNDERTAKEN AS SOON AS POSSIBLE TO PREVENT / REDUCE EROSION AND WATERED AS PER THE MANUFACTURERS RECCOMENDATIONS FOR THE LOCAL ENVIRONMENT AND SEASON.

#### <u>DRIVEWAY</u>

- 1. DRIVEWAY SUBGRADE SHALL BE INSPECTED PRIOR TO PLACING OF GRAVEL.
- 2. ALL FILL BENEATH DRIVEWAY TO BE SUB BASE 1 40MM FCR.
- 3. CONCRETE & REINFORCING STEEL TO BE SUPPLIED AND INSTALLED IN ACCORDANCE WITH AS3600 AND MANUFACTURERS RECOMMENDATIONS.
- 4. CONCRETE STRENGTH AT 28DAYS IS TO BE 25MPa.
- 5. ALL GRAVEL SHALL BE SUPPLIED AND PLACED IN ACCORDANCE WITH PREVIOUS STATEGROWTH SPECIFICATION R40 UNLESS APPROVED OTHERWISE.
- ALL GRAVELS SHALL BE COMPACTED IN MAXIMUM 150MM LAYERS USING A 2.5T ROLLER OR 300+KG FORWARD REVERSE PLATE.
- 7. TOLERENCE OF FINISHED SURFACE; +/- 50MM FROM DESIGN LEVEL, +/- 10MM DEVIATION WHEN MEASURING AGAINST 3M STRAIGHT EDGE.
- 8. SAW CUTS SHALL BE UNDERTAKEN WITHIN 24HOURS AND CUT DIRECTLY ABOVE THE CRACK INDUCERS.
- 9. ALL DRIVEWAY EDGES SHALL BE ROUNDED USING EDGING TOOL.
- 10. JOINTS SHALL BE PLACED TO THE LOCATIONS SPECIFIED.

#### STORMWATER

- 1. ALL WORKS TO BE CARRIED OUT IN ACCORDANCE WITH AS 3500.3:2021, IPWEA(TAS) MUNICIPAL STANDARD DRAWINGS AND SPECIFICATION AND TO THE SATISFACTION OF COUNCILS MUNICIPAL ENGINEER.
- 2. ALL EXISTING SERVICES TO BE LOCATED ON SITE PRIOR TO THE COMMENCEMENT OF WORKS.
- 3. GENERAL MATERIALS, INSTALLATION & TESTING SHALL COMPLY WITH ANY APPLICABLE COUNCIL PERMIT CONDITIONS, AS3500.3:2021 & TASMANIAN MUNICIPAL STANDARD DRAWINGS.
- 4. ALL PIPE WORK UNDER TRAFFICABLE AREAS, INCLUDING DRIVEWAYS IS TO BE BACKFILLED WITH FCR IN ACCORDANCE WITH THE DETAILS PROVIDED.
- 5. LOT CONNECTION TO BE DN150 uPVC INCORPORATE AN INSPECTION OPENING RAISED TO THE SURFACE U.N.O.
- MINIMUM PIPE CLASS TO BE CLASS SN8.
- 7. ALL PITS LOCATED WITHIN THE TRAFFICABLE AREAS SHALL BE DRIVEABLE CLASS D.

## WATER NOTES

- 1. THE PIPE ALLIGNMENT AND EXISTING SERVICES SHALL BE FULLY LOCATED IN CONSIDERATION WITH ARCHITECTS PLANS PRIOR TO COMMENCEMENT TO ENSURE NO CLASHES EXISTS WITH OTHER SERVICES. CONFIRM FINAL LOCATION WITH SURVEYOR PRIOR TO START.
- 2. ALL WORKS SHALL BE UNDERTAKEN IN ACCORDANCE WITH TASWATER WATER SUPPLIMENT TO WSA 03-2011-3.1 MRWA v2.0 AND TW STANDARD DRAWINGS ON THE TASWATER DEVELOPMENT PORTAL, AS3500.1 WATER SERVICES AND TO THE SATISFACTION OF TASWATER'S DEVELOPMENT ENGINEER AND THE COUNCIL PLUMBING INSPECTOR FOR THEIR RESPECTIVE AREAS OF COMPLIANCE.
- 3. ALL PIPEWORK SHALL MEET THE WSA PS-215 & 216 SPECIFICATION.
- 4. ALL PIPEWORK SHALL BE PE100 CLASS PN16. A CONTINIOUS RUN, NO JOINS SHALL EXIST BETWEEN THE MANIFOLD AND THE DWELLING CONNECTION POINT (DCP\_. REFER TO THE ARCHIETCURAL PLANS FOR THE EXACT LOCATION OF THE DCP.
- 5. LINEWORK SHOWN IS NOT EXACT AND MAY VARY TO WITH WITH SITE CONSTRAINTS.
- 6. MINIMUM COVER IS 500mm. LOCATOR TAPE SHALL BE PROVIDED OVER THE TOP OF THE TRENCH OF EACH SERVICE LINE. MINIMUM SEPERATION WITH OTHER SERVICES IS 300mm. WATER PIPE SPACING OF MIN. 100mm IS REQUIRED AND ALL PIPES SHALL HAVE A MIN. 100mm OF CLEAN 7mm BLUE METAL GRAVEL AROUND THEM.
- ALL PIPEWORKS AND LAID PIPE SHALL BE PRESSURE TESTED IN ACCORDANCE WITH AS3500.1 AND TW GUIDELINES.
- 8. ALL WATER WORKS TO BE TASWATER AND COUNCIL APPROVED WORKS. CONTRACTOR TO ARRANGE FOR INSPECTIONS AND APPROVALS.

Sorell Council
Development Application: 5.2023.3


Development Application: 5.2023.310.1 -
Response to Request For Information - 31
Walker Street, Sorell - P2.pdf Plans Reference: P2 Date received: 28/04/2025

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				gace.com.au ABN64 629 573 897	OF GE CONSULTING ENGINEERS. DIMENSIONS TO BE CHECKED ON SITE. DO NOT SCALE OFF DRAWINGS.	СР	A3	-	PROJECT No. 045	DWG No. C01
ISSUED FOR CONSTRUCTION ISSUE DESCRIPTION	CP ISSUE DRAWN BY	A.G-E. CHK	30.09.2024 DATE	ADINO® 622 513 597 ACN 625 573 897 42 SANDY BAY ROAD BATTERY POINT, TAS 7005 ADMIN@GECE.COM.AU 0412 705 240	DESCREPANCIES TO BE NOTIFIED VIA EMAIL TO GE CONSULTING ENGINEERS.	STATUS: BUILDING APP	ICATION			REVISION: 00

2

#### SEWER NOTES

- 1. THE PIPE ALLIGNMENT AND EXISTING SERVICES SHALL BE FULLY LOCATED IN CONSIDERATION WITH ARCHITECTS PLANS PRIOR TO COMMENCEMENT TO ENSURE NO CLASHES EXISTS WITH OTHER SERVICES. CONFIRM FINAL LOCATION WITH SURVEYOR PRIOR TO START.
- 2. ALL WORKS SHALL BE UNDERTAKEN IN ACCORDANCE WITH TASWATER SEWER SUPPLIMENT TO WSA 02-2014-3.1 V2 AND TW STANDARD DRAWINGS ON THE TASWATER DEVELOPMENT PORTAL, AS3500.2:2021 SANITARY PLUMBING AND SRAINAGE AND TO THE SATISFACTION OF TASWATER'S DEVELOPMENT ENGINEER AND THE COUNCIL PLUMBING INSPECTOR FOR THEIR RESPECTIVE AREAS OF COMPLIANCE.
- 3. ALL PIPEWORK AND FITTINGS SHALL BE DN100 UPVC DWV SN8, JOINS SHALL BE SCJ INSPECTION OPENINGS SHALL BE LOCATED AS SHOWN.
- 4. NO 90 DEGREE BENDS ALLOWED WITHOUT APPROVAL (INCLUDING FOR INSPECTION OPENINGS).
- 5. MINIMUM COVER IS 600mm
- 6. MINIMUM FALL IS 2%
- 7. COUNCIL'S PLUMBING INSPECTOR SHALL BE CONTACTED PRIOR TO BACKFILL OF MAIN.
- THE MAIN SHALL BE BEDDED ON 100mm OF 7mm CLEAN METAL, IN A MINIMUM 300mm WIDE TRENCH AND SHALL BE COVERED WITH A MINIMUM OF 100mm THICK 7mm CLEAN AGGREGATE. LOCATOR TAPE SHALL BE PLACED OVER THE MAIN.
- ALL PIPEWORK SHALL BE PRESSURE TESTED IN ACCORDANCE WITH AS3500.2 AND TW GUIDELINES.
- 10. IF NEW CONNECTION REQUIRED AT REAR OF PROPERTY THE CONNECTION SHALL BE UNDERTAKEN AS PER MRWA-S-104A BY TASWATER APPROVED CONTRACTOR PLUMBER LISTED ON THEIR WEBSITE.
- 11. ALL WATER WORKS TO BE TASWATER AND COUNCIL APPROVED WORKS. CONTRACTOR TO ARRANGE FOR INSPECTIONS AND APPROVALS.

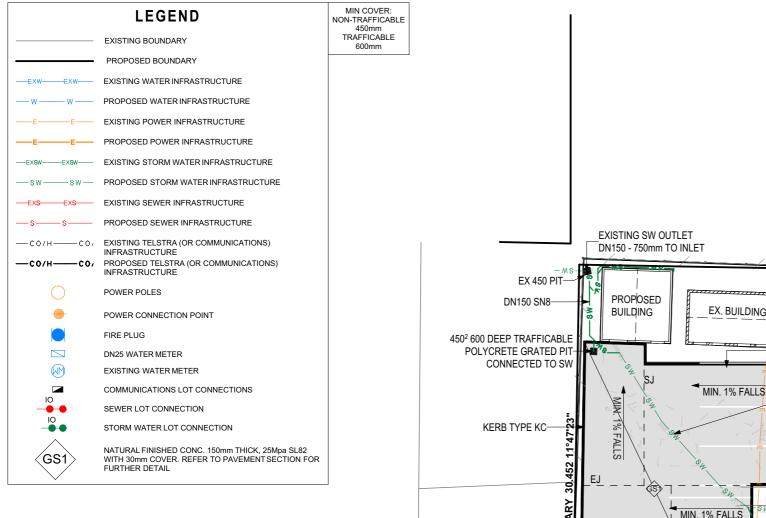




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nent Application: 5.2023.310.1 nse to Request For Information - 31 Street, Sorell - P2.pdf Reference: P2 aceived: 28/04/2025

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					gece.com.au	DIMENSIONS TO BE CHECKED ON SITE.	CP	A3	
						DO NOT SCALE OFF DRAWINGS.			-
00	ISSUED FOR CONSTRUCTION	CP	A.G-E.	30.09.2024	ABN64 629 573 897 ACN 629 573 897 42 SANDY BAY ROAD BATTERY POINT. TAS 7005	DESCREPANCIES TO BE NOTIFIED VIA EMAIL TO GE CONSULTING ENGINEERS.	STATUS: BUILDING APPLICATION		
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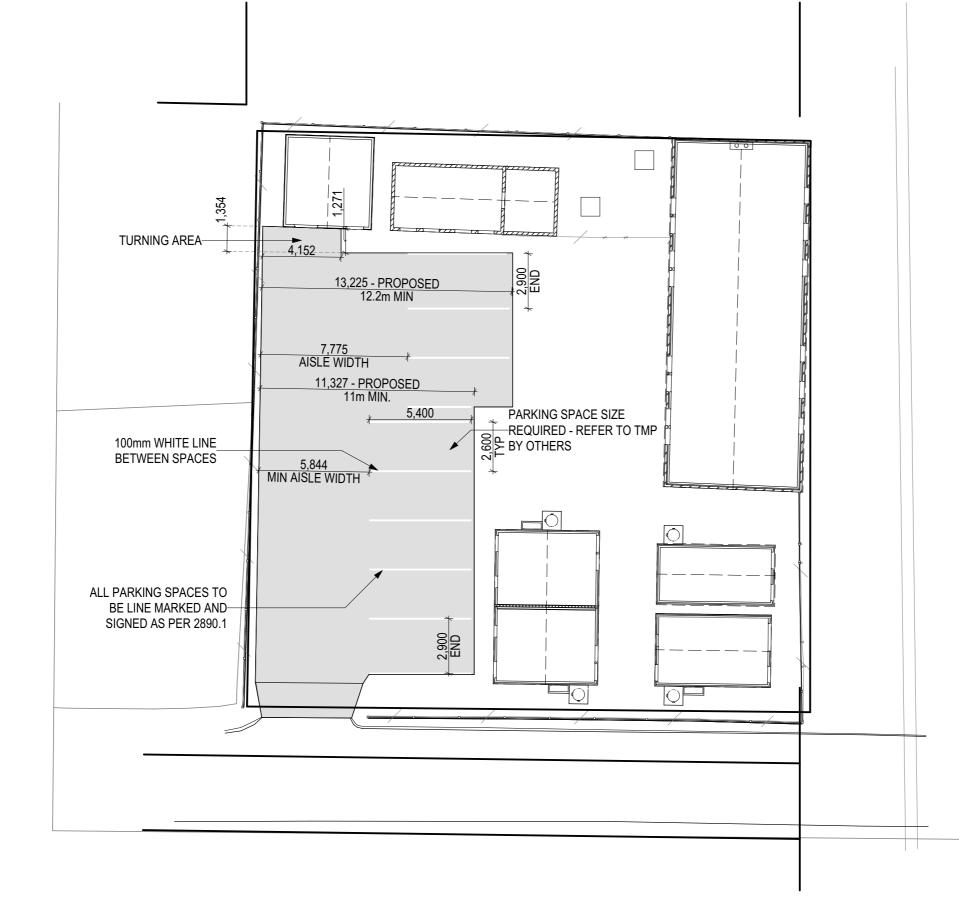


NOTE: THIS SET OF DRAWINGS SHOULD ALWAYSBE PRINTED IN COLOUR.

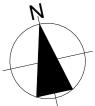R ST, SORELL, TAS 7172

DRAWING TITLE: GENERAL ARRANGEMENT


PROJECT No. DWG No. C02 045 REVISION: 00



Development Application: 5.2023.310.1 -Response to Request For Information - 31 Walker Street, Sorell - P2.pdf Plans Reference: P2 Jate received: 28/04/2025

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00 REV	ISSUED FOR CONSTRUCTION ISSUE DESCRIPTION	CP ISSUE DRAWN BY	A.G-E. CHK	30.09.2024 DATE	ABN44 623 573 897 ACR 629 573 897 42 SANDY BAY ROAD BATTERY POINT, TAS 7005 ADMIN@GECE.COM.AU 0412 705 240	DESCREPANCIES TO BE NOTIFIED VIA EMAIL TO GE CONSULTING ENGINEERS.	STATUS: BUILDING APPL	ICATION		



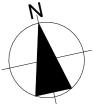


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. ER ST, SORELL, TAS 7172 DRAWING TITLE: PARKING PLAN

PROJECT No. 045 DWG No. C03

REVISION:

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Development Application: 5.2023.310.1 -Response to Request For Information - 31 Walker Street, Sorell - P2.pdf Plans Reference: P2 Jate received: 28/04/2025


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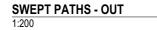
					GE CONSULTING ENGINEERS	© copyright GE CONSULTING ENGINEERS GE CONSULTING ENGINEERS RETAINS THE INTELLECTUAL PROPERTY RIGHTS OF THESE DRAWINGS, DESIGNS AND	ENGINEER: A.G-E.	SCALE: 1:200	PROJECT: 31 WALKER
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00 REV	ISSUED FOR CONSTRUCTION ISSUE DESCRIPTION	CP ISSUE DRAWN BY	A.G-E. CHK	30.09.2024 DATE	ABN64 629 573 897 ACN 629 573 897 42 SANBY BAY ROAD BATTERY POINT, TAS 7005 ADMIN@CECE.COM.AU 0412 705 240	DESCREPANCIES TO BE NOTIFIED VIA EMAIL TO GE CONSULTING ENGINEERS.	STATUS: BUILDING APPL	ICATION	
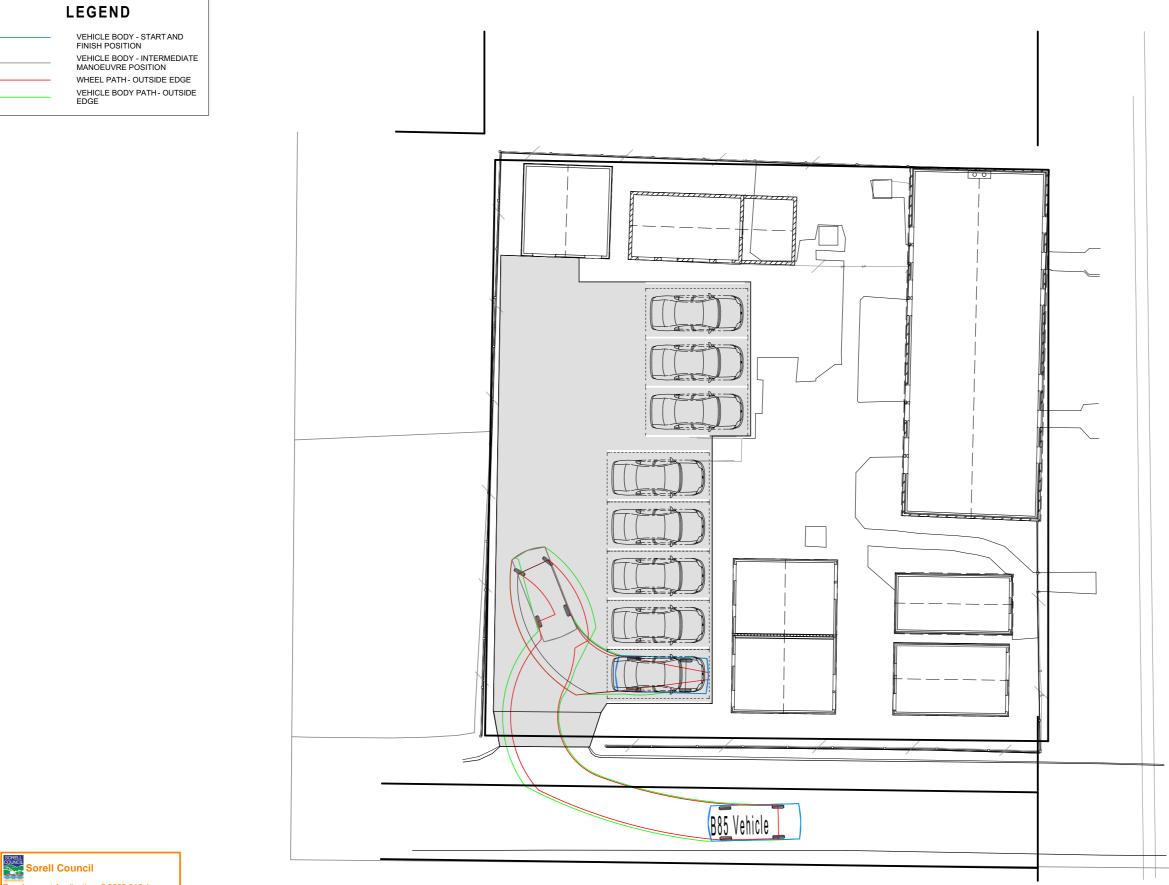
# WALKER STREET

: ER ST, SORELL, TAS 7172	DRAWING TITLE: DRIVEWAY SWEPT PATH	HS - IN				
	PROJECT No. 045	DWG No. C04				
		REVISION: 00				




Development Application: 5.2023.310.1 -Response to Request For Information - 31 Walker Street, Sorell - P2.pdf Plans Reference: P2 Date received: 28/04/2025

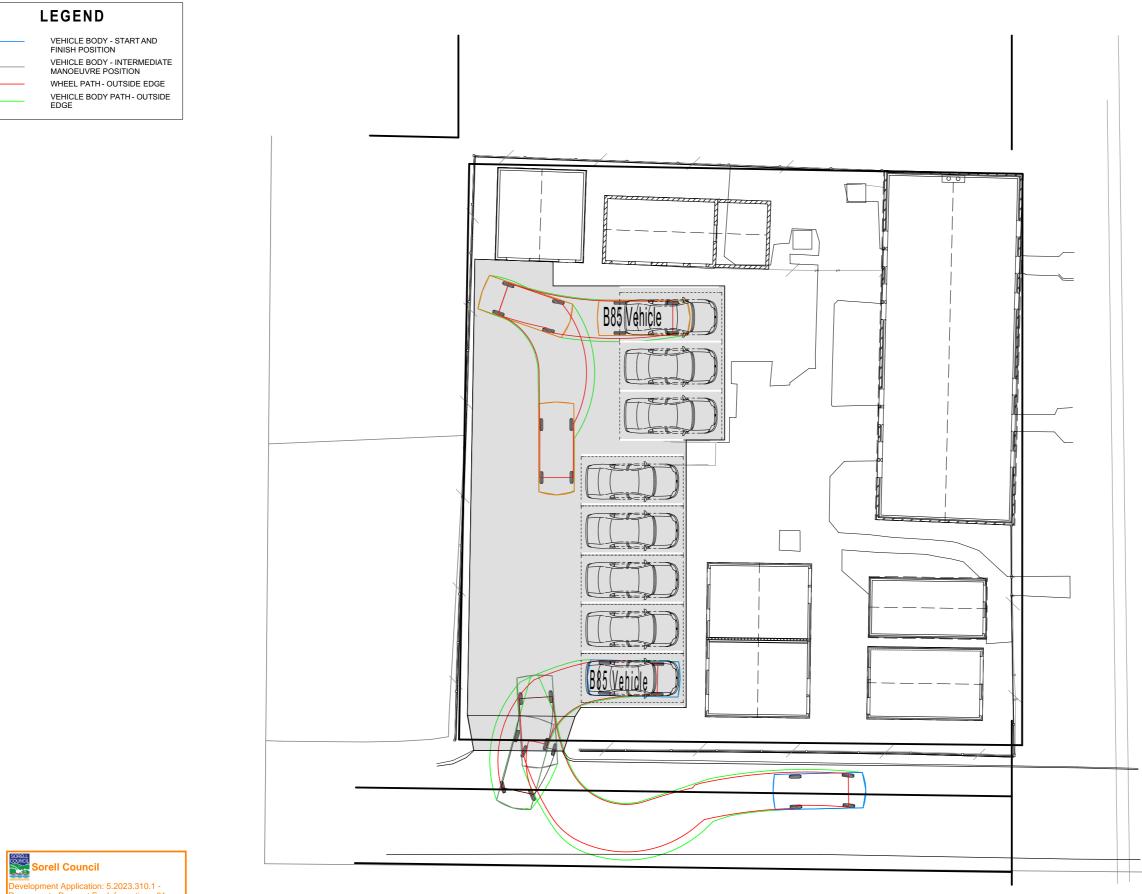


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REV ISSUE DESCRIPTION	ISSUE DRAWN BY	СНК	DATE			20122110711		


# WALKER STREET


R ST, SORELL, TAS 7172	DRAWING TITLE: DRIVEWAY SWEPT PATH:	S- OUT
	PROJECT No. 045	DWG No. C05
		REVISION: 00

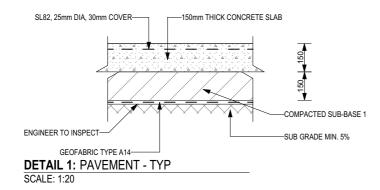

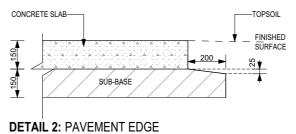

SCALE: 1:20

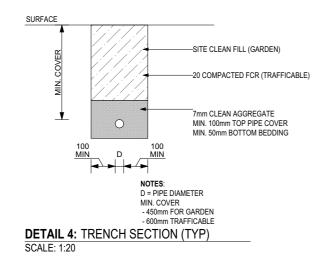

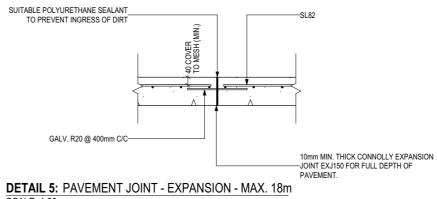


SCALE: 1:20

Sorell Council


Development Application: 5.2023.310.1 -Response to Request For Information - 31 Walker Street, Sorell - P2.pdf Plans Reference: P2 Jate received: 28/04/2025

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REV	ISSUE DESCRIPTION	ISSUE DRAWN BY	СНК	DATE	ADMIN@GECE.COM.AU 0412 705 240				

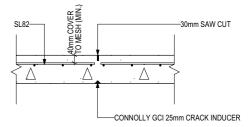

#### DETAIL 6: PAVEMENT JOINT - SAW CUT - MAX. 6m SCALE: 1:20

R ST, SORELL, TAS 7172	DRAWING TITLE: DRIVEWAY CONSTRUCTION	ON DETAILS
	PROJECT No. 045	DWG No. C06
		REVISION: 00

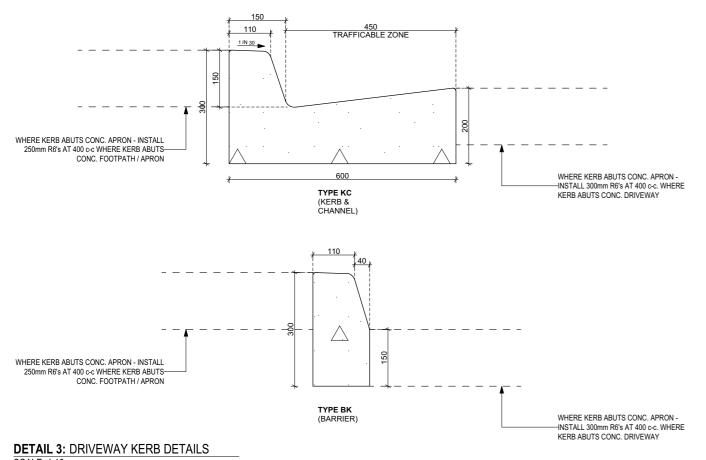

SCALE: 1:10

# Sorell Council

Development Application: 5.2023.310.1 -Response to Request For Information - 31 Walker Street, Sorell - P2.pdf Plans Reference: P2 Date received: 28/04/2025

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00	ISSUED FOR CONSTRUCTION CP	A.G-E.	30.09.2024	ABN64 629 573 897 ACN 629 573 897	DO NOT SCALE OFF DRAWINGS. DESCREPANCIES TO BE NOTIFIED VIA EMAIL TO GE CONSULTING	STATUS:		-
REV	ISSUE DESCRIPTION ISSUE DRAWN B		DATE	42 SANDY BAY ROAD BATTERY POINT, TAS 7005 ADMIN@GECE.COM.AU 0412 705 240	ENGINEERS.	BUILDING APPL	ICATION	

R ST, SORELL, TAS 7172	DRAWING TITLE: KERB DETAILS	
	PROJECT No. 045	DWG No. C07 REVISION: 00





# PROPOSED ACCOMODATION

### 31 WALKER ST, SORELL, TAS 7172

CLIENT: TERRY MCGILL

STAGE:	DEVELOPMENT APPLICATION
COUNCIL:	SORELL
TITLE REF:	110657 / 1
JOB No.:	045

REV	AMENDMENTS	DATE	SHEET	DRW
А	DEVELOPMENT APPLICATION - INITIAL ISSUE	2023.10.16	ALL	CDP
	ADDRESS RFI'S (COUNCIL, HERRITAGE)	28.04.2025	ALL	CDP

**REVISION SCHEDULE** 

AREA SCHEDULE		SHEE	
EXISTING BARRACKS EXISTING COTTAGE 1	162.00m <sup>2</sup> 18.00m <sup>2</sup>	No.	SHEET NAME
EXISTING RECEPTION	21.6m <sup>2</sup>	A-01	COVER SHEET
EXISTING FCR PARKING	212.47m <sup>2</sup>		EXISTING SITE PLAN
EXISTING CONC. PATHS EXISTING PAVED PATHS	40.18m <sup>2</sup> 126.85m <sup>2</sup>		PROPOSED SITE PLAN
TOTAL EXISTING IMPERVIOUS	584.73m <sup>2</sup>		CONCEPT SITE DRAINAGE PLAN
			COTTAGE FLOOR PLANS
PROPOSED COTTAGE 2 PROPOSED COTTAGE 3	23.48m <sup>2</sup> 22.50m <sup>2</sup>		SHED AND STORE FLOOR PLANS
PROPOSED COTTAGE 4	22.61m <sup>2</sup>		SITE ELEVATIONS
PROPOSED RECEPTION STORE PROPOSED SHED	10.08m <sup>2</sup> 23.02m <sup>2</sup>		SITE ELEVATIONS
			COTTAGE ELEVATIONS 1
PROPOSED BUILDINGS (total) PROPOSED FCR PARKING	303.22m <sup>2</sup> 283.39m <sup>2</sup>		COTTAGE ELEVATIONS 2
PROPOSED CONC. PATHS	28.86m <sup>2</sup>		3D PERSPECTIVE VIEWS COTTAGE ELECTRICAL PLAN
PROPOSED PAVED PATHS	110.38m <sup>2</sup>		COTTAGE ELECTRICAL PLAN
TOTAL NEW IMPERVIOUS	725.85m <sup>2</sup>	A-13	COTTAGE FLOOR COVERINGS
SITE AREA	896m <sup>2</sup>		
EXISTING SITE COVERAGE PROPOSED SITE COVERAGE	65.25% 81.01%		
SITE ASSESSMENT	01.0170		
	ERAL RESIDENTIAL		
WIND REGION: SOIL CLASS:	A		
TERRAIN CATEGORY: SHIELDING CLASS:	TC3 FS		
TOPOGRAPHIC CLASS:	T0		
WIND CLASS:	N1		
OTHER SUPPORTING DOCU			
SOIL REPORT: STRUCTURAL ENG.:	GECE (05.07.2023) TBP		
CIVIL ENGINEERING:	GECE (30.09.2024)		
TRAFFIC IMPACT ASSESSMENT	AUSWIDE (04.2024)	•	

SHEET REV.

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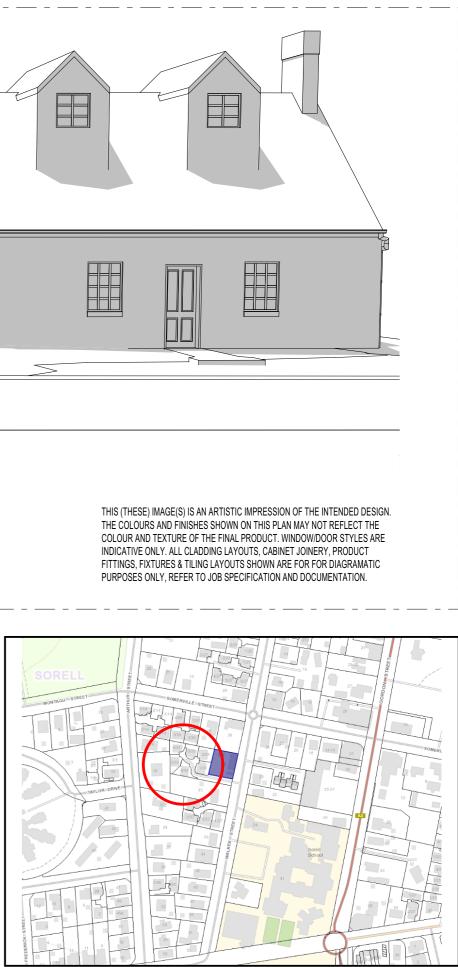
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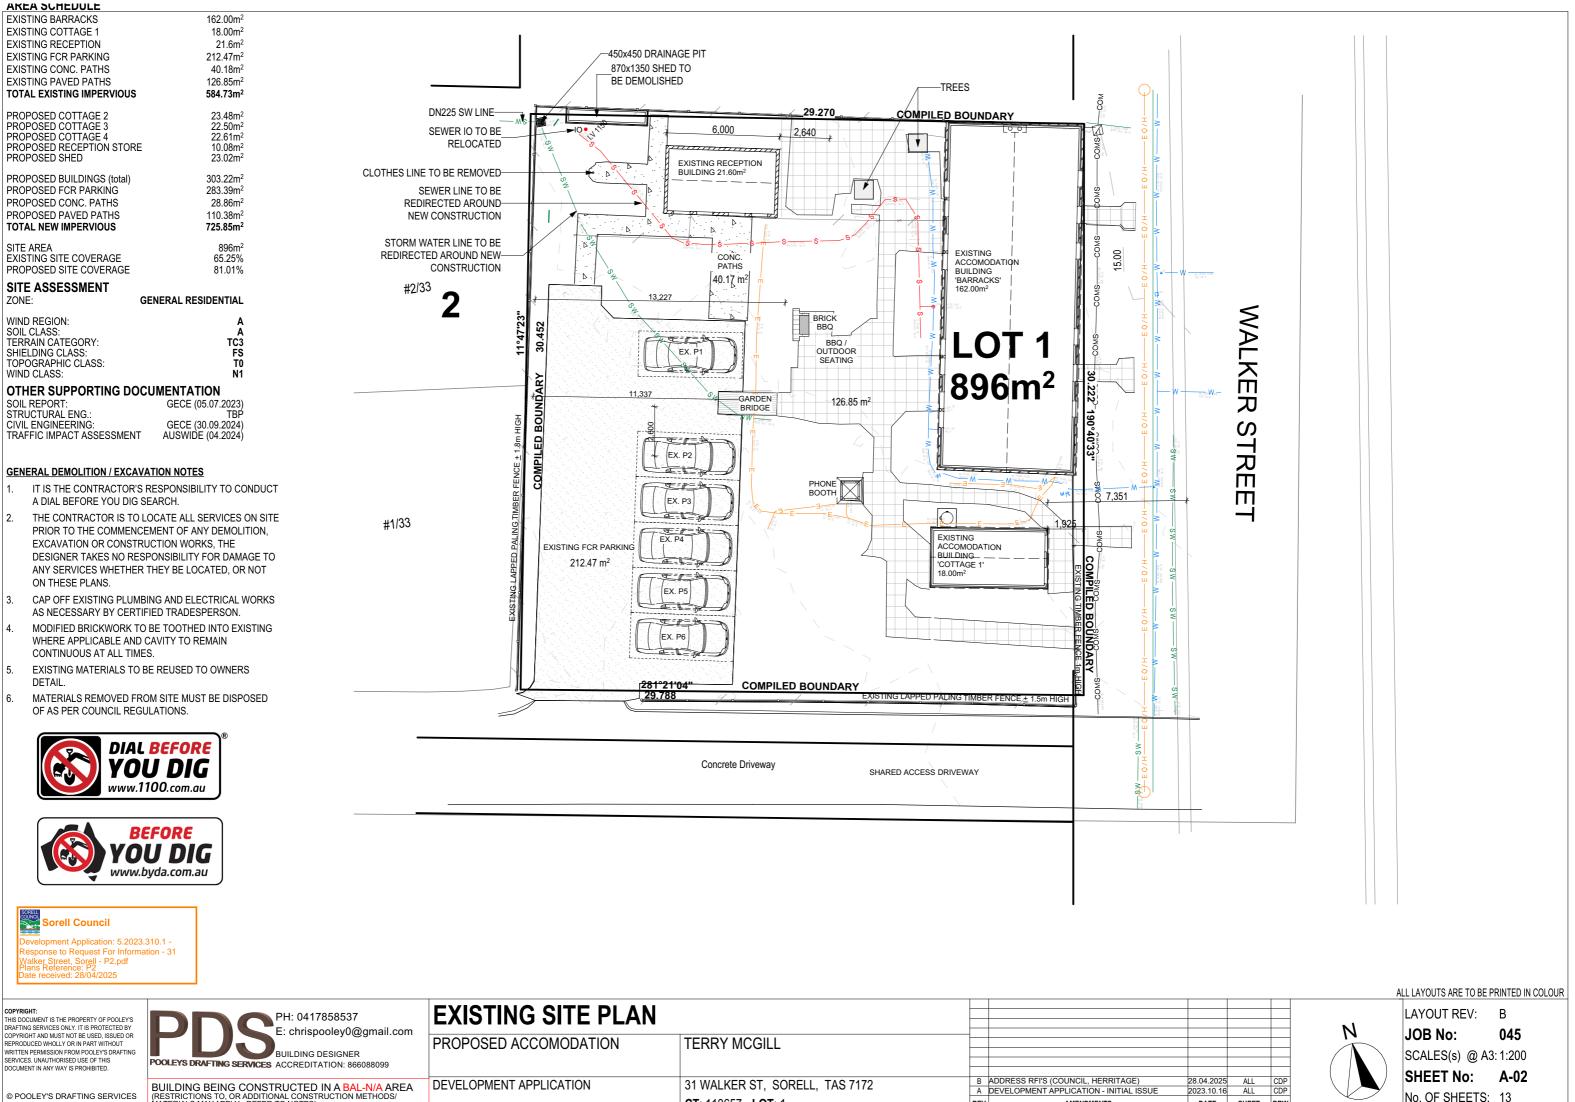
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SITE LOCATION


PH: 0417858537 E: chrispooley0@gmail.com BUILDING DESIGNER ACCREDITATION: 866088099






DATE SHEET DRW

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TTEN PERMISSION FROM POOLEY'S DRAFTING	BUILDING DESIGNER				
VICES. UNAUTHORISED USE OF THIS	POOLEYS DRAFTING SERVICES ACCREDITATION: 866088099				
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	BUILDING BEING CONSTRUCTED IN A BAL-N/A AREA	DEVELOPMENT APPLICATION	31 WALKER ST, SORELL, TAS 7172	В	ADDRESS RFI'S (COUNCIL, HERRITAGE)
	(RESTRICTIONS TO, OR ADDITIONAL CONSTRUCTION METHODS/		JI WALKEN JI, JONELL, TAUTIZ	Α	DEVELOPMENT APPLICATION - INITIAL ISSUE
FOOLET'S DRAFTING SERVICES	MATERIALS MAY APPLY - REFER TO NOTES)		CT 110657 LOT 1	REV	AMENDMENTS

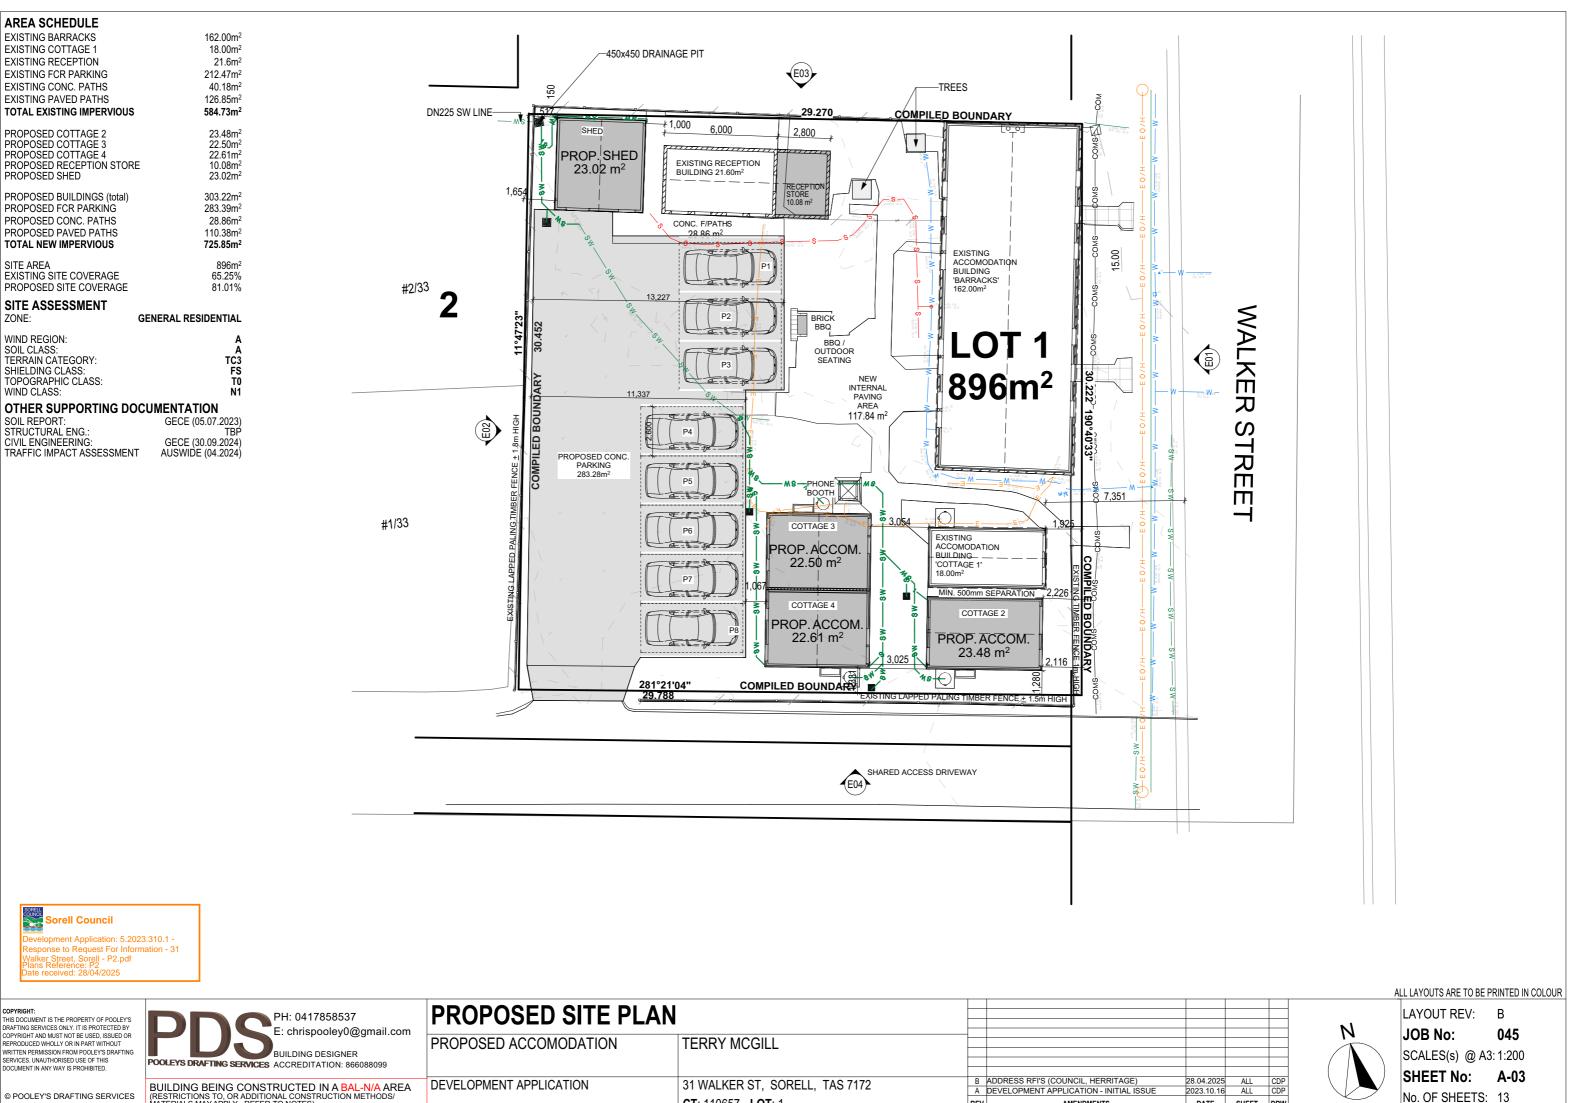

DATE SHEET DRW

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	E: chrispooley0@gmail.com BUILDING DESIGNER POOLEYS DRAFTING SERVICES ACCREDITATION: 866088099	PROPOSED ACCOMODATION	TERRY MCGILL		+
© POOLEY'S DRAFTING SERVICES	BUILDING BEING CONSTRUCTED IN A BAL-N/A AREA (RESTRICTIONS TO, OR ADDITIONAL CONSTRUCTION METHODS/ MATERIALS MAY APPLY - REFER TO NOTES)	DEVELOPMENT APPLICATION	31 WALKER ST, SORELL, TAS 7172 CT: 110657 LOT: 1	ADDRESS RFI'S (COUNCIL, HERRITAGE) DEVELOPMENT APPLICATION - INITIAL ISSUE V AMENDMENTS	28

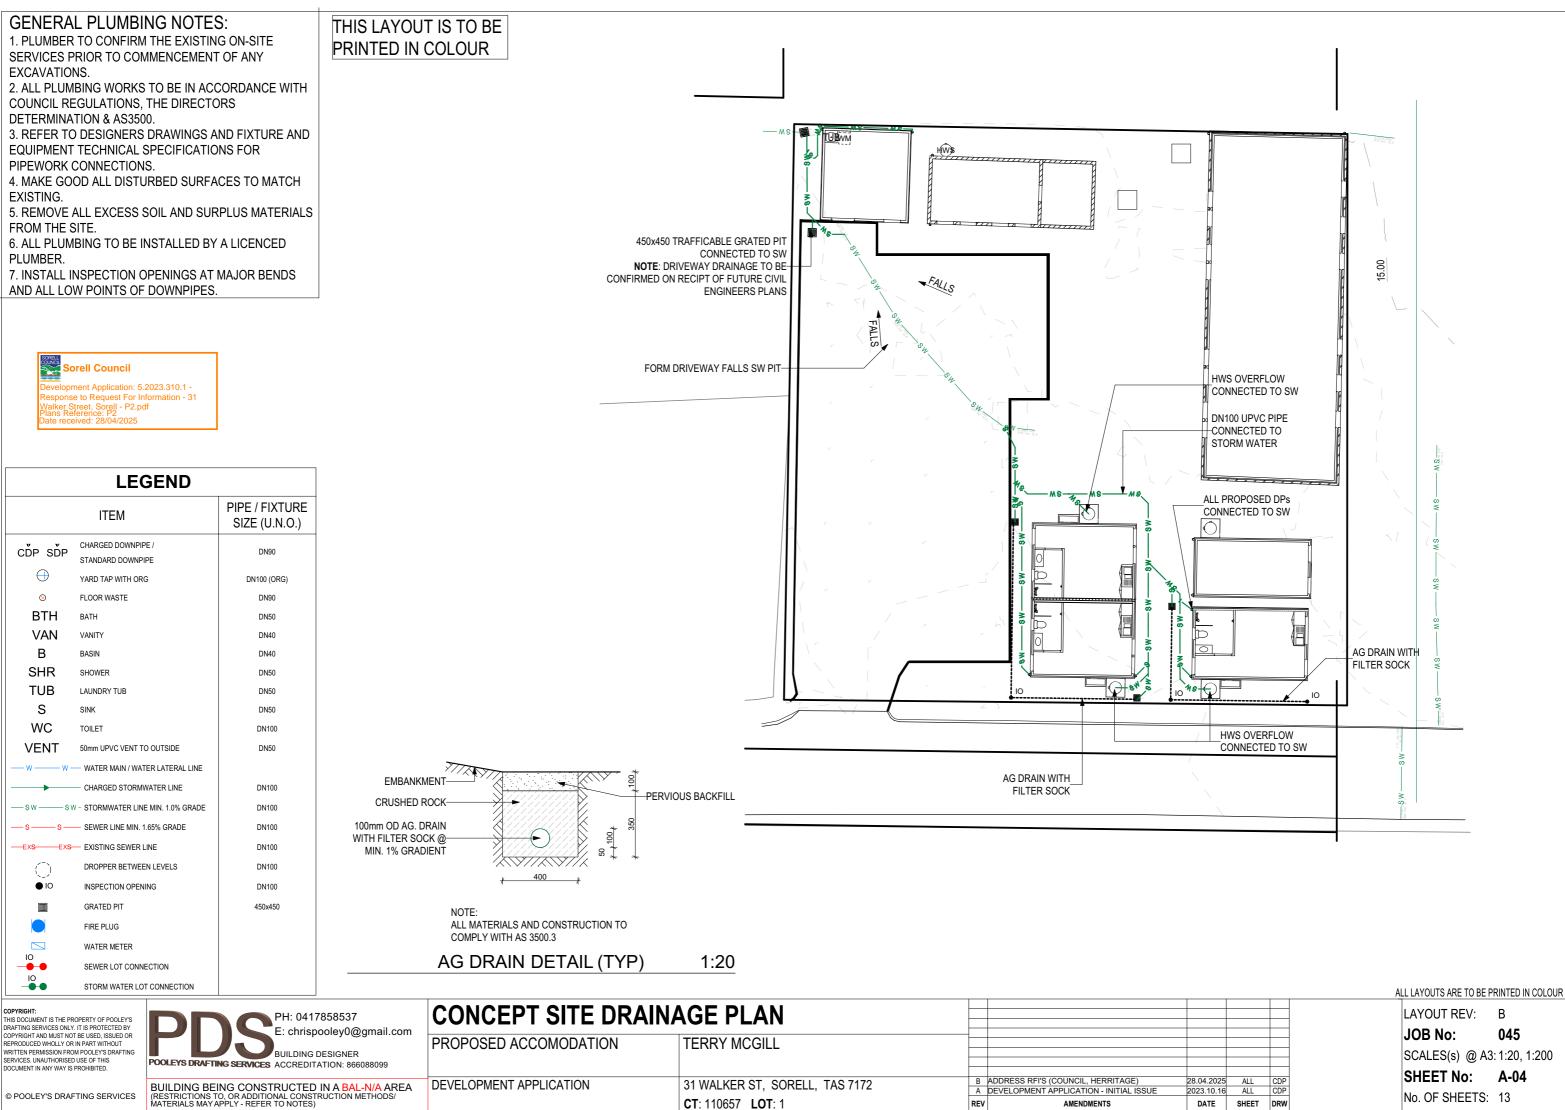

CT: 110657 LOT: 1

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AMENDMENTS

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				LAYOUT REV:	В
			-	JOB No:	045
			-	SCALES(s) @ A3:	1:20, 1:200
28.04.2025	ALL	CDP		SHEET No:	A-04
2023.10.16 DATE	ALL SHEET	CDP DRW	-	No. OF SHEETS:	13
DAIL	SHELL	DINW			

NEW BUILDINGS FLOOR AREA SCHEDULE				
AREA NAME	MEASURED AREA			
COTTAGE 2	23.48			
COTTAGE 3	22.50			
COTTAGE 4	22.61			
RECEPTION STORE	10.08			
SHED	22.98			
	101.65 m²			

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WALL SYSTEM


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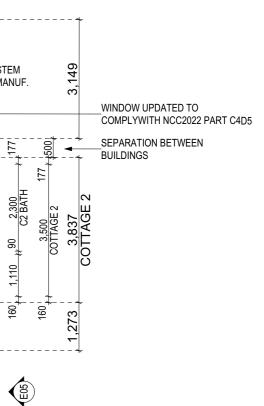
BUILDING BEING CONSTRUCTED IN A BAL-N/A AREA (RESTRICTIONS TO, OR ADDITIONAL CONSTRUCTION METHODS/ MATERIALS MAY APPLY - REFER TO NOTES) © POOLEY'S DRAFTING SERVICES


DEVELOPMENT APPLICATION 31 WALKER ST, SORELL, TAS 7172

CT: 110657 LOT: 1


B ADDRESS RFI'S (COUNCIL, HERRITAGE) A DEVELOPMENT APPLICATION - INITIAL ISSUE AMENDMENTS

REV

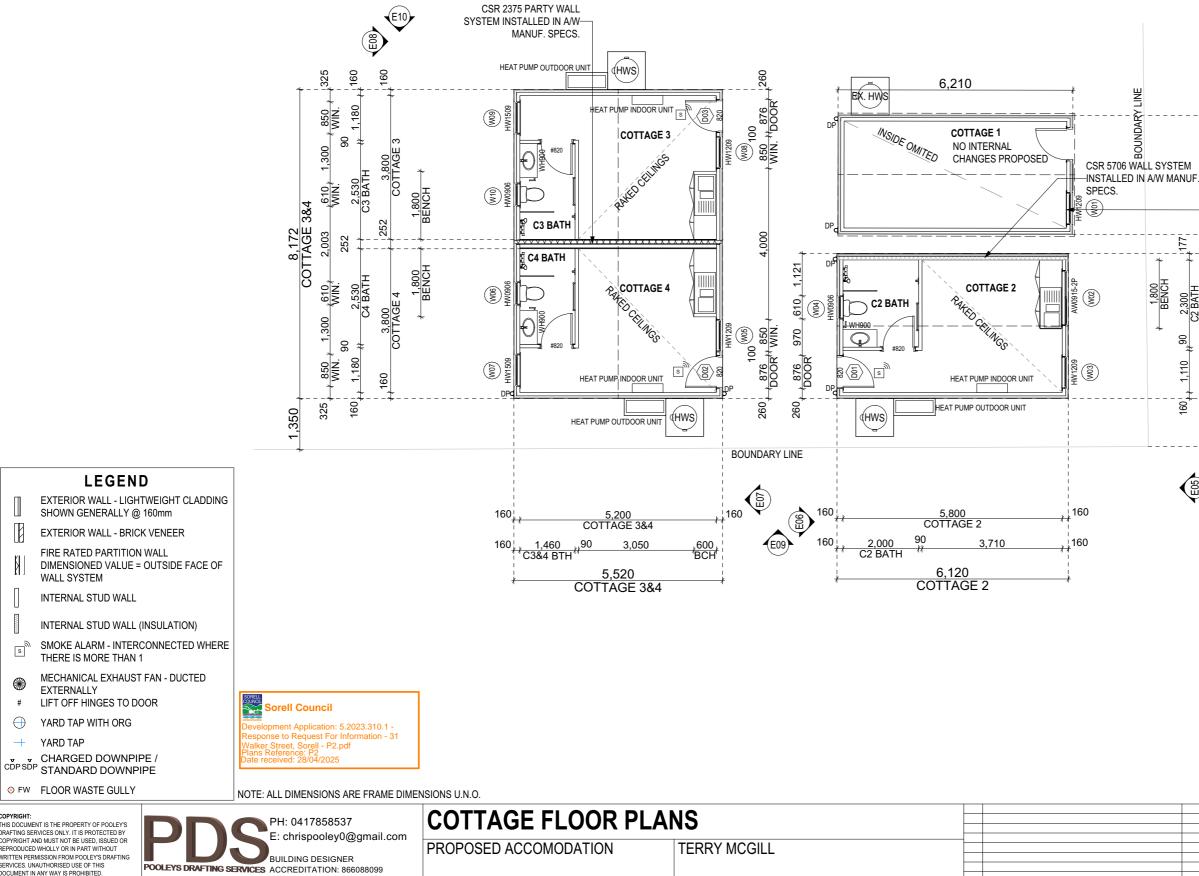

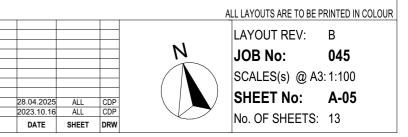

NEW BUILDINGS FLOOR AREA SCHEDULE				
AREA NAME	MEASURED AREA			
COTTAGE 2	23.48			
COTTAGE 3	22.50			
COTTAGE 4	22.61			
RECEPTION STORE	10.08			
SHED	22.98			
	101.65 m²			

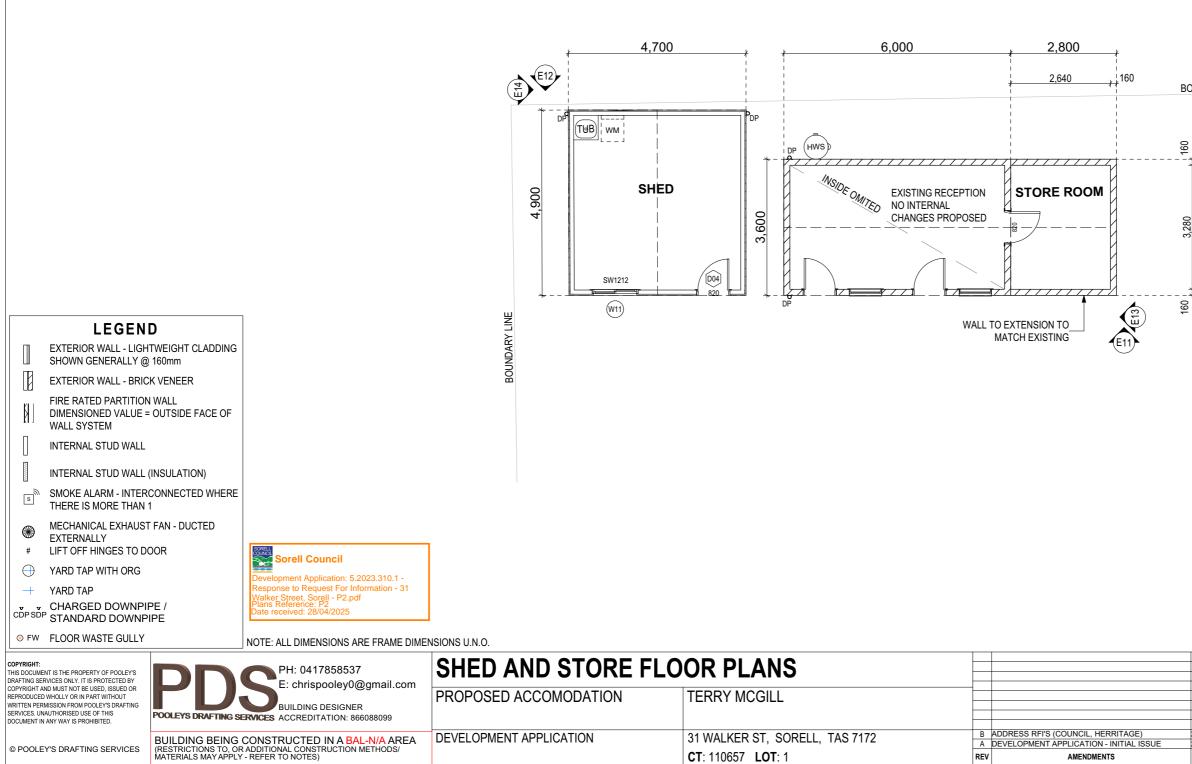


AMENDMENTS


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BOUNDARY LINE

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				JO	B No:	045
					ALES(s) @ A3:	1:100
	28.04.2025	ALL	CDP	SH	IEET No:	A-06
E	2023.10.16	ALL	CDP		OF SHEETS:	10
	DATE	SHEET	DRW	INO.	OF SHEETS.	15






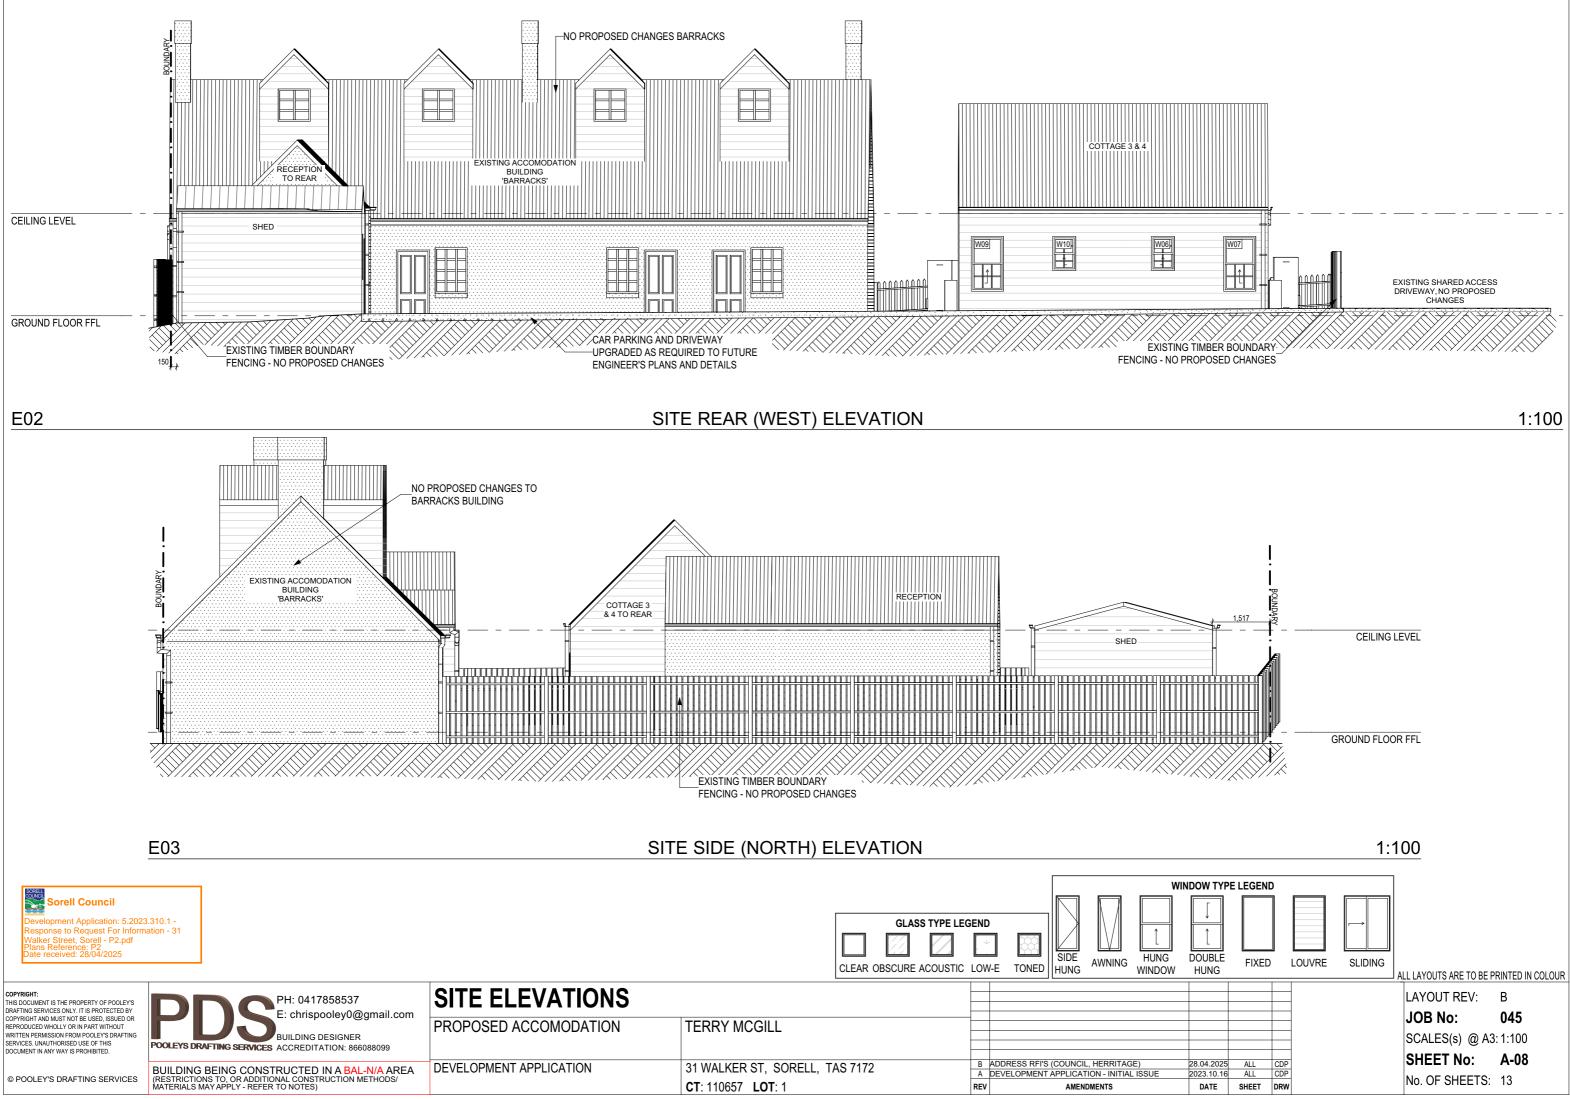

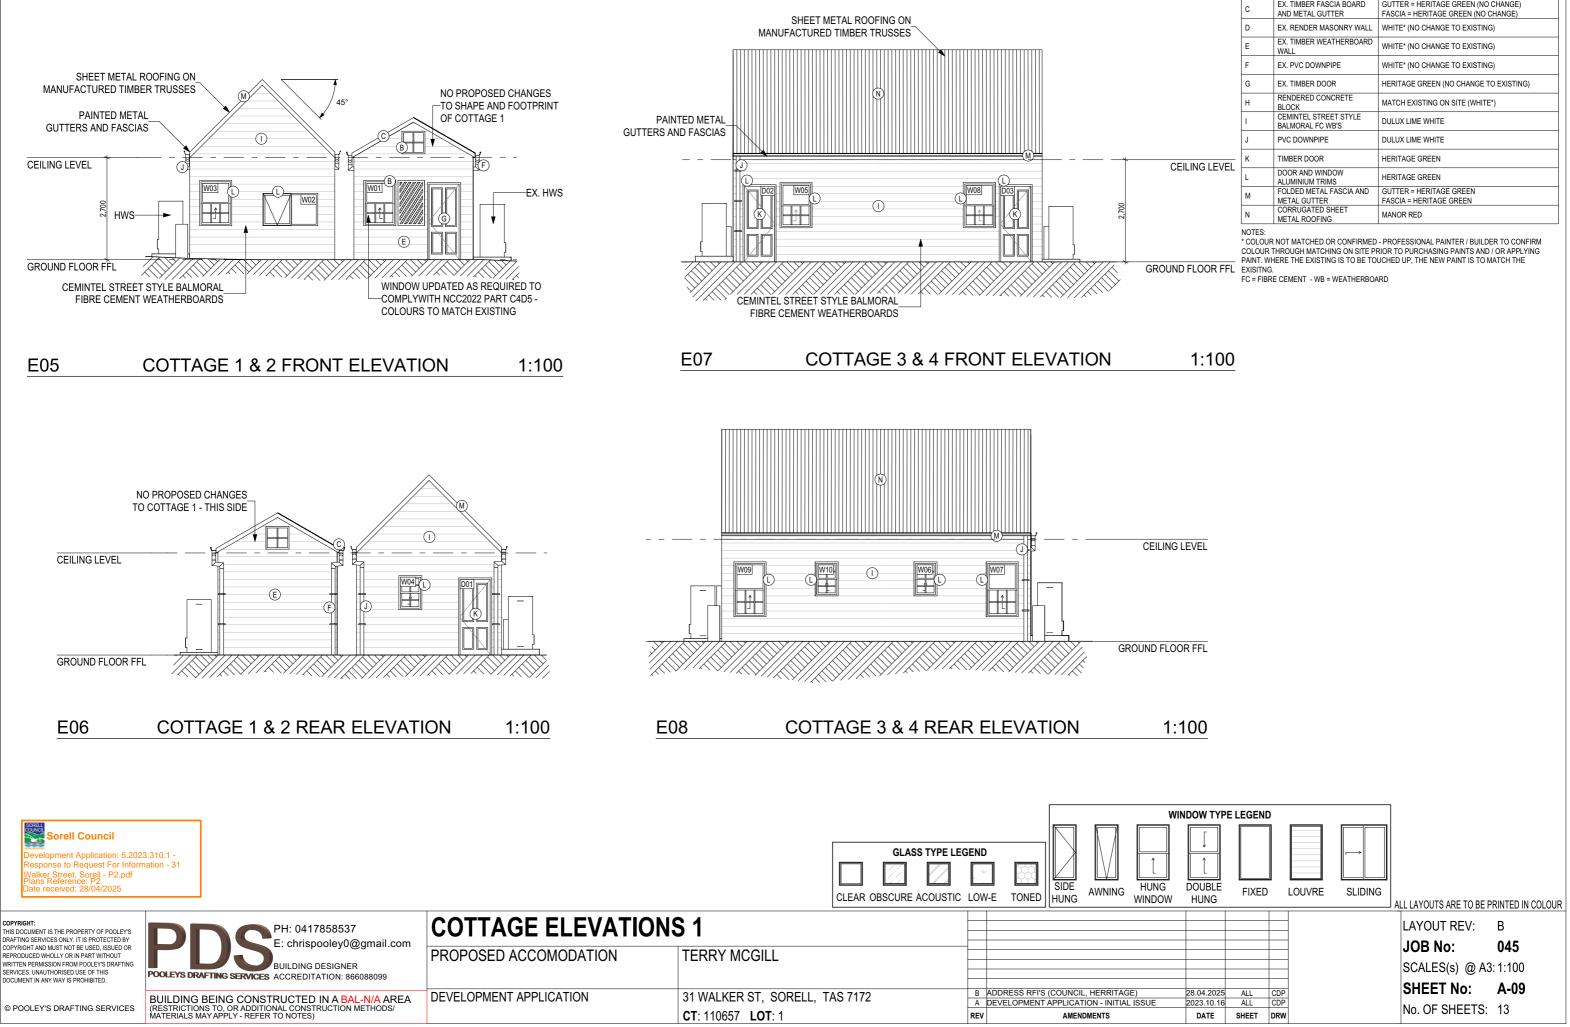
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		EXTERNAL F	INISHES SCHEDULE
	CODE	SURFACE MATERIAL	FINISH COLOUR
	A	EX. CORRUGATED SHEET METAL ROOFING	MANOR RED (NO CHANGE TO EXISTING)
	В	EX. DOOR AND WINDOW TIMBER TRIMS	HERITAGE GREEN (NO CHANGE TO EXISTING)
	С	EX. TIMBER FASCIA BOARD AND METAL GUTTER	GUTTER = HERITAGE GREEN (NO CHANGE) FASCIA = HERITAGE GREEN (NO CHANGE)
	D	EX. RENDER MASONRY WALL	WHITE* (NO CHANGE TO EXISTING)
	E	EX. TIMBER WEATHERBOARD WALL	WHITE* (NO CHANGE TO EXISTING)
	F EX. PVC DOWNPIPE		WHITE* (NO CHANGE TO EXISTING)
	G	EX. TIMBER DOOR	HERITAGE GREEN (NO CHANGE TO EXISTING)
	н	RENDERED CONCRETE BLOCK	MATCH EXISTING ON SITE (WHITE*)
	I	CEMINTEL STREET STYLE BALMORAL FC WB'S	DULUX LIME WHITE
	J	PVC DOWNPIPE	DULUX LIME WHITE
LING LEVEL	к	TIMBER DOOR	HERITAGE GREEN
	L	DOOR AND WINDOW ALUMINIUM TRIMS	HERITAGE GREEN
	М	FOLDED METAL FASCIA AND METAL GUTTER	GUTTER = HERITAGE GREEN FASCIA = HERITAGE GREEN
	N	CORRUGATED SHEET METAL ROOFING	MANOR RED
FLOOR FFL	COLOUR 1 PAINT, WH	THROUGH MATCHING ON SITE PE	- PROFESSIONAL PAINTER / BUILDER TO CONFIRM RIOR TO PURCHASING PAINTS AND / OR APPLYING UCHED UP, THE NEW PAINT IS TO MATCH THE



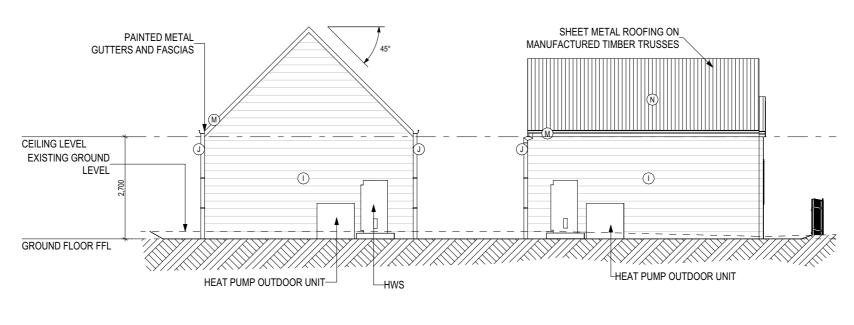

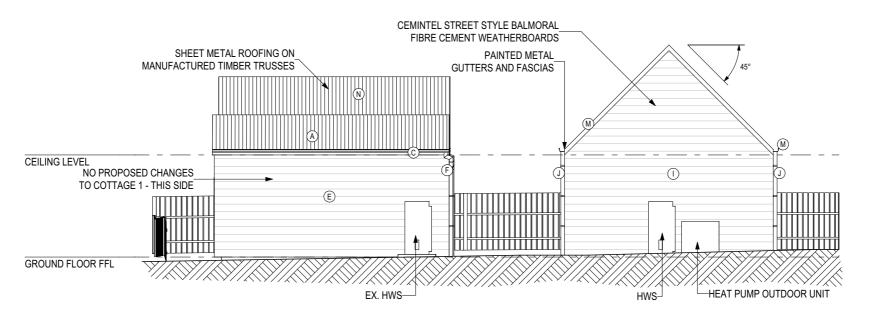

E10

# COTTAGE SIDE (NORTH) ELEVATION

1:100

Sorell Council Development Application: 5.2023.310.1 -Response to Request For Information - 31 Walker Street, Sorell - P2.pdf Plans Reference: P2 Data received: 28/04/2025

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© POOLEY'S DRAFTING SERVICES	BUILDING BEING CONSTRUCTED IN A BAL-N/A AREA (RESTRICTIONS TO, OR ADDITIONAL CONSTRUCTION METHODS/ MATERIALS MAY APPLY - REFER TO NOTES)	DEVELOPMENT APPLICATION	31 WALKER ST, SORELL, TAS 7172 CT: 110657 LOT: 1	ADDRESS RFI'S (COUNCIL, HERRITAGE) DEVELOPMENT APPLICATION - INITIAL ISSUE AMENDMENTS	28

# EXTERNAL FINISHES SCHEDULE


CODE	SURFACE MATERIAL	FINISH COLOUR					
А	EX. CORRUGATED SHEET METAL ROOFING	MANOR RED (NO CHANGE TO EXISTING)					
В	EX. DOOR AND WINDOW TIMBER TRIMS	HERITAGE GREEN (NO CHANGE TO EXISTING)					
С	EX. TIMBER FASCIA BOARD AND METAL GUTTER	GUTTER = HERITAGE GREEN (NO CHANGE) FASCIA = HERITAGE GREEN (NO CHANGE)					
D	EX. RENDER MASONRY WALL	WHITE* (NO CHANGE TO EXISTING)					
E	EX. TIMBER WEATHERBOARD WALL	WHITE* (NO CHANGE TO EXISTING)					
F	EX. PVC DOWNPIPE	WHITE* (NO CHANGE TO EXISTING)					
G	EX. TIMBER DOOR	HERITAGE GREEN (NO CHANGE TO EXISTING)					
Н	RENDERED CONCRETE BLOCK	MATCH EXISTING ON SITE (WHITE*)					
I	CEMINTEL STREET STYLE BALMORAL FC WB'S	DULUX LIME WHITE					
J	PVC DOWNPIPE	DULUX LIME WHITE					
К	TIMBER DOOR	HERITAGE GREEN					
L	DOOR AND WINDOW ALUMINIUM TRIMS	HERITAGE GREEN					
М	FOLDED METAL FASCIA AND METAL GUTTER	GUTTER = HERITAGE GREEN FASCIA = HERITAGE GREEN					
Ν	CORRUGATED SHEET METAL ROOFING	MANOR RED					

NOTES:


\* COLOUR NOT MATCHED OR CONFIRMED - PROFESSIONAL PAINTER / BUILDER TO CONFIRM COLOUR THROUGH MATCHING ON SITE PRIOR TO PURCHASING PAINTS AND / OR APPLYING PAINT. WHERE THE EXISTING IS TO BE TOUCHED UP, THE NEW PAINT IS TO MATCH THE EXISTING.

FC = FIBRE CEMENT - WB = WEATHERBOARD

			A	LL LAYOUTS ARE TO BE PI	RINTED IN COLOUR
				LAYOUT REV:	В
				JOB No:	045
				SCALES(s) @ A3	: 1:100
28.04.2025	ALL	CDP		SHEET No:	A-10
2023.10.16		CDP		No. OF SHEETS:	13
DATE	SHEET	DRW		NO. OF ONLETO.	10

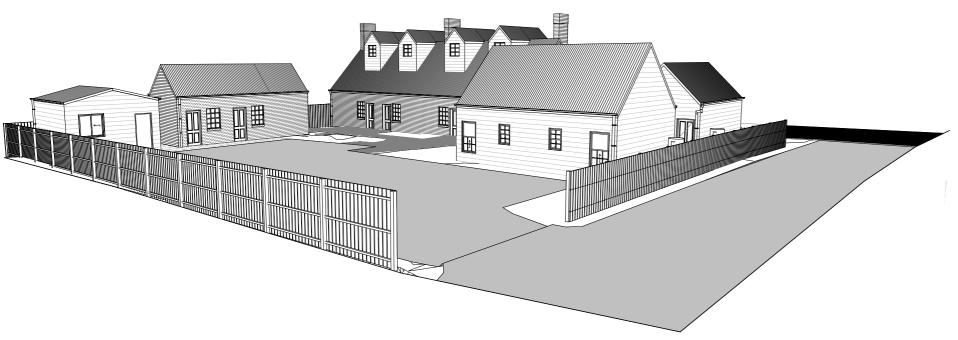

PERSPECTIVE 1

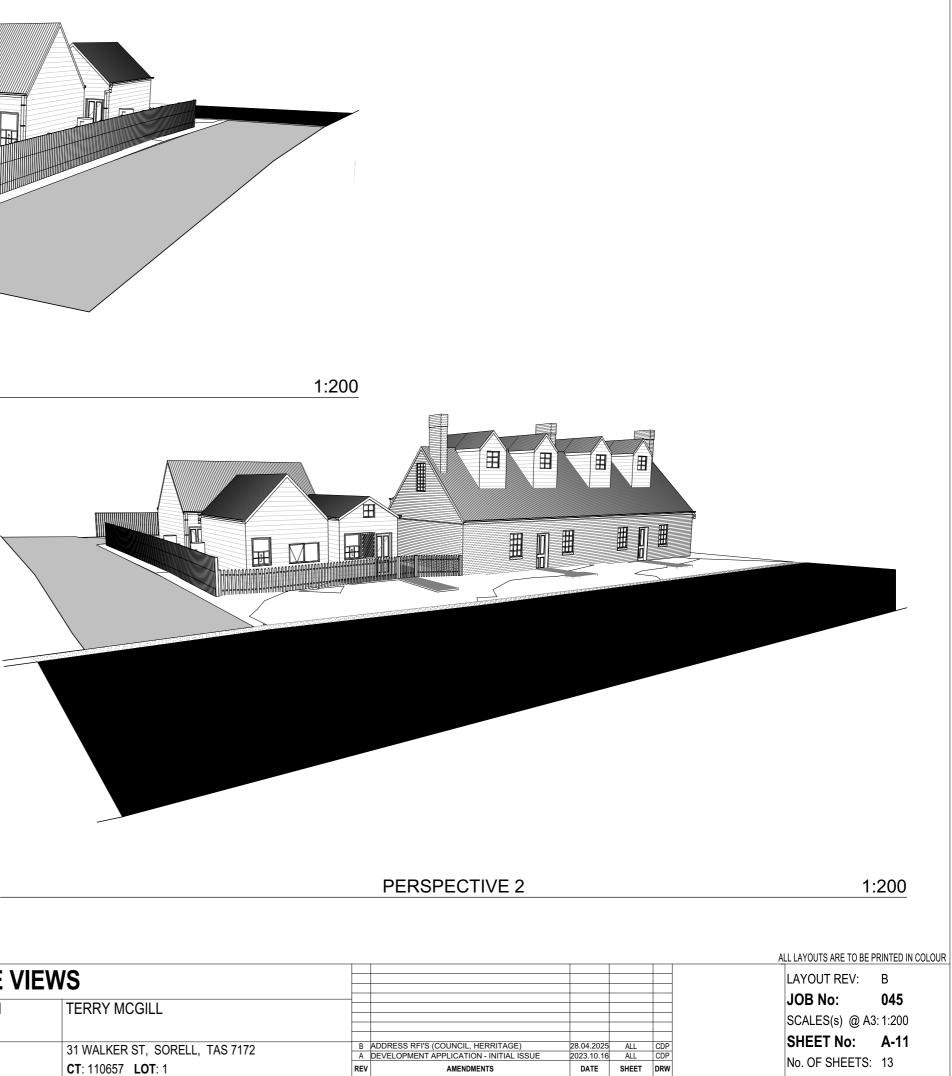

SORELL Sorell Council

evelopment Application: 5.2023.310.1 -esponse to Request For Information - 31 (alker Street, Sorell - P2.pdf ans Reference: P2 ate received: 28/04/2025

No. OF SHEETS: 13

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© POOLEY'S DRAFTING SERVICES	BUILDING BEING CONSTRUCTED IN A BAL-N/A AREA (RESTRICTIONS TO, OR ADDITIONAL CONSTRUCTION METHODS/ MATERIALS MAY APPLY - REFER TO NOTES)	DEVELOPMENT APPLICATION	31 WALKER ST, SORELL, TAS 7172 CT: 110657 LOT: 1	B ADDRESS RFI'S (COUNCIL, HERRITAGE) A DEVELOPMENT APPLICATION - INITIAL ISSUE REV AMENDMENTS	28.0 202

## LEGEND


Ģ	CEILING LIGHT (FLUSH) - 30W
$\mathbf{X}$	LEDIux STARLIGHT DOWN LIGHT - 3.5W
Ū	WALL MOUNTED LIGHT - 30W
•••	TASTIC - 8W (CENTRAL LIGHT)
۲	PENDANT LIGHT FITTING
	SINGLE TUBE LIGHT
$\times$	LIGHT SWITCH POINT
$\times^{x}$	MULTI GANG LIGHT SWITCH POINT *x DENOTES NO. OF SWITCHES
· · · · · ·	LIGHT SWITCH CONNECTION *2 DENOTES MULTI WAY SWITCH
s	SMOKE ALARM
۲	MECHANICAL EXHAUST FAN
	DGPO
	SINGLE GPO
	OUTDOOR DGPO
Ľ.	USB POINT
<b></b>	TV POINT
	NBN POINT
6	DATA SOCKET (CAT 5 OR 6)
	CEILING FAN
0))	LIGHT SENSOR
$\boxtimes$	PRE-WIRE ONLY


SPOTLIGHT, SINGLE HEAD  $\odot$ ¢


NOTES: NOTES: -WATTAGES SHOWN ARE AN ESTIMATE ONLY FOR CALCULATION PURPOSES, REF. TO SPECIFICATION FOR PRODUCT SPECIFIC WATTAGES. - PROVIDE SINGLE GPO TO MWS, REF SPACE, RANGE HOOD & DWS, UNLESS SPECIFICALLY NOTED NOT TO. - ALL GPOS, TV POINTS, DATA SOCKETS AND NEN TO BE 200000 ADVIE EFE UNDESS NOTED OTHER WICE 300mm ABOVE FFL UNLESS NOTED OTHERWISE. - SMOKE ALARMS TO BE INTERCONNECTED WHERE THERE IS MORE THAN ONE AND TO BE MAINS POWERED.

SPOTLIGHT, DOUBLE HEAD

POWERPOINTS, LIGHT SWITCHES, TV POINT, NBN POINT, ETC ARE SHOWN NOMINALLY ONLY AND NUMBERS AND LOCATIONS CAN BE ADJUSTED, AND SHOULD BE CONFIRMED LOCATIONS CAN BE ADJUSTED, AND SHOULD BE CONFIRMED WITH THE OWNER PRIOR TO QUOTING OR INSTALLATION. HOWEVER, IF LIGHT TYPE OR QUANTITY ARE CHANGED THE DESIGNER NEEDS TO BE NOTIFIED SO ARTIFICIAL LIGHTING CALCULATIONS AND COMPLIANCE CAN BE CONFIRMED.

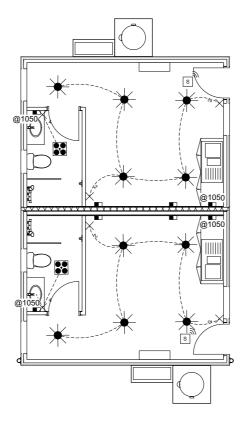

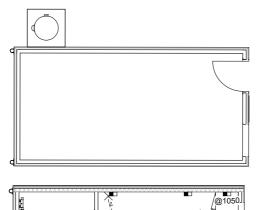

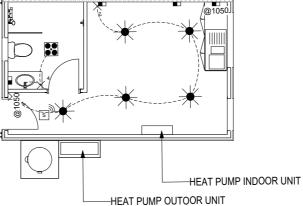

COUNCIL Sorell Council

oment Application: 5.2023.310.1 -ise to Request For Information - 31 Street, Sorell - P2.pdf keference: P2 ceived: 28/04/2025

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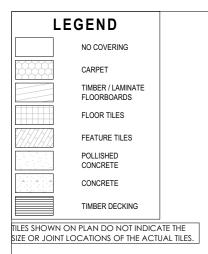
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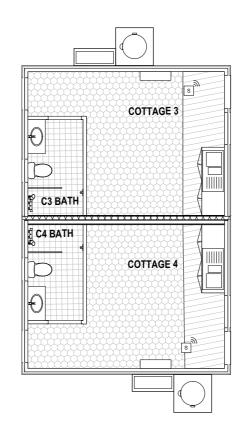



								ALL LAYOUTS ARE TO BE F	PRINTED IN COLOUR
	COTTAGE ELECTRICAL					LAYOUT REV:			
E: chrispooley0@gmail.com	PROPOSED ACCOMODATION	TERRY MCGILL					_	JOB No:	045
BUILDING DESIGNER RAFTING SERVICES ACCREDITATION: 866088099		F	-				_	SCALES(s) @ A3	
G BEING CONSTRUCTED IN A BAL-N/A AREA	DEVELOPMENT APPLICATION	31 WALKER ST, SORELL, TAS 7172		ADDRESS RFI'S (COUNCIL, HERRITAGE)	28.04.2025	ALL C	DP	SHEET No:	A-12
ONS TO, OR ADDITIONAL CONSTRUCTION METHODS/ MAY APPLY - REFER TO NOTES)		<b>CT</b> : 110657 <b>LOT</b> : 1	REV	DEVELOPMENT APPLICATION - INITIAL ISSUE AMENDMENTS	2023.10.16 DATE	SHEET D	RW	No. OF SHEETS:	13


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#### DOWNLIGHTS ARE IC RATED GENERALLY, WITH 90mm DIA CUTOUTS. REFER TO BUILDERS SPECIFICATION FOR SELECTION DETAILS.







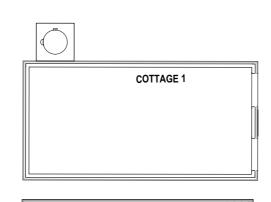
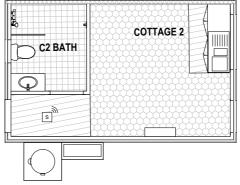
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