

SORELL COUNCIL NOTICE OF PROPOSED DEVELOPMENT

Notice is hereby given that an application has been made for planning approval for the following development:

SITE: 406 Wielangta Road, Bream Creek

PROPOSED DEVELOPMENT:


OUTBUILDING

The relevant plans and documents can be inspected at the Council Offices at 47 Cole Street, Sorell during normal office hours, or the plans may be viewed on Council's website at www.sorell.tas.gov.au until Monday 13th May 2024. Any person may make representation in relation to the proposal/s by letter or electronic mail (sorell.tas.gov.au) addressed to the General Manager. Representations must be received no later than Monday 13th May 2024.

APPLICANT: P & J Sheds Pty Ltd

DATE: 24 April 2024

APPLICATION NO: 5.2024.52.1

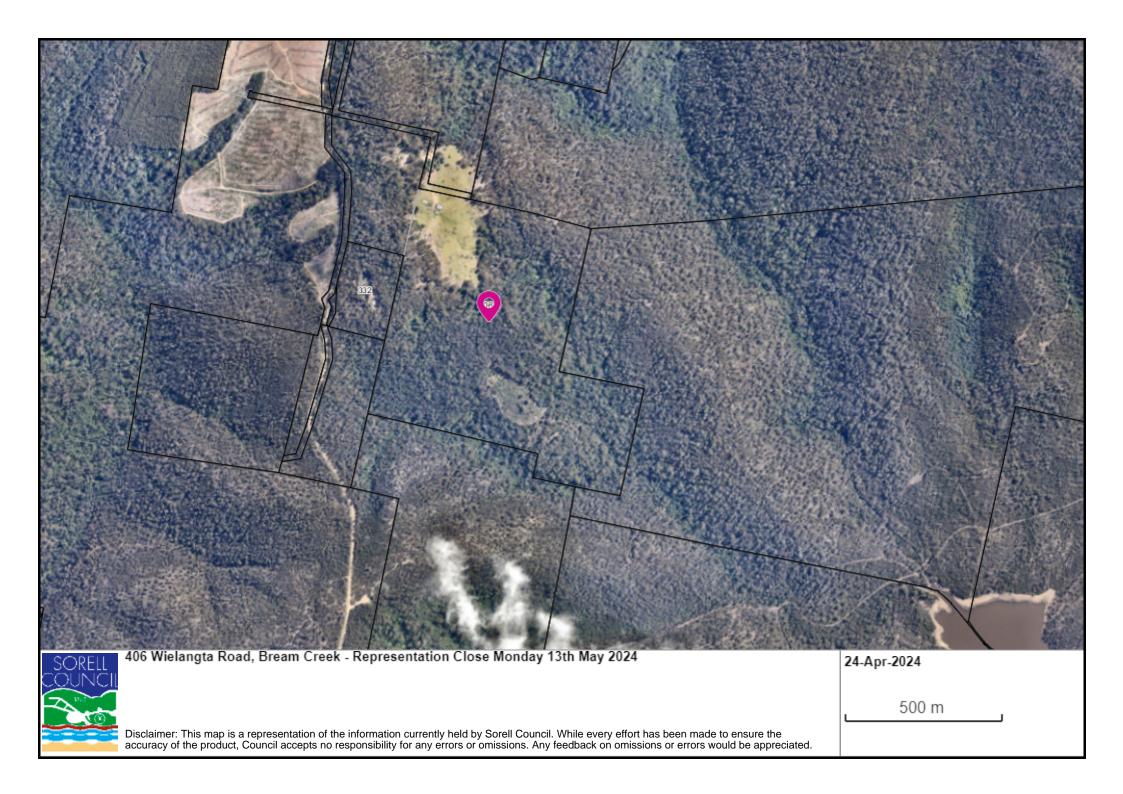

Part B: Please note that Part B of this form is publicly exhibited.

Full description of Proposal:	Use: Outbuilding / Workshop					
	Development: 20m X 10m colorbond outbuilding					
	Large or complex proposals should be described in a letter or planning report.					
Design and cons	\$.	\$ 70,000				
Is all, or some th	: No	o: 🗹	Yes: □			
Location of Street address: 406 Wielangta Road						
proposed Suburb. Bream Creek Postcodo: 7175						
works:	Certificate of Title(s) Volum	7	Folio:			
Current Use of Vacant Land (associated with dwelling on CT 242996 / 2)						
Site	Vacant Land (associated with dwelling on CT 242996 / 2)					
Current Owner/s:	Namo(s)					
Is the Property on the Tasmanian Heritage Register?		No: ☑ Ye	es: 🗖	If yes, please provide written advice from Heritage Tasmania		
Is the proposal to be carried out in more than one stage?		No: ☑ Ye	es: 🗆	If yes, please clearly describe in plans		
Have any potentially contaminating uses been undertaken on the site?		No: ☑ Y€	es: 🗖	If yes, please complete the Additional Information for Non-Residential Use		
Is any vegetation proposed to be removed?		No: ☐ Y€	es: 🗹	If yes, please ensure plans clearly show area to be impacted		
Does the proposal involve land administered or owned by either the Crown		No: ☑ Y€	es: 🗖	If yes, please complete the Council or		
or Council?			ouncil t	Crown land section on page 3		
If a new or upgraded vehicular crossing is required from Council to the front boundary please complete the Vehicular Crossing (and Associated Works) application form						
https://www.sorell.tas.gov.au/services/engineering/						
Development Application: Development						
				Application - 406 Wielangta Road, Bream Creek - P1.pdf Plans Reference:P1 Date Received:19/03/2024		

Declarations and acknowledgements

- I/we confirm that the application does not contradict any easement, covenant or restriction specified in the Certificate of Title, Schedule of Easements or Part 5 Agreement for the land.
- I/we consent to Council employees or consultants entering the site and have arranged permission and/or access for Council's representatives to enter the land at any time during normal business hours.
- I/we authorise the provision of a copy of any documents relating to this application to any person for the purposes of assessment or public consultation and have permission of the copyright owner for such copies.
- I/we declare that, in accordance with s52(1) of the Land Use Planning and Approvals Act 1993, that I have notified the owner(s) of the intention to make this application.
- I/we declare that the information in this application is true and correct.

Details of how the Council manages personal information and how you can request access or corrections to it is outlined in Council's Privacy Policy available on the Council website.

- I/we acknowledge that the documentation submitted in support of my application will become a public record held by Council and may be reproduced by Council in both electronic and hard copy format in order to facilitate the assessment process, for display purposes during public exhibition, and to fulfil its statutory obligations. I further acknowledge that following determination of my application, Council will store documentation relating to my application in electronic format only.
- Where the General Manager's consent is also required under s.14 of the *Urban Drainage Act 2013*, by making this application I/we also apply for that consent.

Applicant Signature:

Signature: Date: 18/03/2024

Crown or General Manager Land Owner Consent

If the land that is the subject of this application is owned or administered by either the Crown or Sorell Council, the consent of the relevant Minister or the Council General Manager whichever is applicable, must be included here. This consent should be completed and signed by either the General Manager, the Minister, or a delegate (as specified in s52 (1D-1G) of the Land Use Planning and Approvals Act 1993).

Please note:

- If General Manager consent if required, please first complete the General Manager consent application form available on our website www.sorell.tas.gov.au
- If the application involves Crown land you will also need a letter of consent.
- Any consent is for the purposes of making this application only and is not consent to undertaken work or take any other action with respect to the proposed use or development.

Ĩ		being responsible for the
administration of land at		
declare that I have given permis	sion for the making of this application for	
		SCHEIL
Signature of General Manager, Minister or Delegate:	Signature:	Sorell Council Development Application: Development

For further information please contact Council on (03) 6269 0000 or email sorell.council@sorell.tas.gov.au Web: www.sorell.tas.gov.au

Plans Reference:P1
Date Received:19/03/2024



Response to request for additional information 5.2024.52.1 AT 406 WIELANGTA ROAD, BREAM CREEK FOR- P & J SHEDS PTY LTD

This document has been prepared in response to a request for additional information regarding the above application.

The information request was for a Natural Values Assessment (NVA) report, as the proposal is partly located within an area mapped as a Priority Vegetation Area, and ground disturbance and clearing of ground vegetation will be required.

1 Summary

Site inspection of the area with a qualified Ecologist (Ecopulse) was undertaken on 20 April 2024, and it is concluded that a NVA is not required for the following reasons:

- The clearance of native vegetation is of limited scale relative to the extent of priority vegetation on the site (per Clause P1.1 of the Natural Assets Code)
- Vegetation to be removed consists of several young (< 10 yrs old) regrowth eucalypt trees (E. regnans and E. obliqua), and a mixture of native and introduced grasses and weeds, rushes, ferns, sedges and groundcover species.
- The seedling and sapling eucalypts to be cleared are smaller than 10cm trunk diameter at 1.5m height, with the exception of one individual *E. regnans* sapling which is approximately 15cm trunk diameter at 1.5m height (see photos overleaf).

Further explanation and site description is provided below to support the conclusion above.

2 Site history

The ground disturbance associated with the proposal is located in an area where until approximately 2012 (previous landowner, *pers. comm*) there had been a shed structure housing a sawmill. Remaining infrastructure and timber debris from this shed is visible in the aerial photo (Figure 1) and terrestrial photos below. Since the demolition and partial removal of the sawmill shed, seedling eucalypts have germinated in the previously cleared and disturbed area, an attained a height in some cases of greater than 2m. An example of the young trees in this area is shown in Figure 3.

3 Mapped vegetation zones vs field validation

Desktop analysis using relevant layers of LISTmap shows that the TasVeg 4.0 layer maps an indicative boundary close to the proposed shed location, the boundary being between DOB Eucalyptus Obliqua Dry Forest and FAG Agricultural Land.

The Planning Scheme Code overlay of Priority Vegetation closely follows the mapped TasVeg 4.0 layer. At the scale of mapping for the LISTmap layers, the area occupied by the proposed shed is very small and less than the resolution of the mapping units. The proposal is located across the southern boundary of a large area of vegetation, and field verification shows that the proposal is located in what is historically cleared area, with none of the mature standing eucalypt forest that is currently growing within 100m of the proposal.

4 Clause C7.6.2 of the Natural Assets Code - Clearance within a priority vegetation area

The Objective of this section of the Natural Assets Code is:

That clearance of native vegetation within a priority vegetation area:

- (a) does not result in unreasonable loss of priority vegetation;
- (b) is appropriately managed to adequately protect identified priority vegetation; and
- (c) minimises and appropriately manages impacts from construction and development activities.

<u>Performance criteria P1.1</u> of Code 7 for this proposal includes the following clause:

Clearance of native vegetation within a priority vegetation area must be for:

(f) the clearance of native vegetation that is of limited scale relative to the extent of priority vegetation on the site.

There is a large area, starting within 50-100m to the north of the proposed shed, containing mature eucalypt forest containing E. obliqua, E. regnans and E. globulus. The proposed shed sits in an area that has been historically cleared and used for sawmill infrastructure. This zone now contains regenerating young forest and cleared areas, and is a boundary zone between the mature forest and currently cleared areas.

The proposed shed is right on the boundary of the mapped priority vegetation area, and Figure 2 below shows the context of the proposed clearing relative to the large extent of priority vegetation adjacent to the proposal.

<u>Performance criteria P1.2</u> of Code 7 for this proposal includes several relevant clauses, which are listed below together with the response for this proposal.

Clearance of native vegetation within a priority vegetation area must minimise adverse impacts on priority vegetation, having regard to:

P1.2 performance criteria		Proposal response	
(a)	the design and location of buildings and works and any constraints such as topography or land hazards;	The proposed shed has been located adjacent to existing cleared access, and to minimise the requirement for cut and fill.	
(d)	any mitigation measures implemented to minimise the residual impacts on priority vegetation;	Remaining debris from the pre-existing sawmill will be removed from the surrounding area, enabling continued regeneration of the priority vegetation.	
(f)	any existing cleared areas on the site.	Ground disturbance and spoil disposal will be restricted to existing cleared areas on site.	

5 Figures

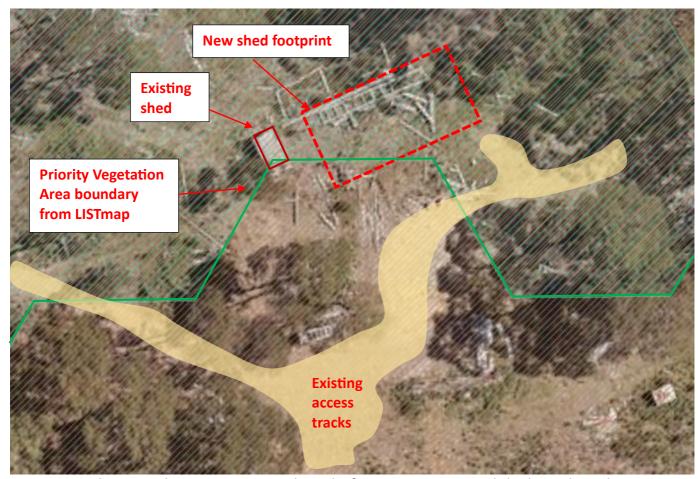


Figure 1: Site location, showing existing tracks and infrastructure, proposed shed, PVA boundary.



Figure 2: Proposed scale relative to mapped PVA layer (LISTmap) extent (shed scale approximate).

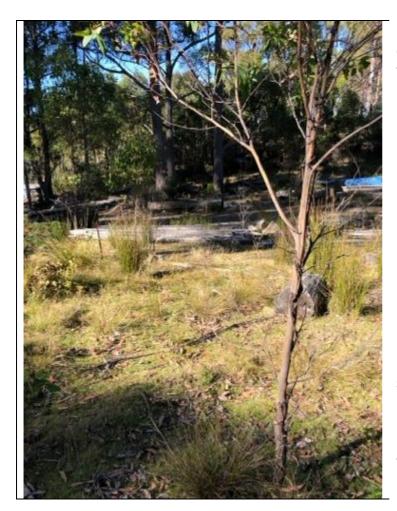


Figure 3 (left): Example of sapling eucalypt within proposed shed footprint.

Figure 4 (below): view of proposed shed site with approximate boundary lines marked. Note mature forest trees in background, and debris from previous sawmill structure in foreground.





Figure 5: Single *E. regnans* sapling within footprint with trunk diameter larger than approximately 10cm at 1.5m height.



Figure 6: View along north boundary of shed footprint. Note remnants of infrastructure from sawmill. E. regnanse sapling within the footprint is circled. Eucalpyt to the left of the pink peg in foreground is not within footprint.

NEW OUTBUILDING / WORKSHOP 406 WIELANGTA ROAD, BREAM CREEK, 7175 FOR M. UNDERWOOD & C. GIUDICI

CERTIFICATE OF TITLE: VOLUME - 103427 FOLIO - 1

PID: 2013729 LAND AREA: 8.912ha

PLANNING SCHEME: TASMANIAN PLANNING SCHEME

SORELL LOCAL PROVISIONS SCHEDULE

ZONE: 20. RURAL

OVERLAYS: LOW LANDSLIP HAZARD BAND

MEDIUM LANDSLIP HAZARD BAND

WATERWAY AND COSTAL PROTECTION AREA

PRIORITY VEGETATION AREA

SOIL CLASSIFICATION: ASSUMED M

WIND REGION: A

TERRAIN CATEGORY: TC3

IMPORTANCE LEVEL: 2 (DOMESTIC)

SHIELDING: I TOPOGRAPHY: I.I

BAL: NOT REQUIRED (CLASS I OA STRUCTURE NOT WITHIN 6m OF DWELLING)

INDEX OF DRAWINGS - BY ADRIAN BROWN CC6003R

PAGE I - SITE PLAN 1:2000

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PAGE 6 - PLUMBING PLAN 1:100

ADDITIONAL DRAWINGS / ENGINEERING BY NORTHERN CONSULTING ENGINEERS


JOB NO - 71667





- AREA SHOWN ON LOCATION PLAN AT 1:500



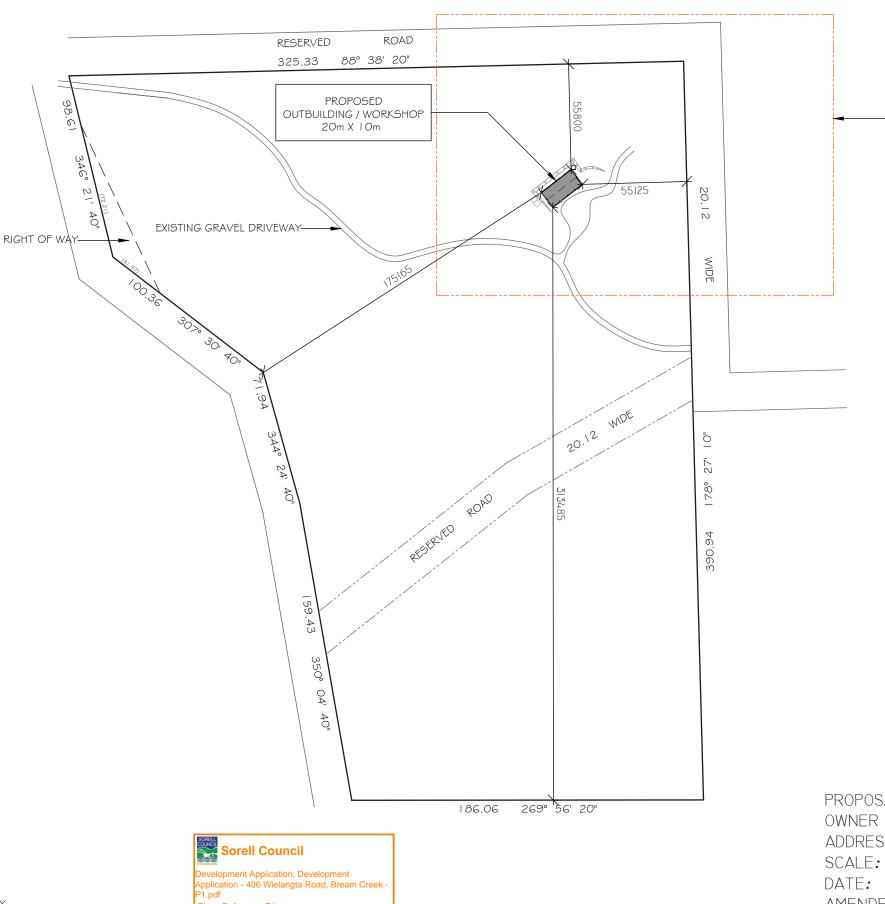

VOL: 103427 FOLIO: 1 8.912ha (not including reserve road)

SITE PLAN PREPARED FROM CERTIFICATE OF TITLE INFORMATION AND MEASUREMENTS TAKEN ON SITE. CONFIRMATION OF BOUNDARY LOCATION BY REGISTERED SURVEYOR IS ALWAYS RECOMMENDED PRIOR TO CONSTRUCTION AND IS THE RESPONSIBILITY OF THE PROPERTY OWNER.

SITE PLAN 1:2000

PROPOSAL : NEW OUTBUILDING / WORKSHOP

OWNER: M. UNDERWOOD & C. DIUDICI ADDRESS: 406 WIELANGTA ROAD, BREAM CREEK, 7175

1:2000

DATE: 14th MARCH 2024

AMENDED:

DRAWN BY: A. BROWN CC6003R


JOB NO:

Plans Reference:P1 Date Received:19/03/2024

OF THE PROPERTY OWNER.

ROAD RESERVED

WIDE 20.12

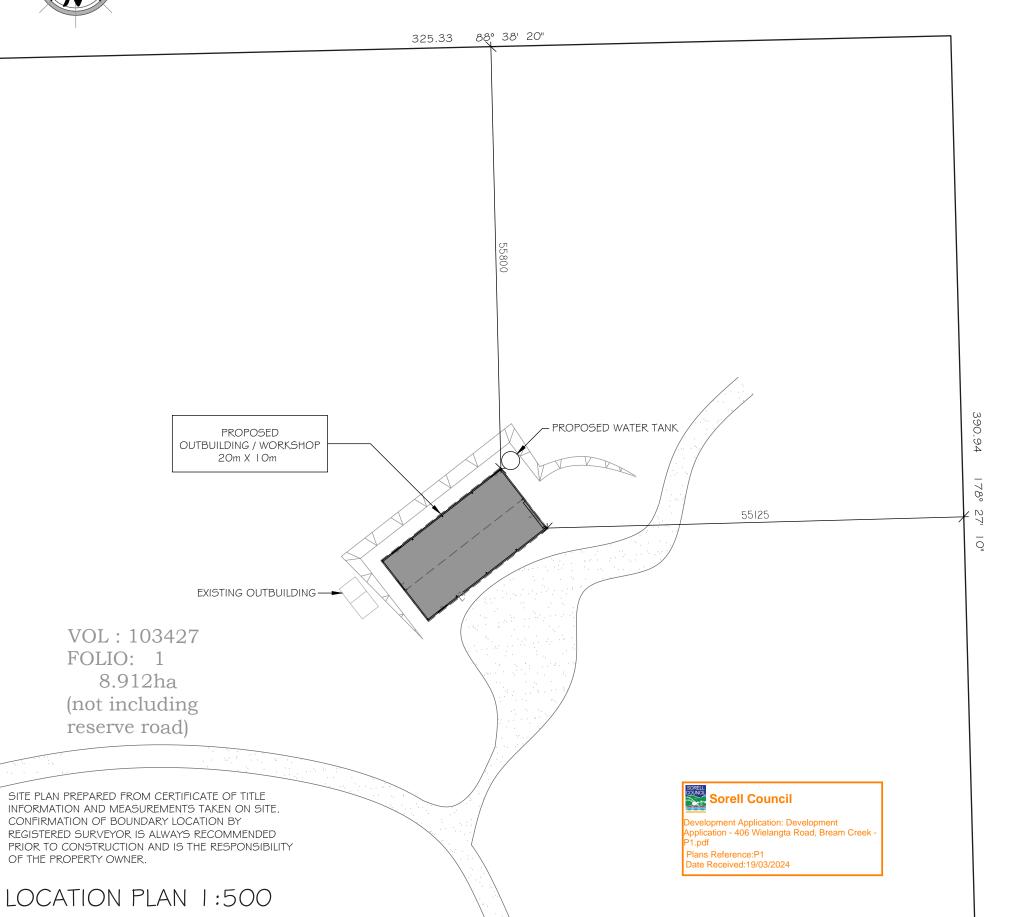

LOT AREA: 8.912ha EXISTING OUTBUILDING:

PROPOSED OUTBUILDING / WORKSHOP AREA: 200m²

PROPOSAL: NEW OUTBUILDING / WORKSHOP

OWNER: M. UNDERWOOD & C. DIUDICI

ADDRESS: 406 WIELANGTA ROAD, BREAM CREEK, 7175

SCALE: 1:500

DATE: 14th MARCH 2024


AMENDED:

DRAWN BY: A. BROWN CC6003R

PAGE: 02/06 JΦB NO : 71667




P&J SHEDS PTY LTD. 38 McIntyre Street, Mornington, TAS, 7018. P: (03) 62 44 4300 F: (03) 6244 4355 E: admin@fairdinkumhobart.com.au ABN: 45109681263 THIS DRAWING IS THE PROPERTY OF P&J SHEDS. © 2024

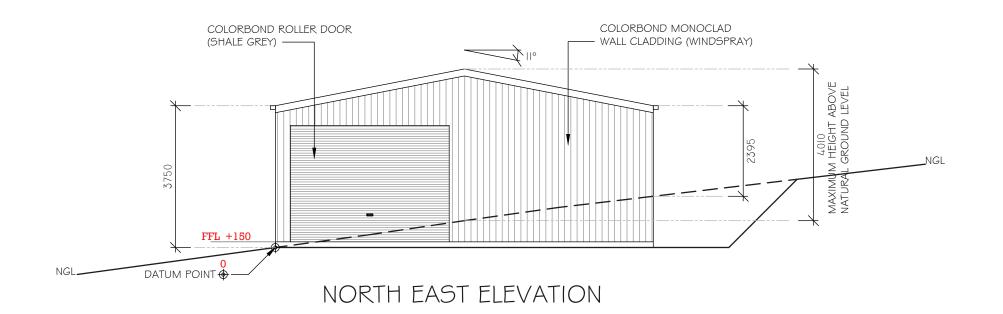

COLOUR'S (COLORBOND®):

EXT. WALLS - WINDSPRAY
ROOF - WALLABY
ROLLER DOOR - SHALE GREY
PA DOOR - SHALE GREY
WINDOW FRAME - WALLABY
GUTTER - WALLABY
CORNER FLASH - WINDSPRAY
BARGE FLASHING - WALLABY

OPENING FLASH - WALLABY

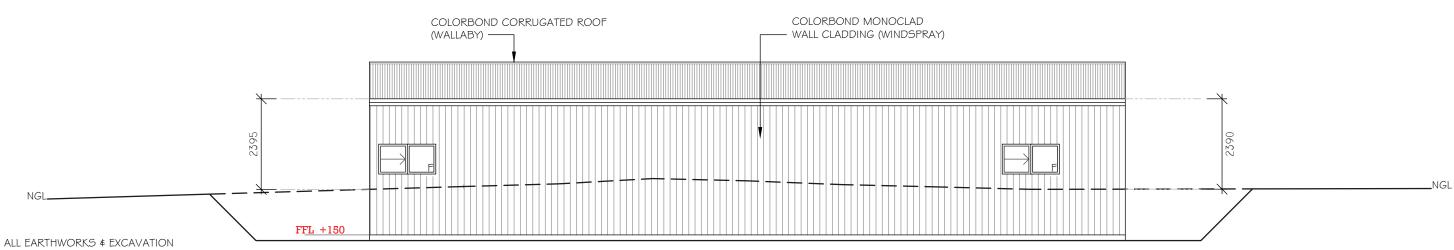

ALL EARTHWORKS & EXCAVATION TO BE IN ACCORDANCE WITH PART 3.2 OF NCC 2022.

UN-RETAINED EMBANKMENT SLOPES (CUT / FILL)
TO BE IN ACCORDANCE WITH TABLE 3.2. I
OF NCC 2022

NORTH WEST ELEVATION

Development Application: Development Application - 406 Wielangta Road, Bream Creek P1.pdf
Plans Reference:P1
Date Received:19/03/2024

ALL HEIGHTS SHOWN ARE ABOVE NATURAL GROUND LEVEL.

ACTUAL HEIGHTS OF WALLS ABOVE CONCRETE SLAB ARE: SIDE WALL HEIGHT - 3600mm
END WALL HEIGHT TO APEX - 4572mm

SCALE:

DATE: 14th MARCH 2024

1:100

AMENDED:

DRAWN BY: A. BROWN CC6003R


PROPOSAL: NEW OUTBUILDING / WORKSHOP

ADDRESS: 406 WIELANGTA ROAD, BREAM CREEK, 7175

OWNER: M. UNDERWOOD & C. DIUDICI

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ELEVATIONS 1:100

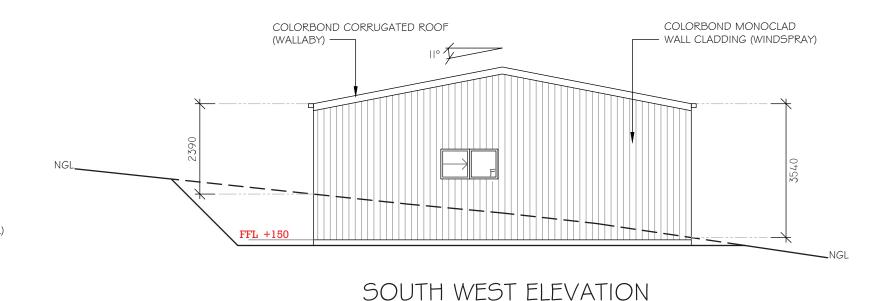


ALL EARTHWORKS & EXCAVATION TO BE IN ACCORDANCE WITH PART 3.2 OF NCC 2022.

UN-RETAINED EMBANKMENT SLOPES (CUT / FILL) TO BE IN ACCORDANCE WITH TABLE 3.2. I OF NCC 2022

COLOUR'S (COLORBOND®):

EXT. WALLS - WINDSPRAY
ROOF - WALLABY
ROLLER DOOR - SHALE GREY
PA DOOR - SHALE GREY
WINDOW FRAME - WALLABY
GUTTER - WALLABY
CORNER FLASH - WINDSPRAY
BARGE FLASHING - WALLABY

OPENING FLASH - WALLABY

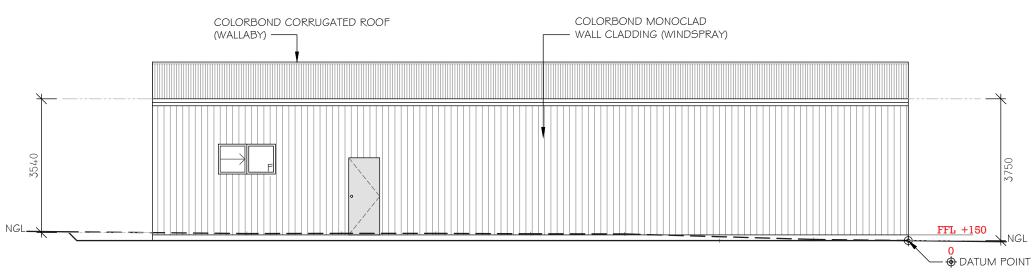

SOUTH EAST ELEVATION



ALL HEIGHTS SHOWN ARE ABOVE NATURAL GROUND LEVEL.

ACTUAL HEIGHTS OF WALLS ABOVE CONCRETE SLAB ARE: SIDE WALL HEIGHT - 3600mm
END WALL HEIGHT TO APEX - 4572mm

PROPOSAL: NEW OUTBUILDING / WORKSHOP

OWNER: M. UNDERWOOD & C. DIUDICI
ADDRESS: 406 WIELANGTA ROAD, BREAM CREEK, 7175

SCALE: 1:100

DATE: 14th MARCH 2024

AMENDED:

DRAWN BY: A. BROWN CC6003R

PAGE: 04/06 JOB NO: 71667




WINDOW & DOOR SCHEDULE

ALL EARTHWORKS & EXCAVATION TO BE IN ACCORDANCE WITH PART 3.2 OF NCC 2022.

UN-RETAINED EMBANKMENT SLOPES (CUT / FILL) TO BE IN ACCORDANCE WITH TABLE 3.2. I OF NCC 2022

HEIGHT 790mm 1510mm WINDOWS 790mm 1510mm W2 790mm 1510mm WЗ W4 790mm 1510mm ACCESS DOOR PΑ 2040mm 820mm ROLLER DOOR RDI 3000mm 3100mm 2500mm 27 I Omm

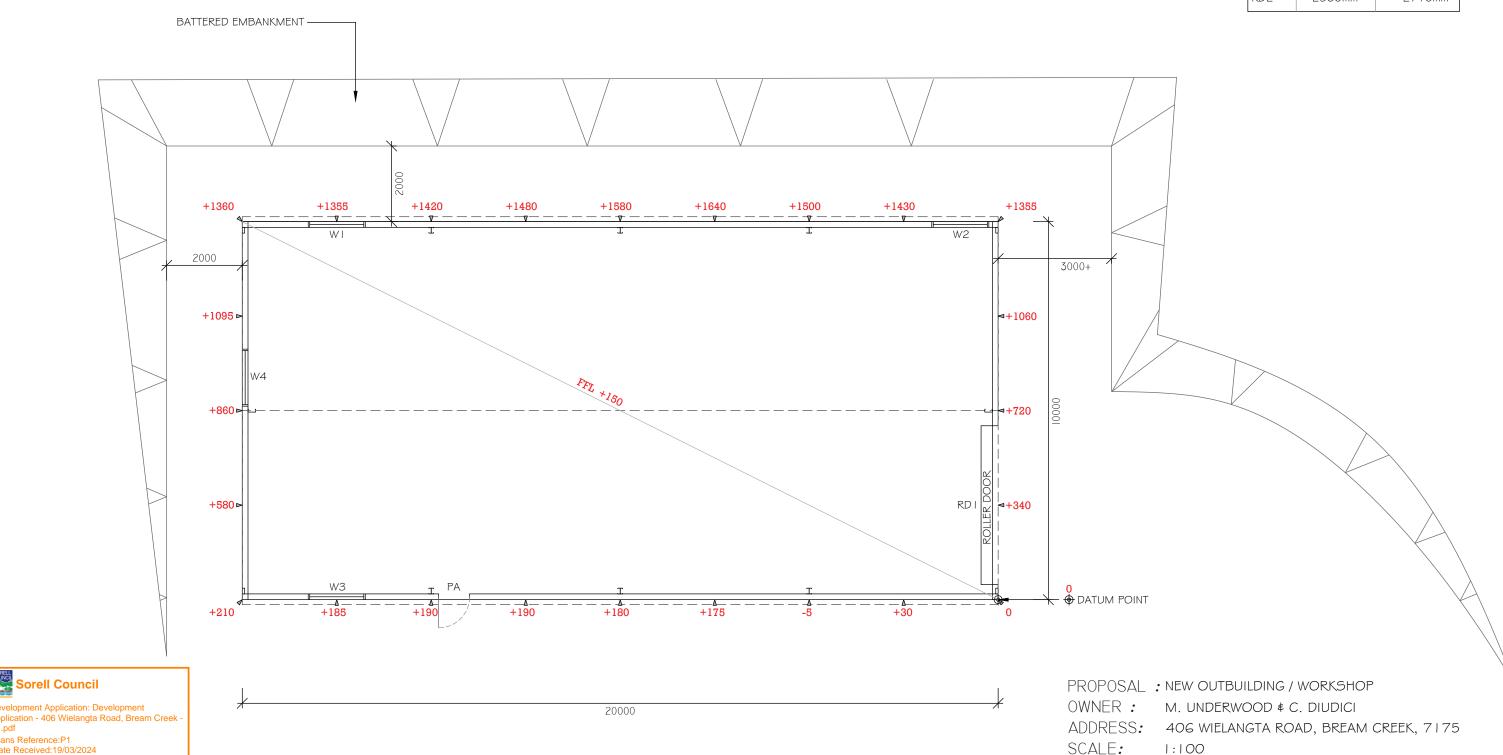

FLOOR PLAN 1:100

ate Received:19/03/2024

DRAWN BY: A. BROWN CC6003R PAGE:

14th MARCH 2024

05/06 JOB NO: 71667

DATE:

AMENDED:



CONSTRUCTION GENERALLY:

ALL CONSTRUCTION TO BE IN ACCORDANCE WITH CURRENT BUILDING REGULATIONS, BUILDING CODE OF AUSTRALIA (B.C.A.), RELEVANT AUSTRALIAN STANDARDS AND LOCAL AUTHORITY REQUIREMENTS.

SITE PREPARATION AND EXCAVATION TO COUNCIL AND B.C.A REQUIREMENTS.

CONCRETE FOOTINGS TO AS 2870. I AND ENGINEER SPECIFICATIONS. UNLESS OTHERWISE SPECIFIED, FOOTINGS 20MPA / SLAB 25MPA.

STRUCTURAL; DETAILS AND CERTIFICATION AS PER 'FAIR DINKUM SHEDS' DOCUMENTATION.

BUILDER TO VERIFY ALL DIMENSIONS AND DETAILS ON THIS SET OF PLANS PRIOR TO COMMENCEMENT OF WORK ON SITE.

USE WRITTEN DIMENSIONS IN PREFERENCE TO MEASURING OFF THE PLAN.

COUNCIL / CONTRACTOR TO CONTACT P\$J SHEDS IF NECESSARY INFORMATION IS NOT PROVIDED ON THIS SET OF PLANS.

PLUMBING GENERALLY:

ALL PLUMBING TO BE IN ACCORDANCE WITH AS 3500.
TAS PLUMBING CODE AND LOCAL AUTHORITY REQUIREMENTS.

I OOdIa UPVC STORM WATER TO NEW WATER TANK, OVERFLOW TO GROUND. PLUMBER TO VERIFY CONNECTION LOCATION WITH OWNER.

FIRST INSPECTION OPENING TO BE RAISED TO FINISHED GROUND LEVEL.

OVERFLOW TO GROUND IN DIRECTION AWAY FROM OUTBUILDING

PROPOSAL: NEW OUTBUILDING / WORKSHOP

OWNER: M. UNDERWOOD & C. DIUDICI

ADDRESS: 406 WIELANGTA ROAD, BREAM CREEK, 7175

SCALE: 1:100

DATE: 14th MARCH 2024

AMENDED:

DRAWN BY: A. BROWN CC6003R

PAGE: 06/06 JOB NO: 71667

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